

DRAWING INDEX

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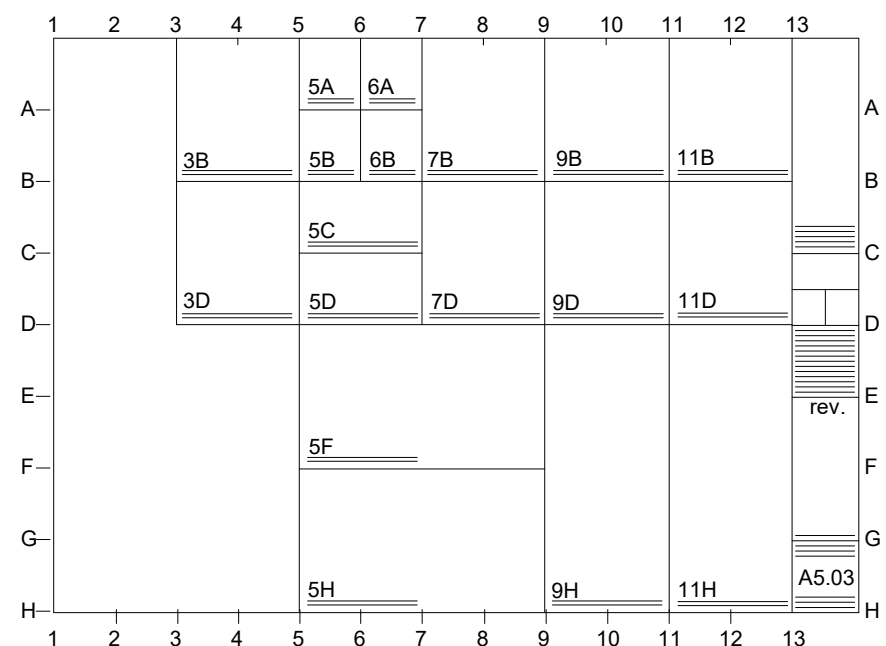


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DATE: 12-04-2023 PROJECT NUMBER:0054

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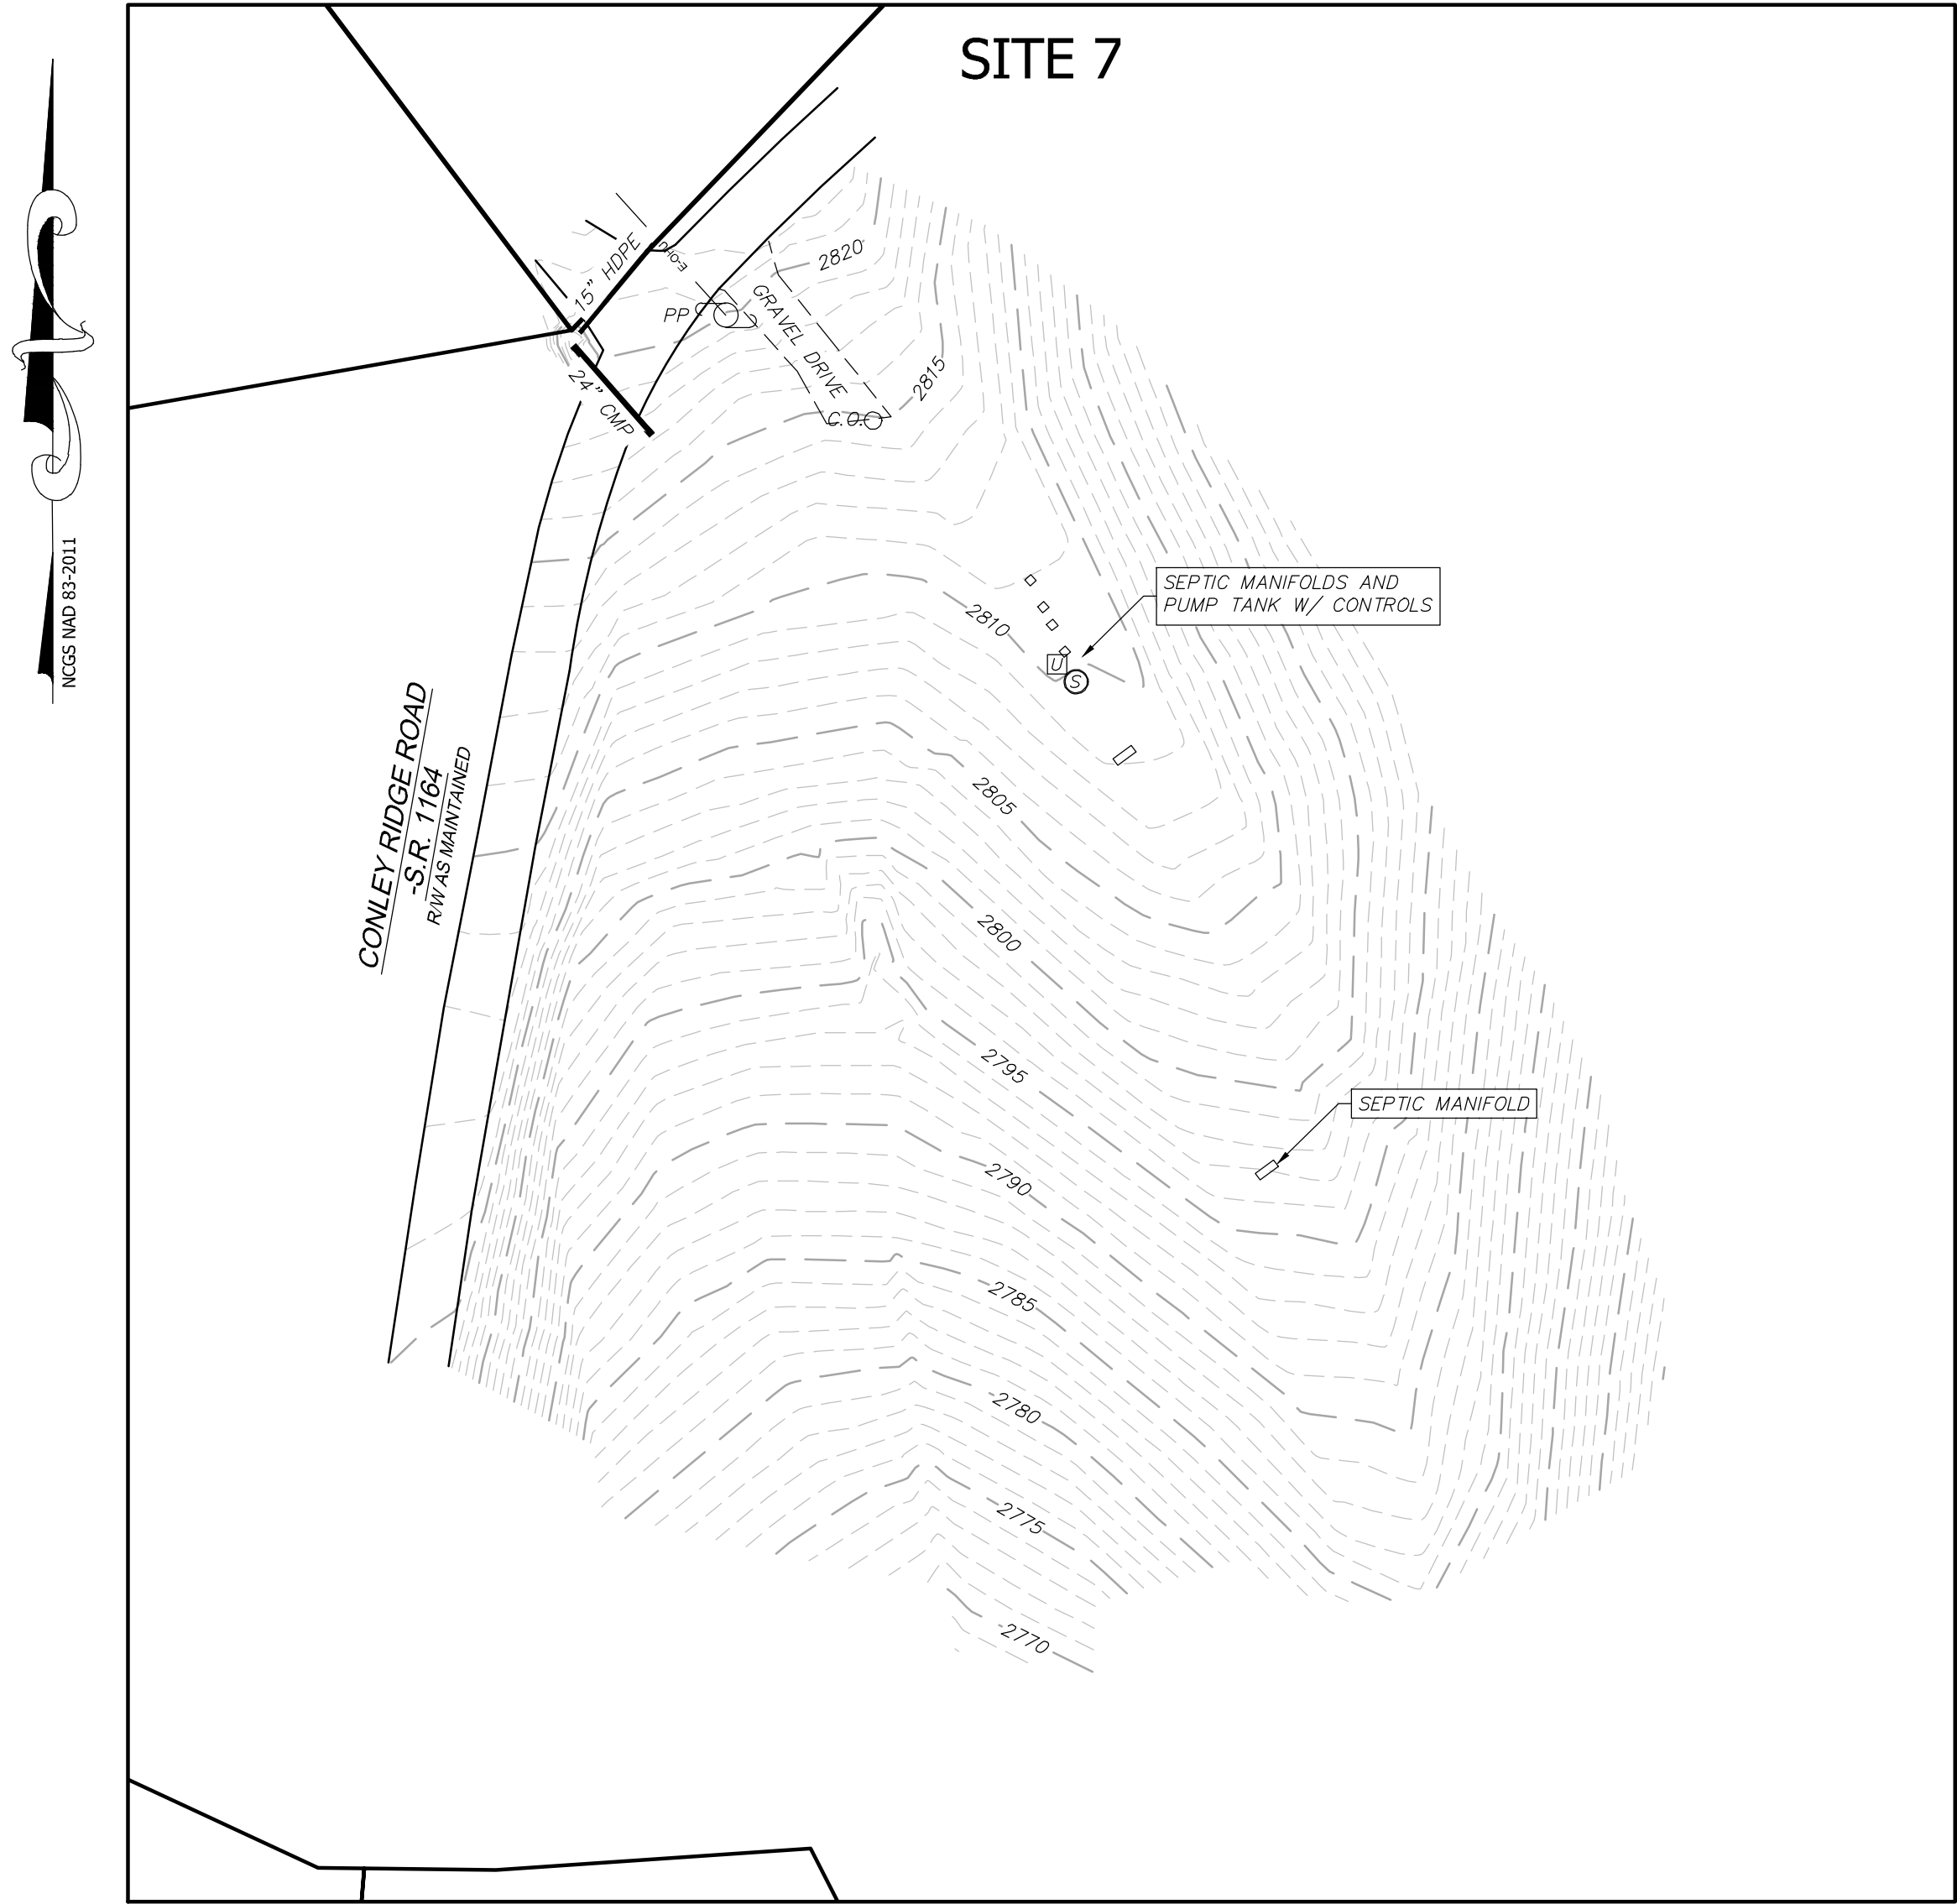
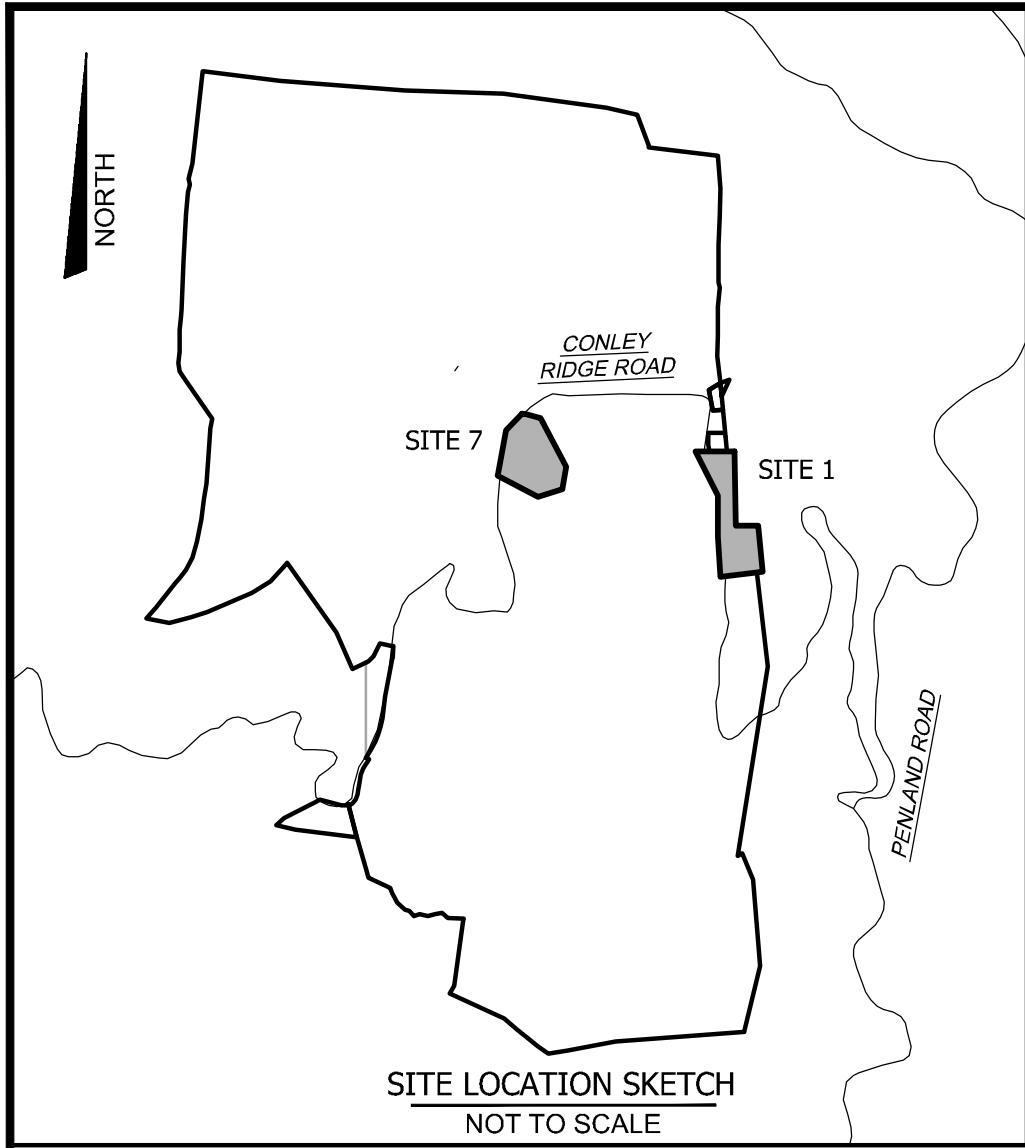
DETAIL REFERENCE



DETAILS ARE REFERENCED ACCORDING TO THEIR POSITION ON THE DRAWING SHEET. THE SYSTEM IS SIMILAR TO THAT OF A MAP. THE DRAWING SHEET IS DIVIDED INTO A GRID WITH LETTERS ON THE SIDES AND NUMBERS GOING ACROSS AS SHOWN ABOVE. FOR EXAMPLE DETAIL 9D A5.03 WOULD BE FOUND AT THE INTERSECTION OF LINES 9 AND ON SHEET A5.03

ABBREVIATIONS

and	C.H.	ceiling height	E.C.	electrical contractor	H.B.	hose bibb	MAX.	maximum	Q.T.	quarry tile	SUSP.	suspended
angle	C.I.	cast iron	E.J.	expansion joint	H.C.	hollow core	MBR.	member	R.	riser, radius	SW.	switch
at	C.J.	control joint or construction joint	E.W.C.	electric water cooler	H.M.	hollow metal	MECH.	mechanic (al)	R.A.	return air	SYM.	symmetry (ical)
centerline	C.M.T.	ceramic mosaic tile	E.A.	each	H.P.	horsepower	MED.	medium	R.C.P.	reinforced concrete pipe	T&B.	top and bottom
channel	C.M.U.	concrete masonry unit	ELAS.	elastomeric	H.D.W.	hardware	MEMB.	membrane	R.O.	roof drain	T&G.	tongue and groove
diameter or round	C.T.	ceramic tile	ELEC.	electric (al)	H.W.D.	hardwood	MTL.	metal	R.H.	right hand	T.	tread
perpendicular	C. to C.	center to center	ELEV.	elevator, elevation	HORIZ.	horizontal	MEZZ.	mezzanine	R.O.	rough opening	T.C.	top of curb
plate	CAB.	cabinet	EMER.	emergency	HT.	height	MFRG.	manufacture (er)	R.O.W.	right of way	T.P.	top of pavement
pound or number	CARP.	carpet	ENCL.	enclose (ure)	HVAC.	heating/ventilating /air conditioning	MIN.	minimum	REBAR.	reinforcing bar	T.P.D.	toilet paper dispenser
	CEM.	cement	ENTR.	entrance	HWY.	highway	MOD.	modified	REC.	recessed	T.W.	top of wall
	CER.	ceramic	EQ.	equal			MTD.	mounted	RECT.	rectangular	TEL.	telephone
	CLG.	ceiling	EQUIP.	equipment	I.P.S.	iron pipe size	MUL.	mullein	REF.	reference	TEMP.	tempered or temperature
	CLO.	closet	ESTB.	establish	ID.	inside diameter	N.	north	REFRIG.	refrigerator	TERZ.	terrazzo
	CLR.	clear	EXP.	expansion	IN.	inches	N.I.C.	not in contract	REG.	register	THK.	thick (ness)
	CNTR.	counter	EXTG.	existing	INCL.	include (ed) (sion)	N.T.S.	not to scale	REINF.	reinforced	THRES.	threshold
	COL.	column	EXT.	exterior	INSUL.	insulation (ed)	NO. or #	number	REQ.	required	TLT.	toilet
	COMP.	composition			INTR.	interior	NOM.	nominal	RESIL.	resilient	TV.	television
	CONC.	concrete			INV.	invert			RET.	return	TYP.	typical
	CONF.	conference			INV. EL.	invert elevation	O. to O.	out to out	REF.	refrigerator	UNFIN.	unfinished
	CONN.	connection			INT.	interior	O.C.	on center (s)	RFG.	roofing	UTIL.	utility
	CONSTR.	construction			JAN.	janitor	OFF.	office	RM.	room		
	CONT.	continuous			JT.	joint	O.H.	opposite hand	S.P.	single-ply	V.B.	vinyl base
	ADJ.	adjustable or adjustable			K.D.	kiln dried or knock down	OPNG.	opening	S.	solid core	V.C.T.	vinyl composition tile
	AGG.	aggregate			KIT.	kitchen	OPP.	opposite	S.C.J.	structural control joint	V.I.F.	verify in field
	ALU.	aluminum			KO.	knockout	OUT.	outvert	S.C.J.	soap dispenser or storm drain	V.F.	vinyl fabric
	ALT.	alternate			L.	left, length	OZ.	ounce	S.D.	sanitary napkin dispenser	V.F.	vinyl fabric
	ANOD.	anodize			L.H.	left hand	P.C.	plumbing contractor	S.N.D.	sanitary napkin dispenser	V.W.F.	vinyl wall fabric
APPROX.	APPROX.	approximate			L.L.	live load	P.C.F.	pounds per cubic foot	S.N.R.	sanitary napkin receptacle	VENT.	ventilating
AUT.	AUT.	automatic			FLASH.G.	flashing	P.L.F.	pounds per linear foot	S.S.	stainless steel	VERT.	vertical
AUT.	AUT.	automatic			FLU.	fluorescent (light)	P.L.M.	plastic laminate	S.T.C.	sound transmission classification	VEST.	vestibule
AUT.	AUT.	automatic			FRPF.	fireproof (ing)	P.S.F.	pounds per square foot	S.U.	surface 4 sides	VOL.	volume
B.U.R.	B.U.R.	built-up roofing			F.P.W.H.	freeze proof wall hydrant	P.S.I.	pounds per square inch	S4S.	squared 4 sides	W.	west, women
BE.	BE.	board			FT.	foot or feet	P.T.D.	paper towel dispenser (d)	SAN.	sanitary	W.C.	water closet
BD.	BD.	beveled			FURN.	furnish	P.T.R.	paper towel receptacle	SCHED.	schedule	W.F.	wide flange
BTUM.	BTUM.	diffuser			FUR.	furring	P.T.	pressure treat (ed)	SECT.	section	W.I.	wrought iron
BLDG.	BLDG.	building			FURR.	furring	TLT.	lighting	SFTWD.	softwood	W.W.F.	welded wire fabric
BLK.	BLK.	block			FUT.	future	PLYWD.	plywood	SH.	sheet	WD.	wood
BLKG.	BLKG.	blocking			F.V.	face verify	PLN.	panel	SIM.	similar	WDW.	window
BM.	BM.	beam or bench mark			G.B.	grab bar	PNT(d).	paint (ed)	SPEC.	specification	WO.	without
BRG.	BRG.	bracing			G.C.	general contractor	PR.	pair	SQ.	square	WO.	wood
BRCS.	BRCS.	bracing			GA.	gauge, gauge	PT.	point	SQ. FT.	square foot	WDW.	window
CRG.	CRG.	bearing			GALV.	galvanized	PTDR.	combination paper towel dispenser & receptacle	STD.	standard	WSC.	wainscot
DN.	DN.	down			GL.	glass, glazing	PTN.	partition	STL.	steel	WT.	weight
BSMT.	BSMT.	basement			GR.	grade	STC.	structure (al)	STOR.	storage	YD.	yard
BTW.	BTW.	between			GYP.	gypsum	STR.	structure (al)	SURF.	surface		
C.B.	C.B.	catch basin			GL.	glass	PVT.	pavement				



LEGEND	
	PROPERTY LINE
	RIGHT-OF-WAY
	BUILDING
	PAVEMENT
	EDGE OF GRAVEL
	WALL
	STORMWATER PIPE (AS NOTED)
	OVERHEAD UTILITY LINE
	MONUMENT FOUND
	REBAR FOUND
	IRON PIPE FOUND
	WELL
	SEPTIC TANK LID
	SEWER CLEANOUT
	UTILITY PEDESTAL AS NOTED
	ELECTRICAL TRANSFORMER
	POWER POLE
	GAS TANK

BOTH INSETS
SCALE 1"=50'



PROJECT#: 600523


MAP NOTES:

1. This map is does not represent a full boundary survey and should not be used for the conveyance of property. Refer to deeds and plats of record
2. The purpose of this map is to show existing conditions at each Site as shown at the time of the survey.
3. By graphic determination, the Subject Parcels are located in "Zone X" per FIRM map number 3710087100J dated February 4, 2009.
4. Underground utilities were not marked at the time of the survey. Above ground utilities are located based on visible, above ground structures.
5. Property subject to all easements, rights-of-way and restrictions of record.
6. This plat was prepared without the benefit of a title report which may reveal additional conveyances, easements, rights-of-way or building restrictions. A North Carolina licensed attorney-at-law should be consulted.


GLOBAL POSITIONING SYSTEM CERTIFICATION (NC VRS-RTK)

I, Troy A. Shriver, certify that this map was drawn under my supervision from an actual GPS survey made under my supervision and the following information was used to perform the survey:

1. Class of Survey: Class A Survey
2. Positional Accuracy (95% Confidence): 0.03' Horizontal
0.06' Vertical
3. Type of GPS Field Procedure: NC VRS-RTK Network Solutions
Using Carlson BRx7 System
4. Date of Observations: 10-31-23 through 11-1-23
5. Datum/Epoch: NAD83/Epoch 2011

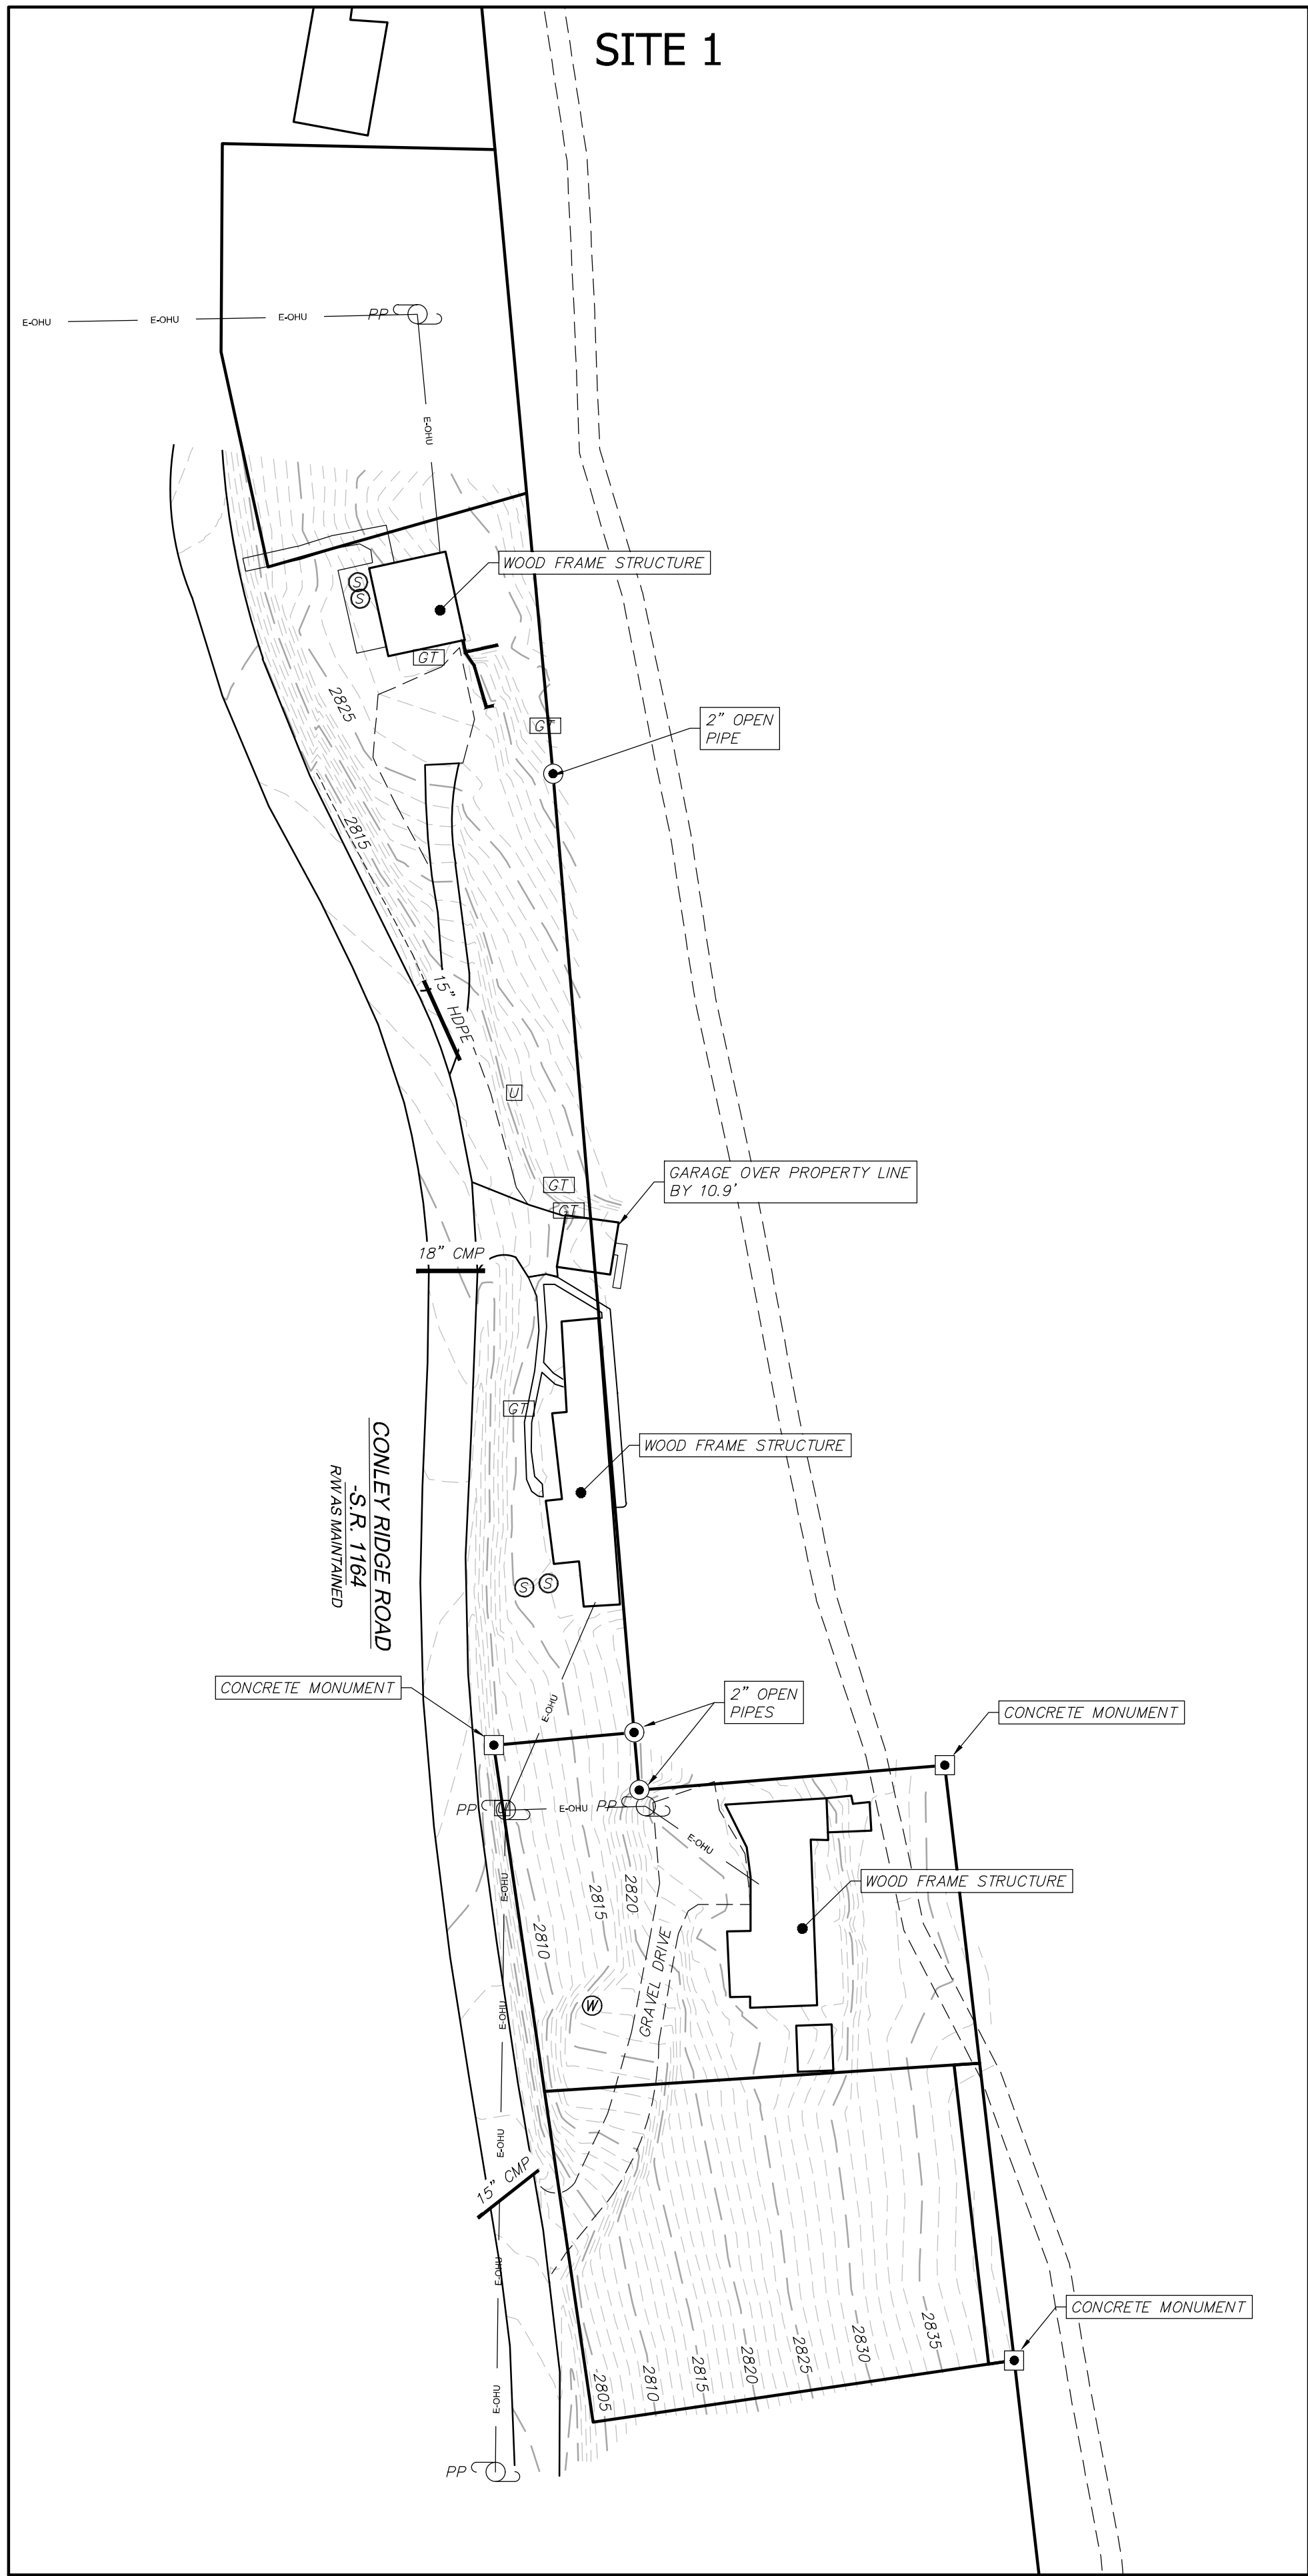

Project No: 600523	REVISIONS/SUBMISSIONS		Date
	No.	RECORD DRAWING	
E-1	1		11-21-23
		RECORD DRAWING	
Designed: ***		Reviewed: PES	15 Arlington Street Asheville, N.C. 28801 Phone: 1-828-232-4700 Fax: 1-828-232-1331 www.brookseaa.com
Drawn: TAS		Scale: AS NOTED	
Checked: ***		Date: 11-21-23	
PENLAND SCHOOL OF CRAFT		NORTH CAROLINA	
STUDENT HOUSING EXPANSION		MITCHELL COUNTY	
EXISTING CONDITIONS		Planning • Engineering • Surveying • Environmental Services •	

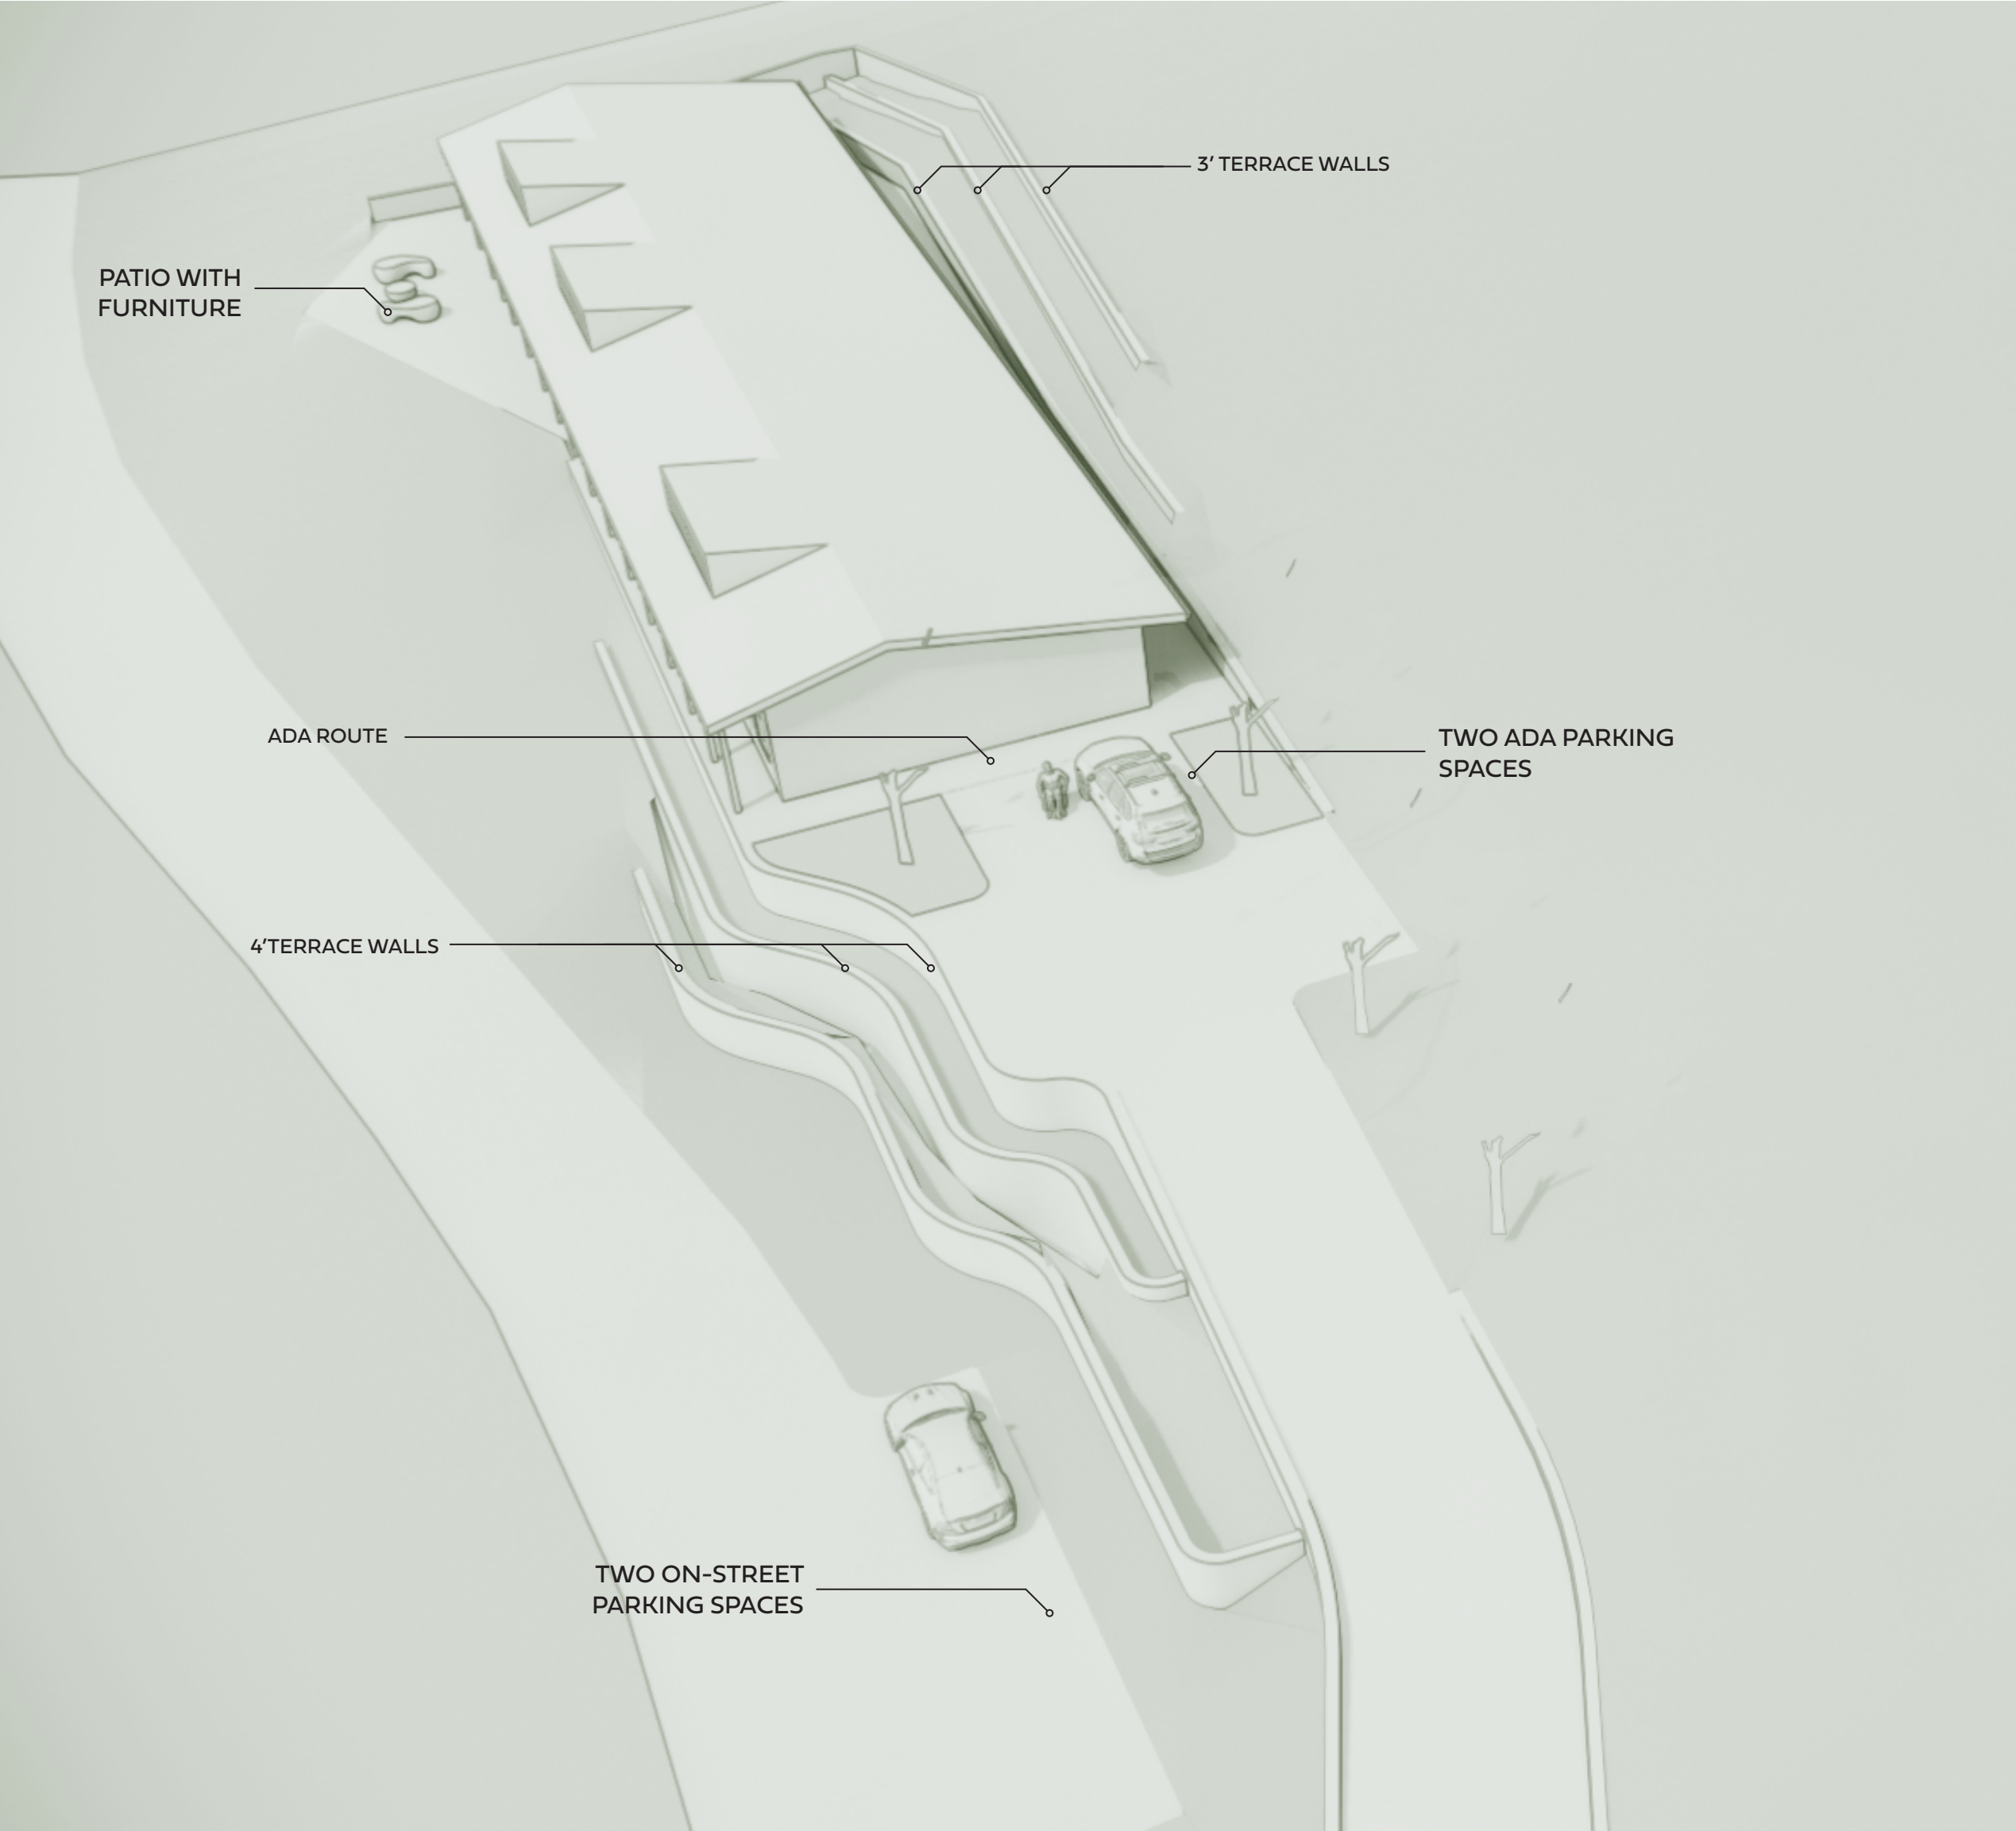

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Penland Instructor Housing North PENLAND, NC

SCHEMATIC DESIGN

Revisions		
No.	Description	Date

date: 12/4/2023
commission: 0054

sheet title:
SITE PLAN

sheet no.:
L1.00

2018 APPENDIX B
BUILDING CODE SUMMARY FOR ALL COMMERCIAL PROJECTS
(EXCEPT 1 AND 2-FAMILY DWELLINGS AND TOWNHOUSES)
(Reproduce the following data on the building plans sheet 1 or 2)

Name of Project: Penland Housing (Instructor Housing North)
Address: Conley Ridge Road, Bakersville, NC Zip Code: 28705
Owner/Authorized Agent: Matt Moore Phone # (410) 409 - 4322 E-Mail: facilitiesdr@penland.com
Owned By: ☐ City/County ☒ Private ☐ State
Code Enforcement Jurisdiction: ☒ City Winston-Salem ☐ County Winston-Salem ☐ State

CONTACT:

DESIGNER	FIRM	NAME	LICENSE #	TELEPHONE #	E-MAIL
Architectural	STITCH design shop	Ben Schwab	12655	(336) 701-0130	ben@stitchdesignshop.com
Civil	Brooks Engineering Assoc.	Mark Brooks		(828) 252-4700	mrbrooks@brookseng.com
Electrical				()	
Fire Alarm				()	
Plumbing				()	
Mechanical				()	
Sprinkler-Standpipe				()	
Structural				()	
Retaining Walls >5' High				()	
Other	MJD Landscape Architect	Ben Monette		(215) 285-9628	benmon@mjdlandscape.com

(*Other* should include firms and individuals such as truss, precast, pre-engineered, interior designers, etc.)

2018 NC BUILDING CODE: ☒ New Building ☐ Addition ☐ Renovation
☐ 1st Time Interior Completion
☐ Shell/Core - Contact the local inspection jurisdiction for possible additional procedures and requirements
☐ Phased Construction - Shell/Core-Contact the local inspection jurisdiction for possible additional procedures and requirements

2018 NC EXISTING BUILDING CODE: EXISTING: ☐ Prescriptive ☐ Repair ☐ Chapter 14
Alteration: ☐ Level I ☐ Level II ☐ Level III ☐ Change of Use
☐ Historic Property

CONSTRUCTED: (date) _____ CURRENT OCCUPANCY(S) (Ch. 3):
RENOVATED: (date) _____ PROPOSED OCCUPANCY(S) (Ch. 3): Residential R-1
RISK CATEGORY (Table 1604.5): Current: ☐ I ☐ II ☐ III ☐ IV
Proposed: ☐ I ☒ II ☐ III ☐ IV

BASIC BUILDING DATA

Construction Type: ☐ I-A ☐ II-A ☐ III-A ☐ IV ☐ V-A
(check all that apply) ☐ I-B ☐ II-B ☐ III-B ☒ V-B
Sprinklers: ☐ No ☐ Partial ☒ Yes ☐ NFPA 13 ☒ NFPA 13R ☐ NFPA 13D
Standpipes: ☒ No ☐ Yes Class ☐ I ☐ II ☐ III ☐ Wet ☐ Dry
Fire District: ☐ No ☐ Yes Flood Hazard Area: ☐ No ☐ Yes
Special Inspections Required: ☒ No ☐ Yes (Contact the local inspection jurisdiction for additional procedures and requirements.)

Gross Building Area Table

FLOOR	EXISTING (SQ FT)	NEW (SQ FT)	SUB-TOTAL
3 rd Floor			
2 nd Floor			
Mezzanine			
1 st Floor		4,265	4,265
Basement			
TOTAL			4,265 sf

ALLOWABLE AREA

Primary Occupancy Classification(s):

Assembly ☐ A-1 ☐ A-2 ☐ A-3 ☐ A-4 ☐ A-5
Business ☐
Educational ☐
Factory ☐ F-1 Moderate ☐ F-2 Low
Hazardous ☐ H-1 Detonate ☐ H-2 Deflagrate ☐ H-3 Combust ☐ H-4 Health ☐ H-5 HPM
Institutional ☐ I-1 Condition ☐ 1 ☐ 2
☐ I-2 Condition ☐ 1 ☐ 2
☐ I-3 Condition ☐ 1 ☐ 2 ☐ 3 ☐ 4 ☐ 5
☐ I-4
Mercantile ☐
Residential ☐ R-1 ☒ R-2 ☐ R-3 ☐ R-4
Storage ☐ S-1 Moderate ☐ S-2 Low ☐ High-piled
☐ Parking Garage ☐ Open ☐ Enclosed ☐ Repair Garage
Utility and Miscellaneous ☐

Accessory Occupancy Classification(s):

Incidental Uses (Table 509):

Special Uses (Chapter 4 - List Code Sections):

Special Provisions: (Chapter 5 - List Code Sections):

Mixed Occupancy: ☒ No ☐ Yes Separation: _____ Hr. Exception: _____

☐ Non-Separated Use (508.3) - The required type of construction for the building shall be determined by applying the height and area limitations for each of the applicable occupancies to the entire building. The most restrictive type of construction, so determined, shall apply to the entire building.

☐ Separated Use (508.4) - See below for area calculations for each story, the area of the occupancy shall be such that the sum of the ratios of the actual floor area of each use divided by the allowable floor area for each use shall not exceed 1.

$$\frac{\text{Actual Area of Occupancy A}}{\text{Allowable Area of Occupancy A}} + \frac{\text{Actual Area of Occupancy B}}{\text{Allowable Area of Occupancy B}} \leq 1$$

_____ + _____ 336 ≤ 1.00

STORY NO.	DESCRIPTION AND USE	(A) BLDG AREA PER STORY (ACTUAL)	(B) TABLE 506.2 ¹ AREA	(C) AREA FOR FRONTAGE INCREASE ^{2,3}	(D) ALLOWABLE AREA PER STORY OR UNLIMITED ^{2,3}
1	R-1 Residential Units	4,265 sf	7,000 sf	N/A	7,000 sf

¹ Frontage area increases from Section 506.3 are computed thus:

- a. Perimeter which fronts a public way or open space having 20 feet minimum width = _____ (F)
b. Total Building Perimeter = _____ (P)
c. Ratio (F/P) = _____ (F/P)
d. W = Minimum width of public way = _____ (W)
e. Percent of frontage increase $I_f = 100(F/P - 0.25) \times W/30 = \text{_____} (\%)$

² Unlimited area applicable under conditions of Section 507.

³ Maximum Building Area = total number of stories in the building x D (maximum 3 stories) (506.2).

⁴ The maximum area of open parking garages must comply with Table 406.5.4

⁵ Frontage increase is based on the unspinklered area value in Table 506.2.

ALLOWABLE HEIGHT

	ALLOWABLE	SHOWN ON PLANS	CODE REFERENCE ¹
Building Height in Feet (Table 504.3) ²	40'	13'	
Building Height in Stories (Table 504.4) ³	2	1	

Provide code reference if the "Shown on Plans" quantity is not based on Table 504.3 or 504.4.
The maximum height of air traffic control towers must comply with Table 412.3.1.
The maximum height of open parking garages must comply with Table 406.5.4

FIRE PROTECTION REQUIREMENTS

BUILDING ELEMENT	FIRE SEPARATION DISTANCE (FEET)	REQ'D	RATING PROVIDED (W/ REDUCTION) *	DETAILS AND SHEET #	DESIGN # FOR RATED ASSEMBLY	SHEET # FOR RATED PENETRATION	SHEET # FOR RATED JOINTS
Structural Frame, including columns, girders, trusses		0	0				
Bearing Walls		0	0				
Exterior							
North							
East							
West							
South							
Nonbearing Walls and Partitions		0	0				
Exterior walls							
North							
East							
West							
South							
Interior walls and partitions		0	0				
Floor Construction including supporting beams and joists		0	0				
Floor Ceiling Assembly		0	0				
Columns Supporting Floors		0	0				
Roof Construction, including supporting beams and joists		0	0				
Roof Ceiling Assembly		0	0				
Columns Supporting Roof		0	0				
Shaft Enclosures - Exit		N/A	N/A				
Shaft Enclosures - Other							
Corridor Separation		N/A	N/A				
Occupancy/Fire Barrier Separation		1 HR	1 HR				
Party/Fire Wall Separation		N/A	N/A				
Smoke Barrier Separation		N/A	N/A				
Smoke Partition		N/A	N/A				
Tenant/Dwelling Unit/Sleeping Unit Separation		1 HR	1 HR				
Incidental Use Separation		N/A	N/A				

PERCENTAGE OF WALL OPENING CALCULATIONS

FIRE SEPARATION DISTANCE (FEET) FROM PROPERTY LINES	DEGREE OF OPENINGS PROTECTION (TABLE 705.8)	ALLOWABLE AREA (%)	ACTUAL SHOWN ON PLANS (%)

LIFE SAFETY SYSTEM REQUIREMENTS

Emergency Lighting: ☒ No ☐ Yes
Exit Signs: ☒ No ☐ Yes
Fire Alarms: ☒ No ☐ Yes
Smoke Detection Systems: ☐ No ☒ Yes ☐ Partial _____
Carbon Monoxide Detection: ☐ No ☒ Yes

LIFE SAFETY PLAN REQUIREMENTS

Life Safety Plan Sheet #: TBD

- ☒ Fire and/or smoke rated wall locations (Chapter 7)
- ☐ Assumed and real property line locations (if not on the site plan)
- ☐ Exterior wall opening area with respect to distance to assumed property lines (705.8)
- ☒ Occupancy Use for each area as it relates to occupant load calculation (Table 1004.1.2)
- ☒ Occupant loads for each area
- ☒ Exit sign locations (1013)
- ☒ Exit access travel distances (1017)
- ☒ Common path of travel distances (Tables 1006.2.1 & 1006.3.2(1))
- ☒ Dead end lengths (1020.4)
- ☒ Clear exit widths for each exit door
- ☒ Maximum calculated occupant load capacity each exit door can accommodate based on egress width (1005.3)
- ☒ Actual occupant load for each exit door
- ☐ A separate schematic plan indicating where fire rated floor/ceiling and/or roof structure is provided for purposes of occupancy separation
- ☐ Location of doors with panic hardware (1010.1.10)
- ☐ Location of doors with delayed egress locks and the amount of delay (1010.1.9.7)
- ☐ Location of doors with electromagnetic egress locks (1010.1.9.9)
- ☐ Location of doors equipped with hold-open devices
- ☒ Location of emergency escape windows (1030)
- ☐ The square footage of each fire area (202)
- ☐ The square footage of each smoke compartment for Occupancy Classification I-2 (407.5)
- ☐ Note any code exceptions or table notes that may have been utilized regarding the items above

ACCESSIBLE DWELLING UNITS

(SECTION 1107)

UNIT CLASSIFICATION	TOTAL UNITS	ACCESSIBLE UNITS REQUIRED	ACCESSIBLE UNITS PROVIDED	TYPE A UNITS REQUIRED	TYPE A UNITS PROVIDED	TYPE B UNITS REQUIRED	TYPE B UNITS PROVIDED	TOTAL ACCESSIBLE UNITS PROVIDED
2 Unit Layouts	3	1	1			2	2	3

ACCESSIBLE PARKING

(SECTION 1106)

LOT OR PARKING AREA	TOTAL # OF PARKING SPACES REQUIRED	TOTAL # OF PARKING SPACES PROVIDED	# OF ACCESSIBLE SPACES PROVIDED	TOTAL # ACCESSIBLE PROVIDED
Instructor Housing	N/A	TBD	96" SPACES	132" SPACES
TOTAL				

PLUMBING FIXTURE REQUIREMENTS
(TABLE 2902.1)

USE		WATER CLOSETS			URINALS	LAVATORIES			SHOWERS /TUBS	DRINKING FOUNTAINS	
		MALE	FEMALE	UNISEX		MALE	FEMALE	UNISEX		REGULAR	ACCESSIBLE
SPACE	EXIST'G										
See Below	NEW										
	REQ'D										

1 Water Closet, 1 Shower, 1 Lavatory req'd per unit, 2 provided.

SPECIAL APPROVALS

Special approval: (Local Jurisdiction, Department of Insurance, OSC, DPI, DHHS, etc., describe below)

ENERGY SUMMARY

ENERGY REQUIREMENTS:

The following data shall be considered minimum and any special attribute required to meet the energy code shall also be provided. Each Designer shall furnish the required portions of the project information for the plan data sheet. If performance method, state the annual energy cost for the standard reference design vs annual energy cost for the proposed design.

Existing building envelope complies with code: ☐ No ☐ Yes (The remainder of this section is not applicable)

Exempt Building: ☐ No ☐ Yes (Provide code or statutory reference):

Climate Zone: ☐ 3A ☐ 4A ☐ 5A

Method of Compliance: Energy Code ☐ Performance ☐ Prescriptive
ASHRAE 90.1 ☐ Performance ☐ Prescriptive
(If "Other" specify source here)

THERMAL ENVELOPE (Prescriptive method only)

Roof/ceiling Assembly (each assembly)

Description of assembly: _____
U-Value of total assembly: _____
R-Value of insulation: _____
Skylights in each assembly: _____
U-Value of skylight: _____
total square footage of skylights in each assembly: _____

Exterior Walls (each assembly)

Description of assembly: _____
U-Value of total assembly: _____
R-Value of insulation: _____
Openings (windows or doors with glazing)
U-Value of assembly: _____
Solar heat gain coefficient: _____
projection factor: _____
Door R-Values: _____

Walls below grade (each assembly)

Description of assembly: _____
U-Value of total assembly: _____
R-Value of insulation: _____

Floors over unconditioned space (each assembly)

Description of assembly: _____
U-Value of total assembly: _____
R-Value of insulation: _____

Floors slab on grade

Description of assembly: _____
U-Value of total assembly: _____
R-Value of insulation: _____
Horizontal/vertical requirement: _____
slab heated: _____

2018 APPENDIX B
BUILDING CODE SUMMARY FOR ALL COMMERCIAL PROJECTS
STRUCTURAL DESIGN
(PROVIDE ON THE STRUCTURAL SHEETS IF APPLICABLE)

DESIGN LOADS:

Importance Factors: Snow (I_s) _____
Seismic (I_e) _____

Live Loads: Roof _____ psf
Mezzanine _____ psf
Floor _____ psf

Ground Snow Load: _____ psf

Wind Load: Ultimate Wind Speed _____ mph (ASCE-7)
Exposure Category _____

SEISMIC DESIGN CATEGORY: ☐ A ☐ B ☐ C ☐ D

Provide the following Seismic Design Parameters:

Risk Category (Table 1604.5) ☐ I ☐ II ☐ III ☐ IV

Spectral Response Acceleration S_s _____ %g

Site Classification (ASCE 7) ☐ A ☐ B ☐ C ☐ D ☐ E ☐ F

Data Source: ☐ Field Test ☐ Presumptive ☐ Historical Data

Basic structural system ☐ Bearing Wall ☐ Dual w/Special Moment Frame
☐ Building Frame ☐ Dual w/Intermediate R/C or Special Steel
☐ Moment Frame ☐ Inverted Pendulum

Analysis Procedure: ☐ Simplified ☐ Equivalent Lateral Force ☐ Dynamic

Architectural, Mechanical, Components anchored? ☐ Yes ☐ No

LATERAL DESIGN CONTROL: Earthquake ☐ Wind ☐

SOIL BEARING CAPACITIES:

Field Test (provide copy of test report) _____ psf
Presumptive Bearing capacity _____ psf
Pile size, type, and capacity _____

2018 APPENDIX B
BUILDING CODE SUMMARY FOR ALL COMMERCIAL PROJECTS
MECHANICAL DESIGN
(PROVIDE ON THE MECHANICAL SHEETS IF APPLICABLE)

MECHANICAL SUMMARY

MECHANICAL SYSTEMS, SERVICE SYSTEMS AND EQUIPMENT

Thermal Zone

winter dry bulb: _____
summer dry bulb: _____

Interior design conditions

winter dry bulb: _____
summer dry bulb: _____
relative humidity: _____

Building heating load: _____

Building cooling load: _____

Mechanical Spacing Conditioning System

Unitary

description of unit: _____
heating efficiency: _____
cooling efficiency: _____
size category of unit: _____

Boiler _____
Size category. If oversized, state reason: _____

Chiller _____
Size category. If oversized, state reason: _____

List equipment efficiencies: _____

2018 APPENDIX B
BUILDING CODE SUMMARY FOR ALL COMMERCIAL PROJECTS
ELECTRICAL DESIGN
(PROVIDE ON THE ELECTRICAL SHEETS IF APPLICABLE)

ELECTRICAL SUMMARY

ELECTRICAL SYSTEM AND EQUIPMENT

Method of Compliance: Energy Code ☐ Performance ☐ Prescriptive
ASHRAE 90.1 ☐ Performance ☐ Prescriptive

Lighting schedule (each fixture type)

lamp type required in fixture _____
number of lamps in fixture _____
ballast type used in the fixture _____
number of ballasts in fixture _____
total wattage per fixture _____
total interior wattage specified vs. allowed (whole building or space by space) _____
total exterior wattage specified vs. allowed _____

Additional Efficiency Package Options
(When using the 2018 NCECC; not required for ASHRAE 90.1)

- ☐ C406.2 More Efficient HVAC Equipment Performance
- ☐ C406.3 Reduced Lighting Power Density
- ☐ C406.4 Enhanced Digital Lighting Controls
- ☐ C406.5 On-Site Renewable Energy
- ☐ C406.6 Dedicated Outdoor Air System
- ☐ C406.7 Reduced Energy Use in Service Water Heating

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SCHEMATIC DESIGN



Revisions		
No.	Description	Date

date: 12-04-2023
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sheet title:
APPENDIX B

sheet no.:

A1.01

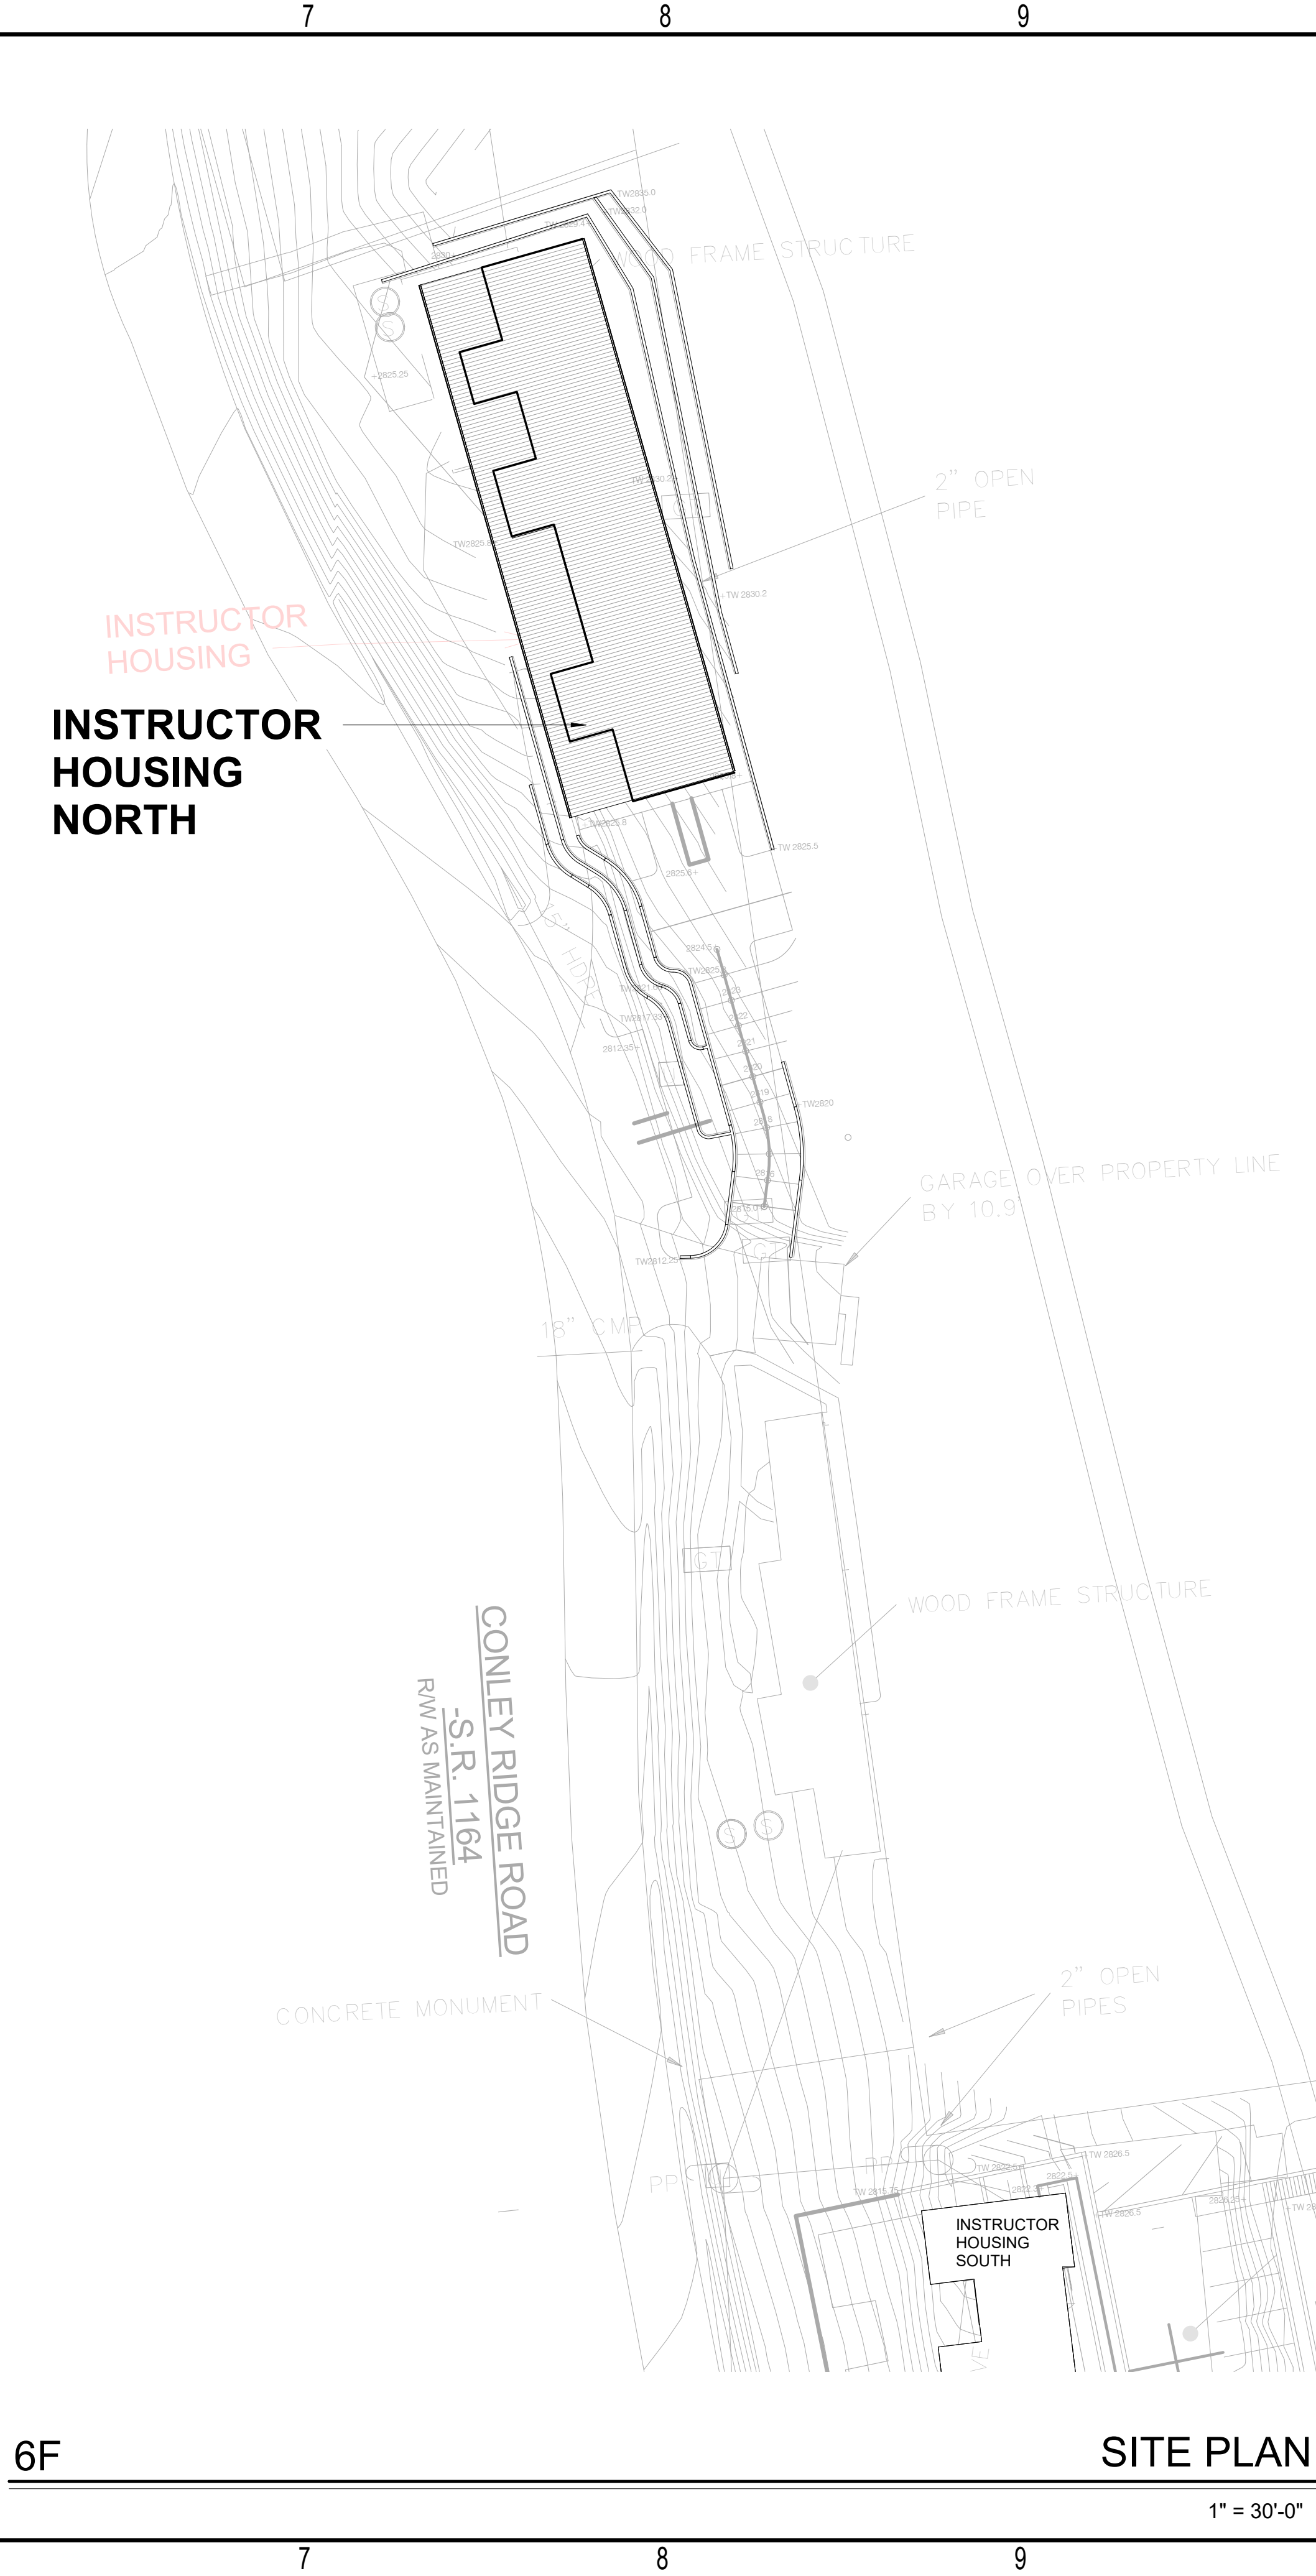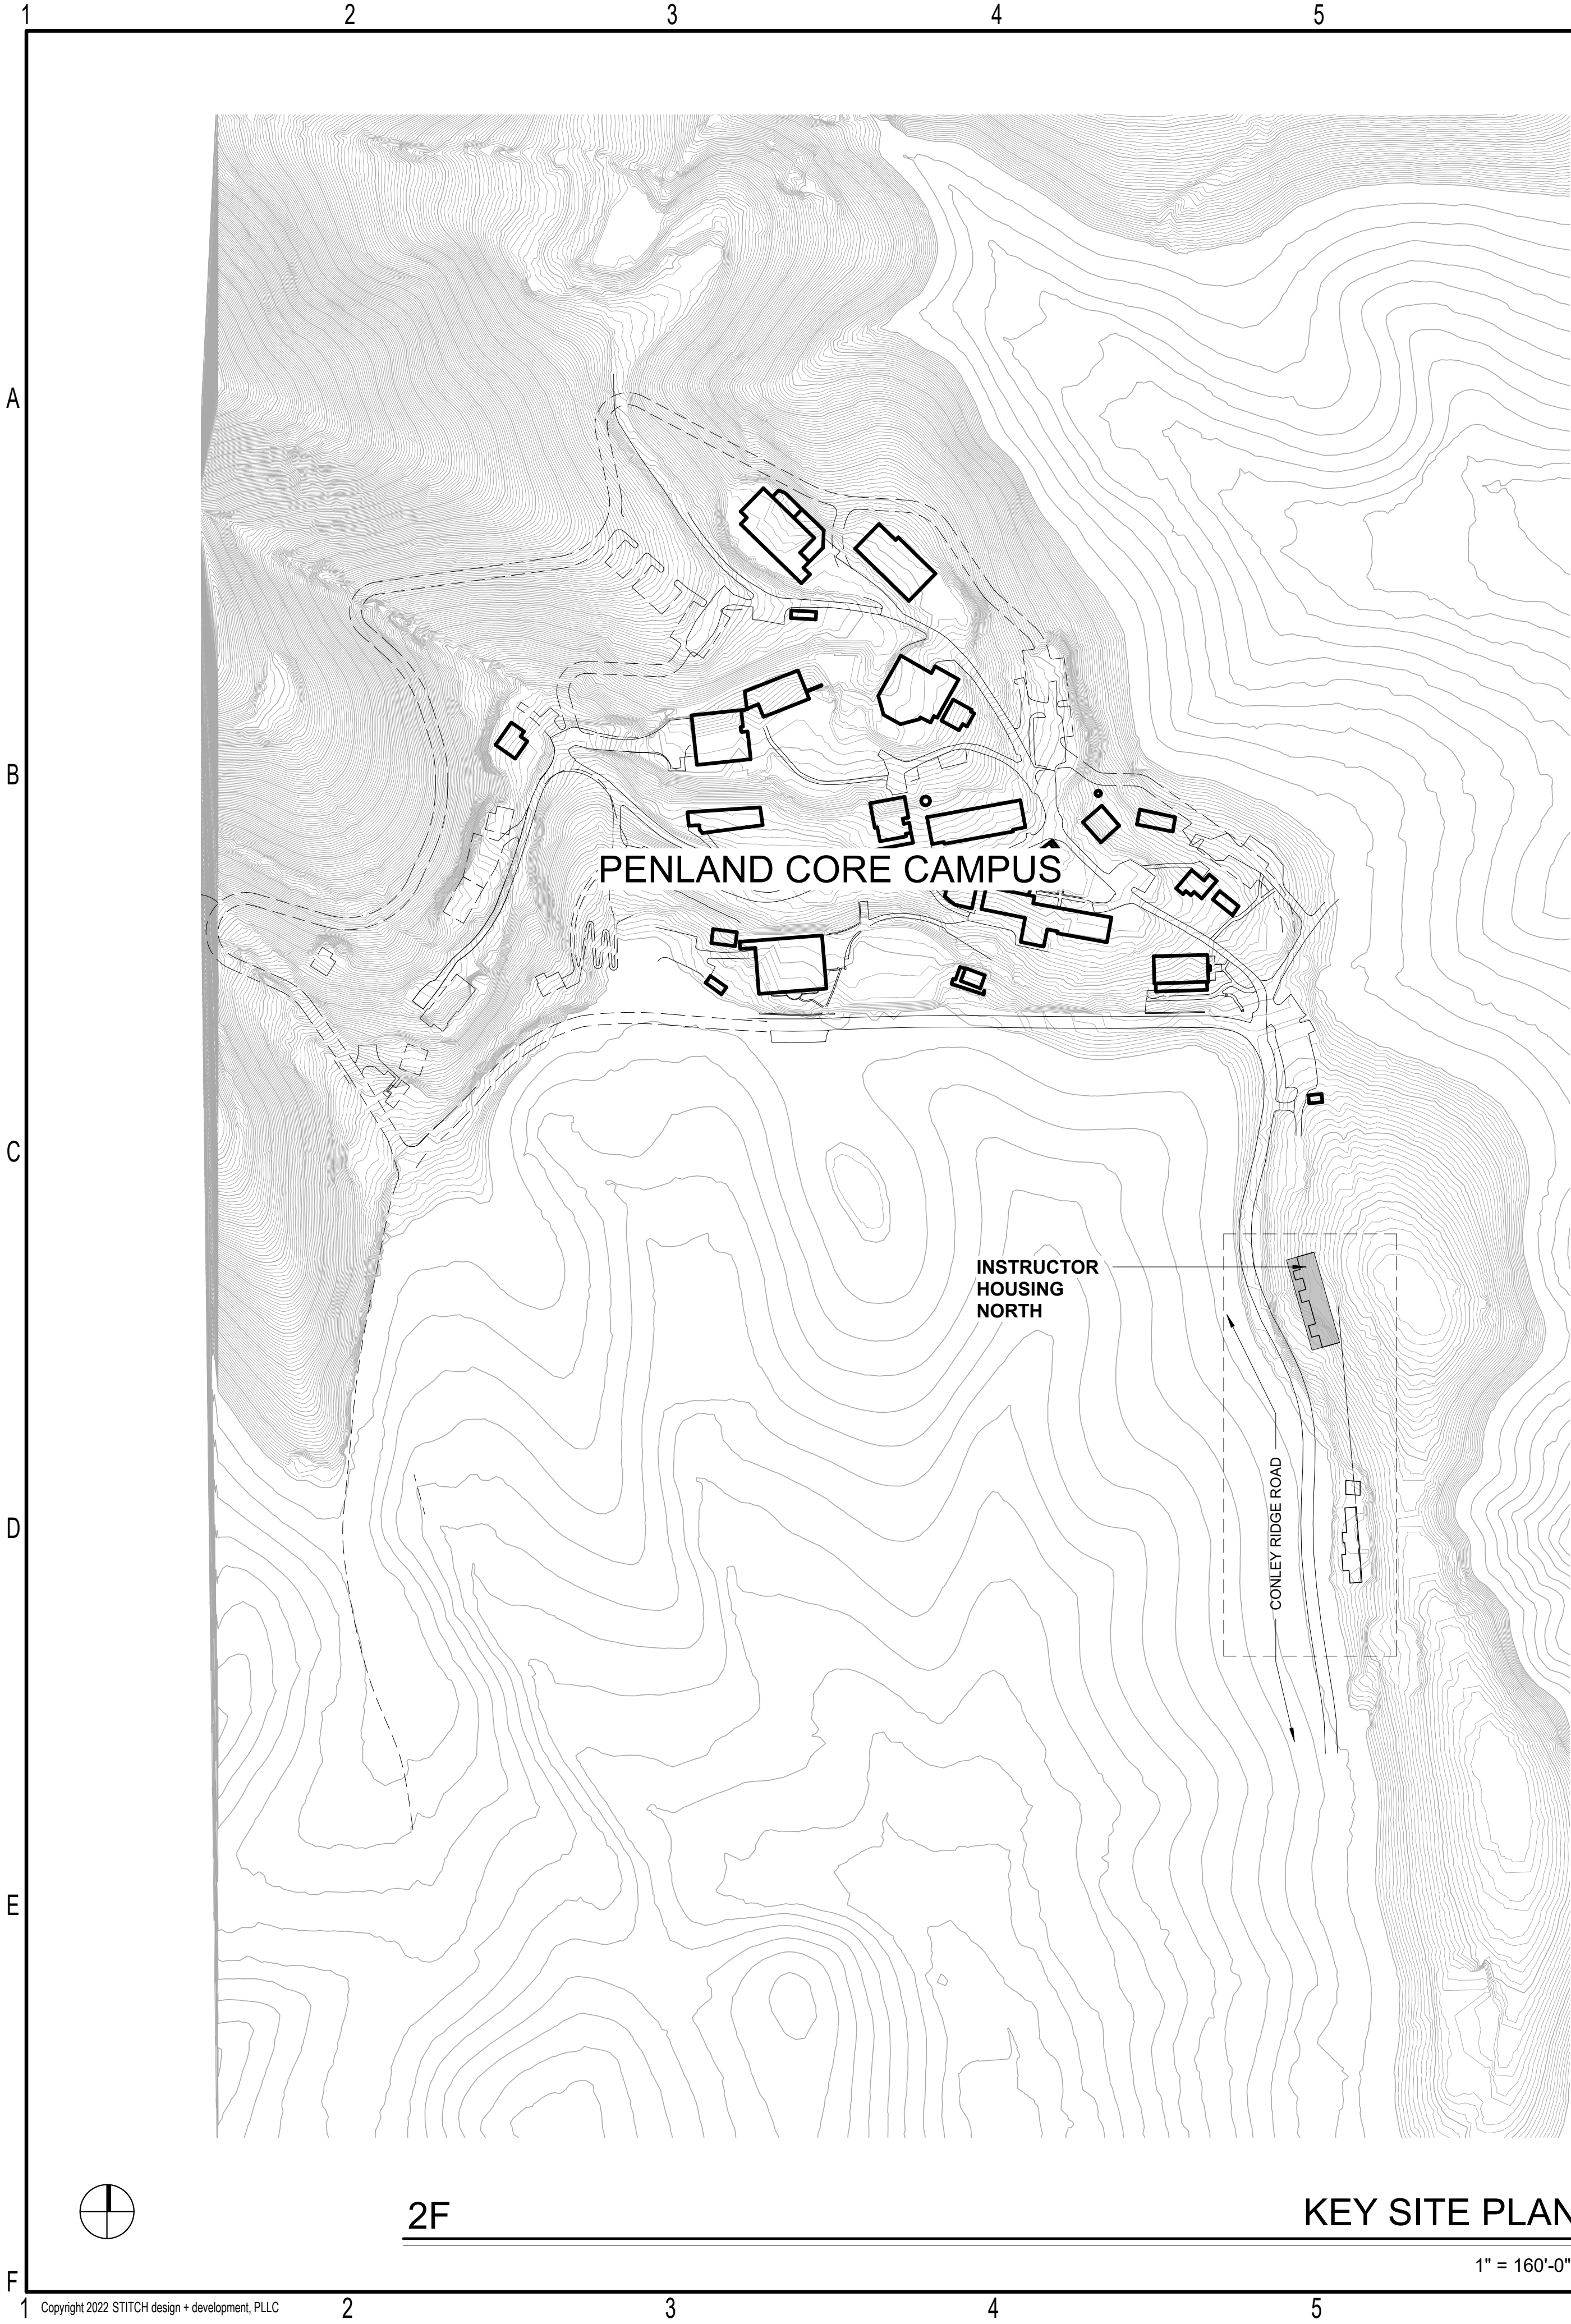

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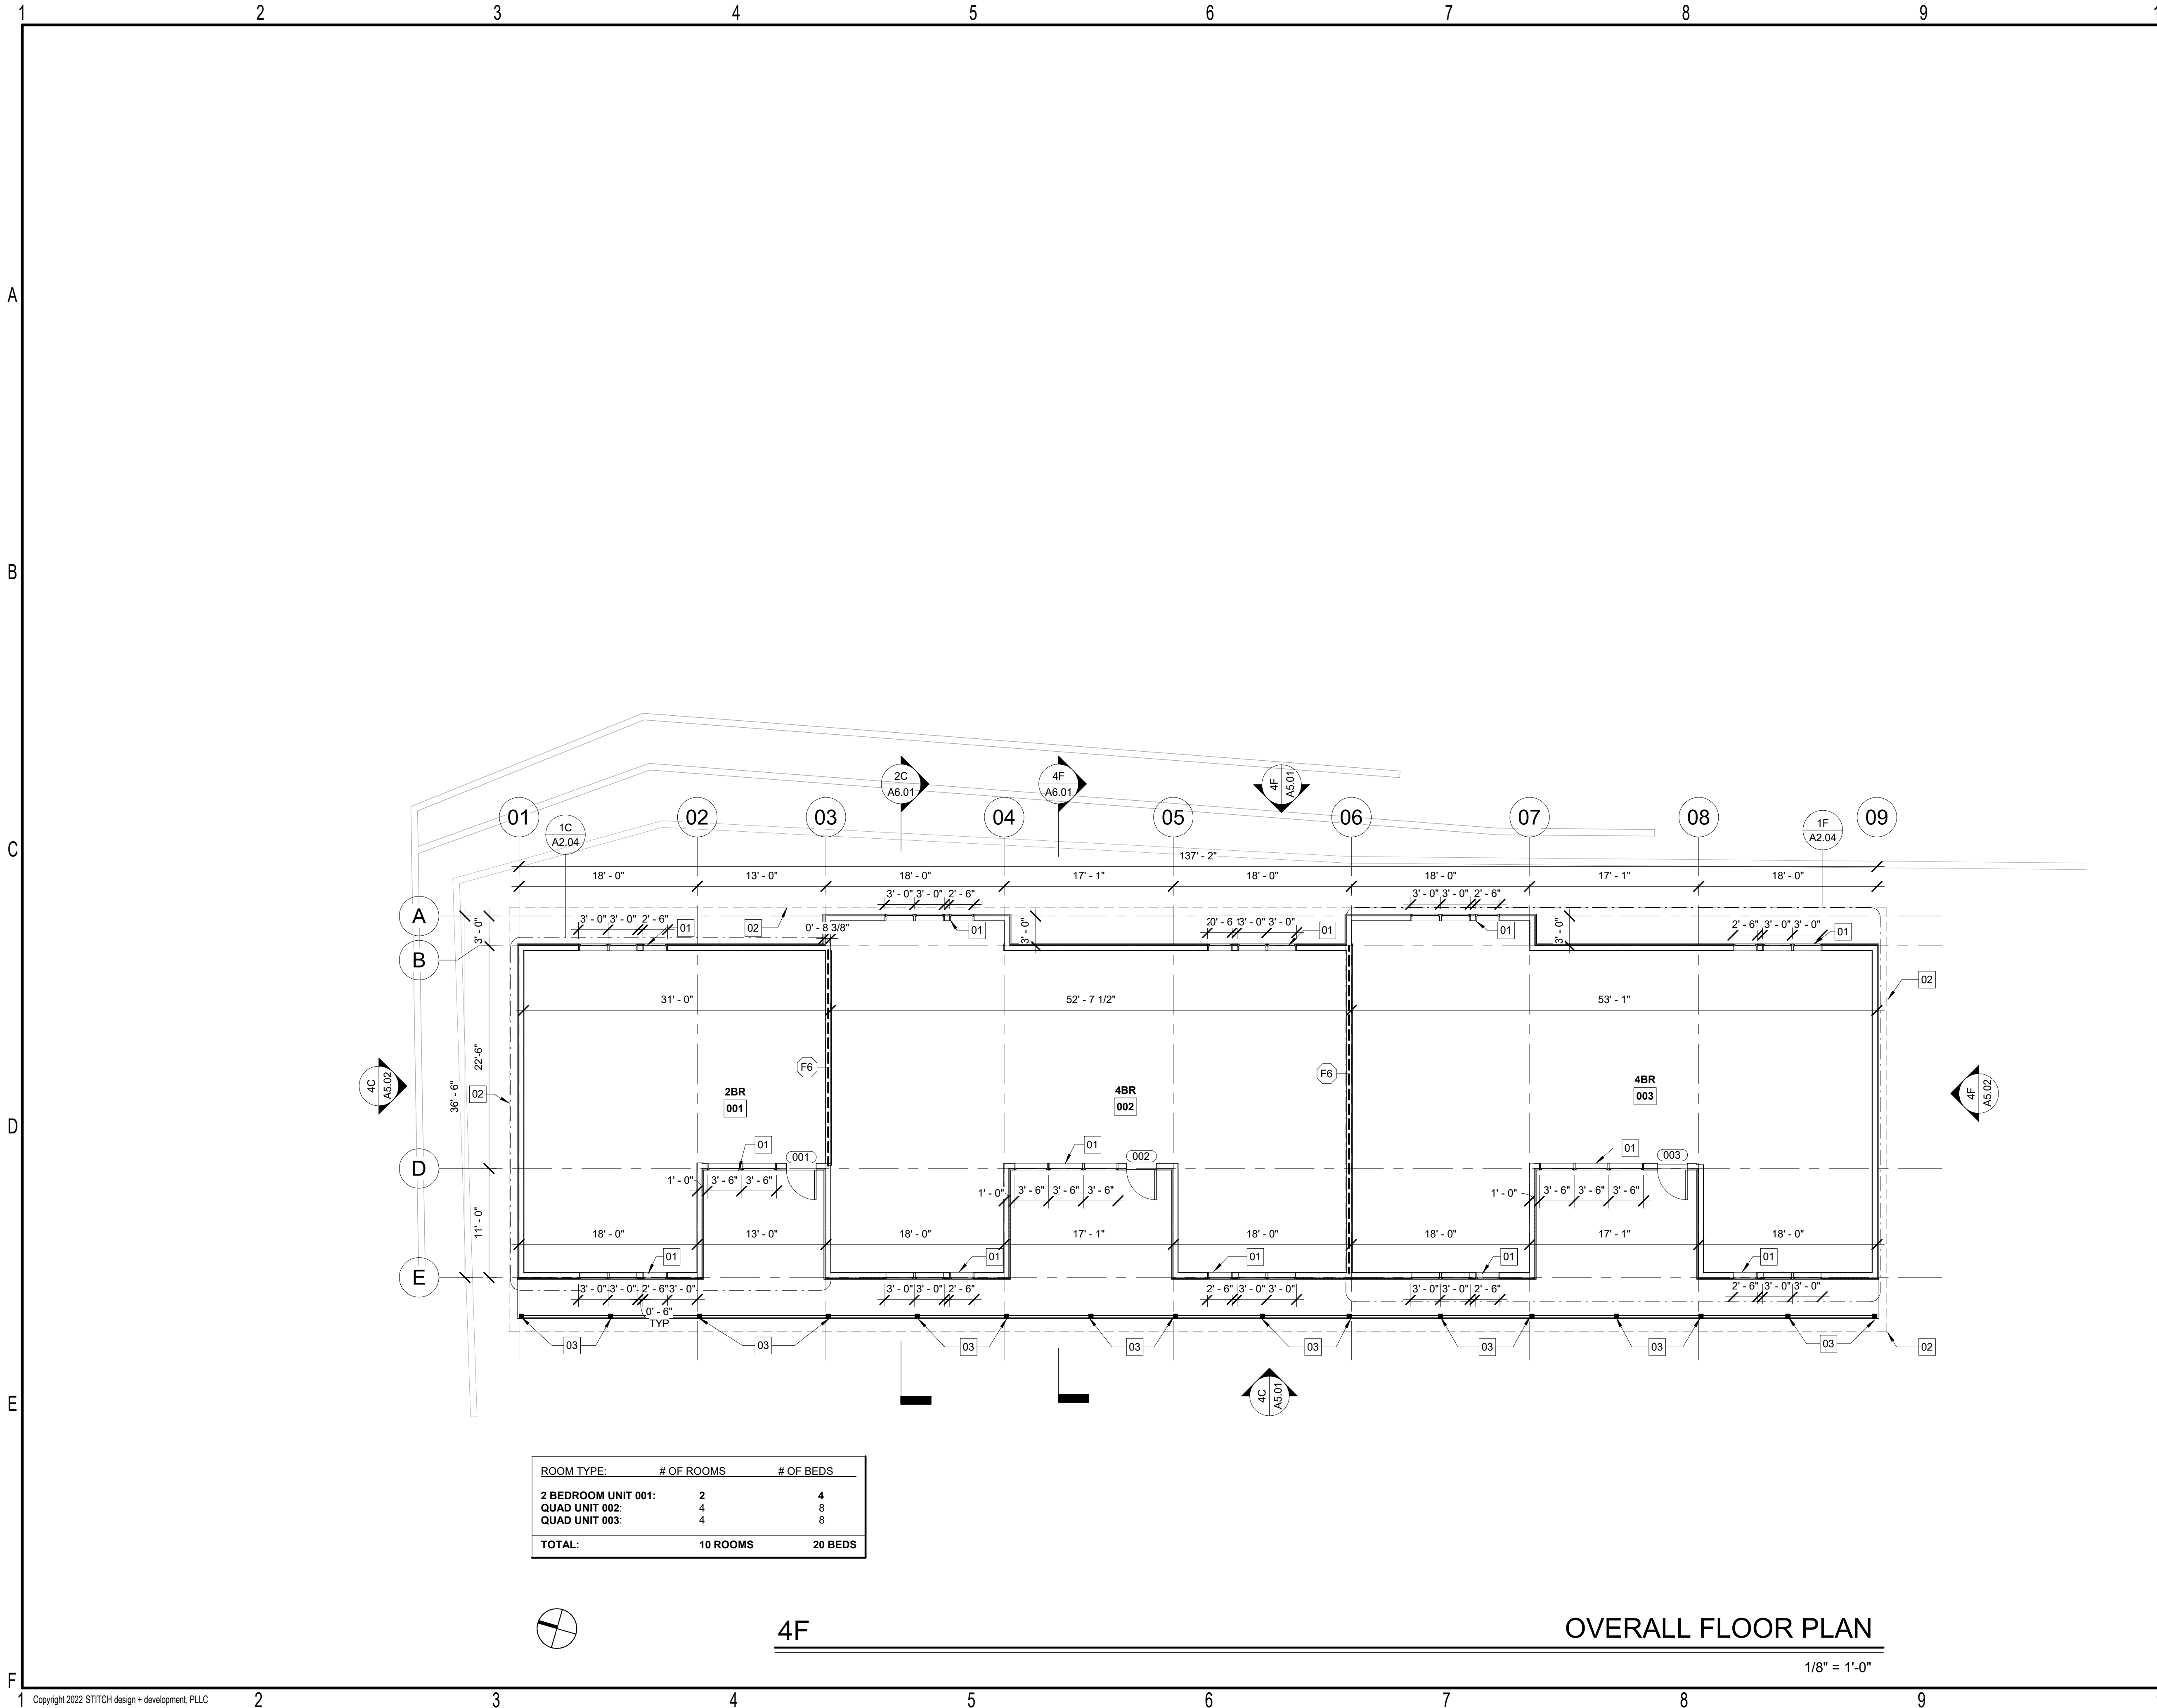
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No.	Description	Date

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commission: 0054

sheet title:
SITE PLAN

sheet no.:
A1.02



GENERAL NOTES - PLAN

- ALL WORK SHALL BE CONSTRUCTED IN ACCORDANCE WITH 2018 NORTH CAROLINA RESIDENTIAL BUILDING CODES (NCRBC) AND ALL APPLICABLE LOCAL CODES.
- ALL PLAN DIMENSIONS ARE TO EXT. FACE OF SHEATHING FOR EXTERIOR WALLS, FACE OF STUD/STRUCTURE FOR INTERIOR WALLS, AND COLUMN CENTERLINE U.N.O.
- ALL EXTERIOR WOOD WALLS SHALL BE 2X6 WOOD STUDS WITH 1/2" OSB SHEATHING, U.N.O. REFER TO STRUCTURAL PLANS FOR SHEAR WALL LOCATIONS AND ARCHITECTURAL FLOOR PLANS FOR FURRED WALLS.
- ALL INTERIOR WALLS SHALL BE 2X4 WOOD STUDS WITH 1/2" GWB, U.N.O.
- GC SHALL CONFIRM ALL ROUGH WINDOW AND DOOR OPENINGS PRIOR TO THE ORDERING OF ALL WINDOWS AND DOORS.
- GC SHALL TAKE ALL STEPS NECESSARY TO ENSURE ALL EXTERIOR DOORS, WINDOWS & PENETRATIONS ARE PROPERLY FLASHED AND SEALED.
- DISTANCE FROM BACK OF HINGE SIDE DOOR FRAME TO WALL SHALL BE 6" UNLESS NOTED OTHERWISE.
- ALL INTERIOR DOORS TO BE SOLID CORE.
- CALIFORNIA CORNERS SHALL BE USED TO ENSURE CONTINUITY OF THERMAL ENVELOPE.
- PROVIDE WOOD BLOCKING AS REQUIRED AT ALL MILLWORK AND OTHER WALL MOUNTED ACCESSORIES.
- STRUCTURAL ENGINEER AND/OR TRUSS AND JOIST MANUFACTURER (OR PROVIDER) SHALL CONFIRM AND SIZE ALL BEAMS, JOISTS, TRUSSES AND COLUMNS.
- GC TO CONFIRM ALL INTERIOR & EXTERIOR SELECTIONS WITH OWNER PRIOR TO ORDERING & INSTALLATION.
- WINDOW AND DOOR MANUFACTURER (OR PROVIDER) SHALL VERIFY TEMPERED GLASS AND EGRESS WINDOWS LOCATIONS.
- ALL DOORS AND BASEBOARDS TBD BY DESIGNER AND OWNER.
- PROVIDE BATT INSULATION AT INTERIOR WALLS FOR ACOUSTIC PRIVACY AROUND ALL BATHROOMS AND BEDROOMS.

KEYNOTES - PLAN

- 01 ALUMINUM CLAD WOOD WINDOWS; CASEMENTS AND AWNINGS AS SHOWN ON ELEVATIONS; PREFINISHED BLACK
- 02 LINE OF ROOF ABOVE
- 03 WRAPPED ENGINEERED POSTS; FINISH TBD
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WALLS DENOTED WITH HEAVY DASHED LINES ARE FIRE-RATED DEMISING WALLS BETWEEN UNITS, SEE PARTITION SCHEDULE



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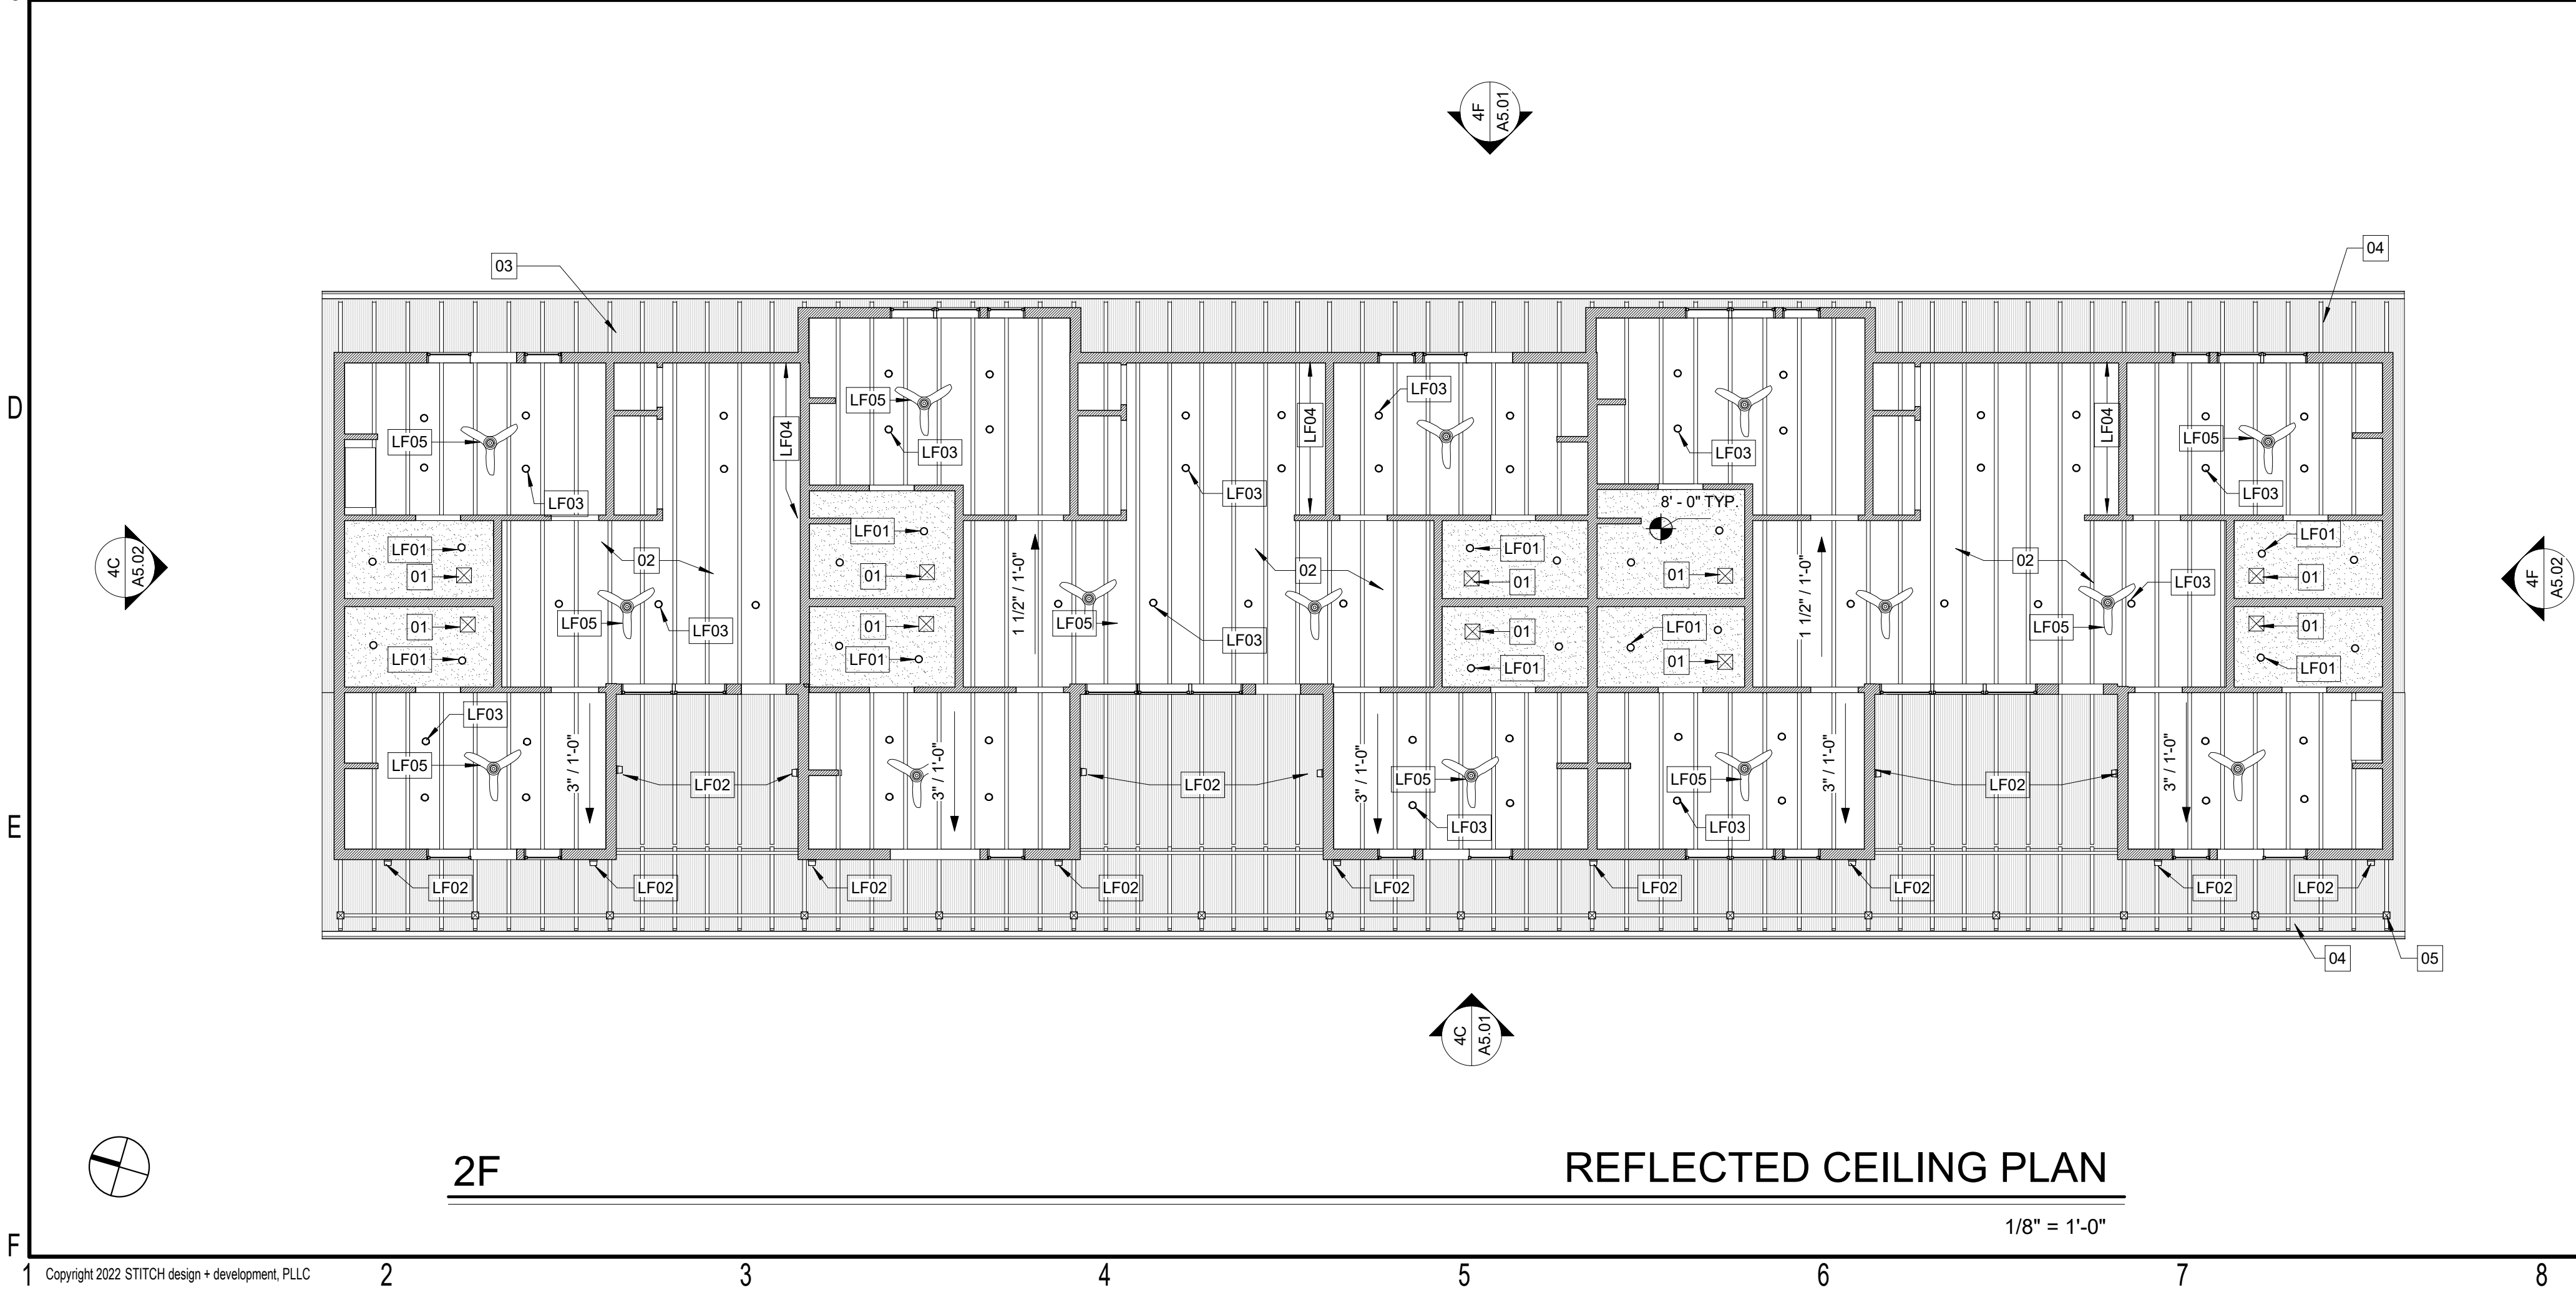
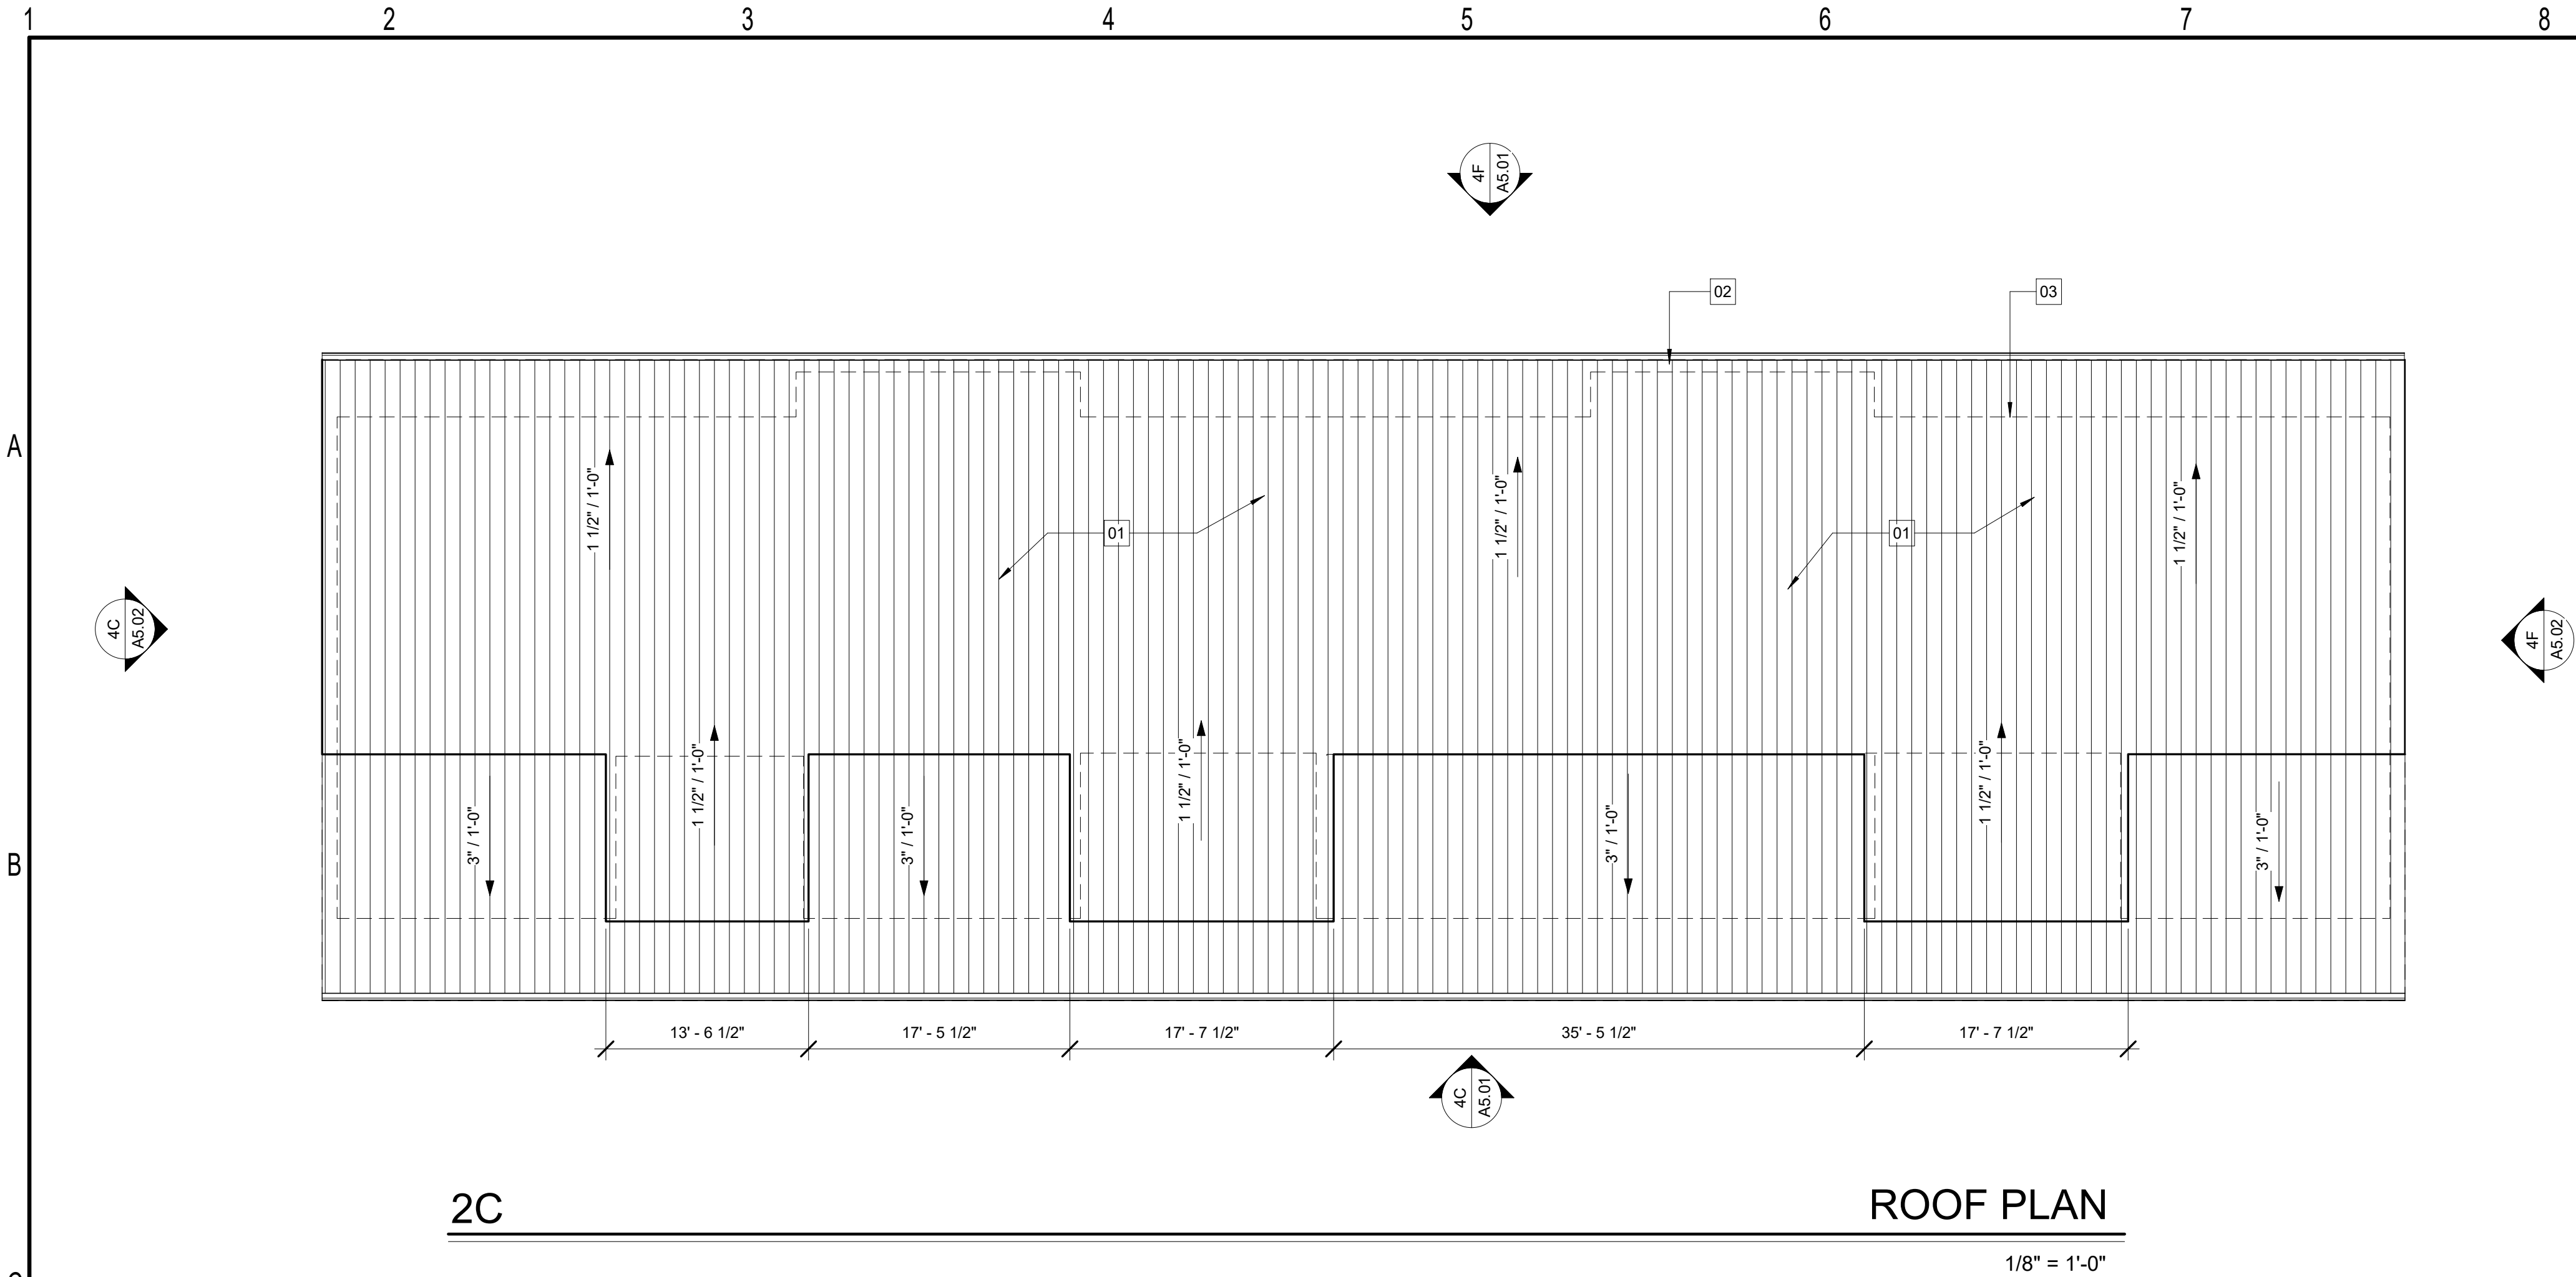
SCHEMATIC DESIGN

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No.	Description	Date

date: 12-04-2023
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FLOOR PLAN

sheet no.:
A2.01



GENERAL ROOF NOTES

1. PENETRATION DETAILS SHOWN ARE TO BE APPROVED BY ROOFING MANUFACTURER.
2. ROOFING DETAILS TO COMPLY WITH THE LATEST EDITION OF SMACNA & NRCA MANUAL.
3. ALL COPING TO BE FASTENED PER ANSI SPRI ES-1 STANDARDS.
4. COORDINATE DOWNSPOUT SIZE AND LOCATION WITH ARCHITECT.
5. MAINTAIN POSITIVE DRAINAGE ON ALL ROOF SURFACES, MINIMUM SLOPE OF 1/4" PER 1'-0".

KEY NOTES - ROOF PLAN

- 01 24GA STRIATED STANDING SEAM METAL ROOF, PREFINISHED SW7069 IRON ORE
- 02 PREFINISHED ALUMINUM BOX GUTTER, FINISH SW7069 IRON ORE
- 03 LINE OF WALL BELOW
- 04 PREFINISHED METAL DOWNSPOUT, FINISH COLOR TO MATCH GUTTER, SEE ELEVATIONS FOR LOCATIONS

RCP GENERAL NOTES

1. ALL WORK SHALL BE IN ACCORDANCE WITH 2018 NCRC AND ANY LOCAL CODES.
2. REFER TO ELECTRICAL DRAWINGS FOR OTHER CEILING MOUNTED DEVICES, LIGHTS, AND EXT. SIGNS.
3. LIGHT FIXTURES AND OTHER DEVICES SHALL BE CENTERED IN THE ACOUSTICAL TILE UNLESS NOTED OTHERWISE.
4. ALL EXPOSED CEILING LOCATIONS TO BE PAINTED.

KEYNOTES - RCP

- 01 EXHAUST FAN
- 02 BAL TIC BIRCH PLYWOOD CEILING BETWEEN EXPOSED RAFTERS
- 03 CLEAR SEALED BAL TIC BIRCH PLYWOOD CEILING
- 04 PRESSURE TREATED ROOF RAFTER PER STRUCTURAL
- 05 PRESSURE TREATED WOOD COLUMNS
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LIGHTING SCHEDULE

- LF01 4" RECESSED CAN LIGHT
- LF02 OUTDOOR WALL SCONCE; BASIS OF DESIGN: ALVA BRIAN, LONG PANEL, MATTE BLACK
- LF03 6" RECESSED CAN LIGHT
- LF04 UNDERCABINET LED STRIP LIGHTING
- LF05 CEILING FAN; BASIS OF DESIGN: MINKA AIRE ROTO 52" 3 BLADE HANG MOUNT INDOOR LED CEILING FAN



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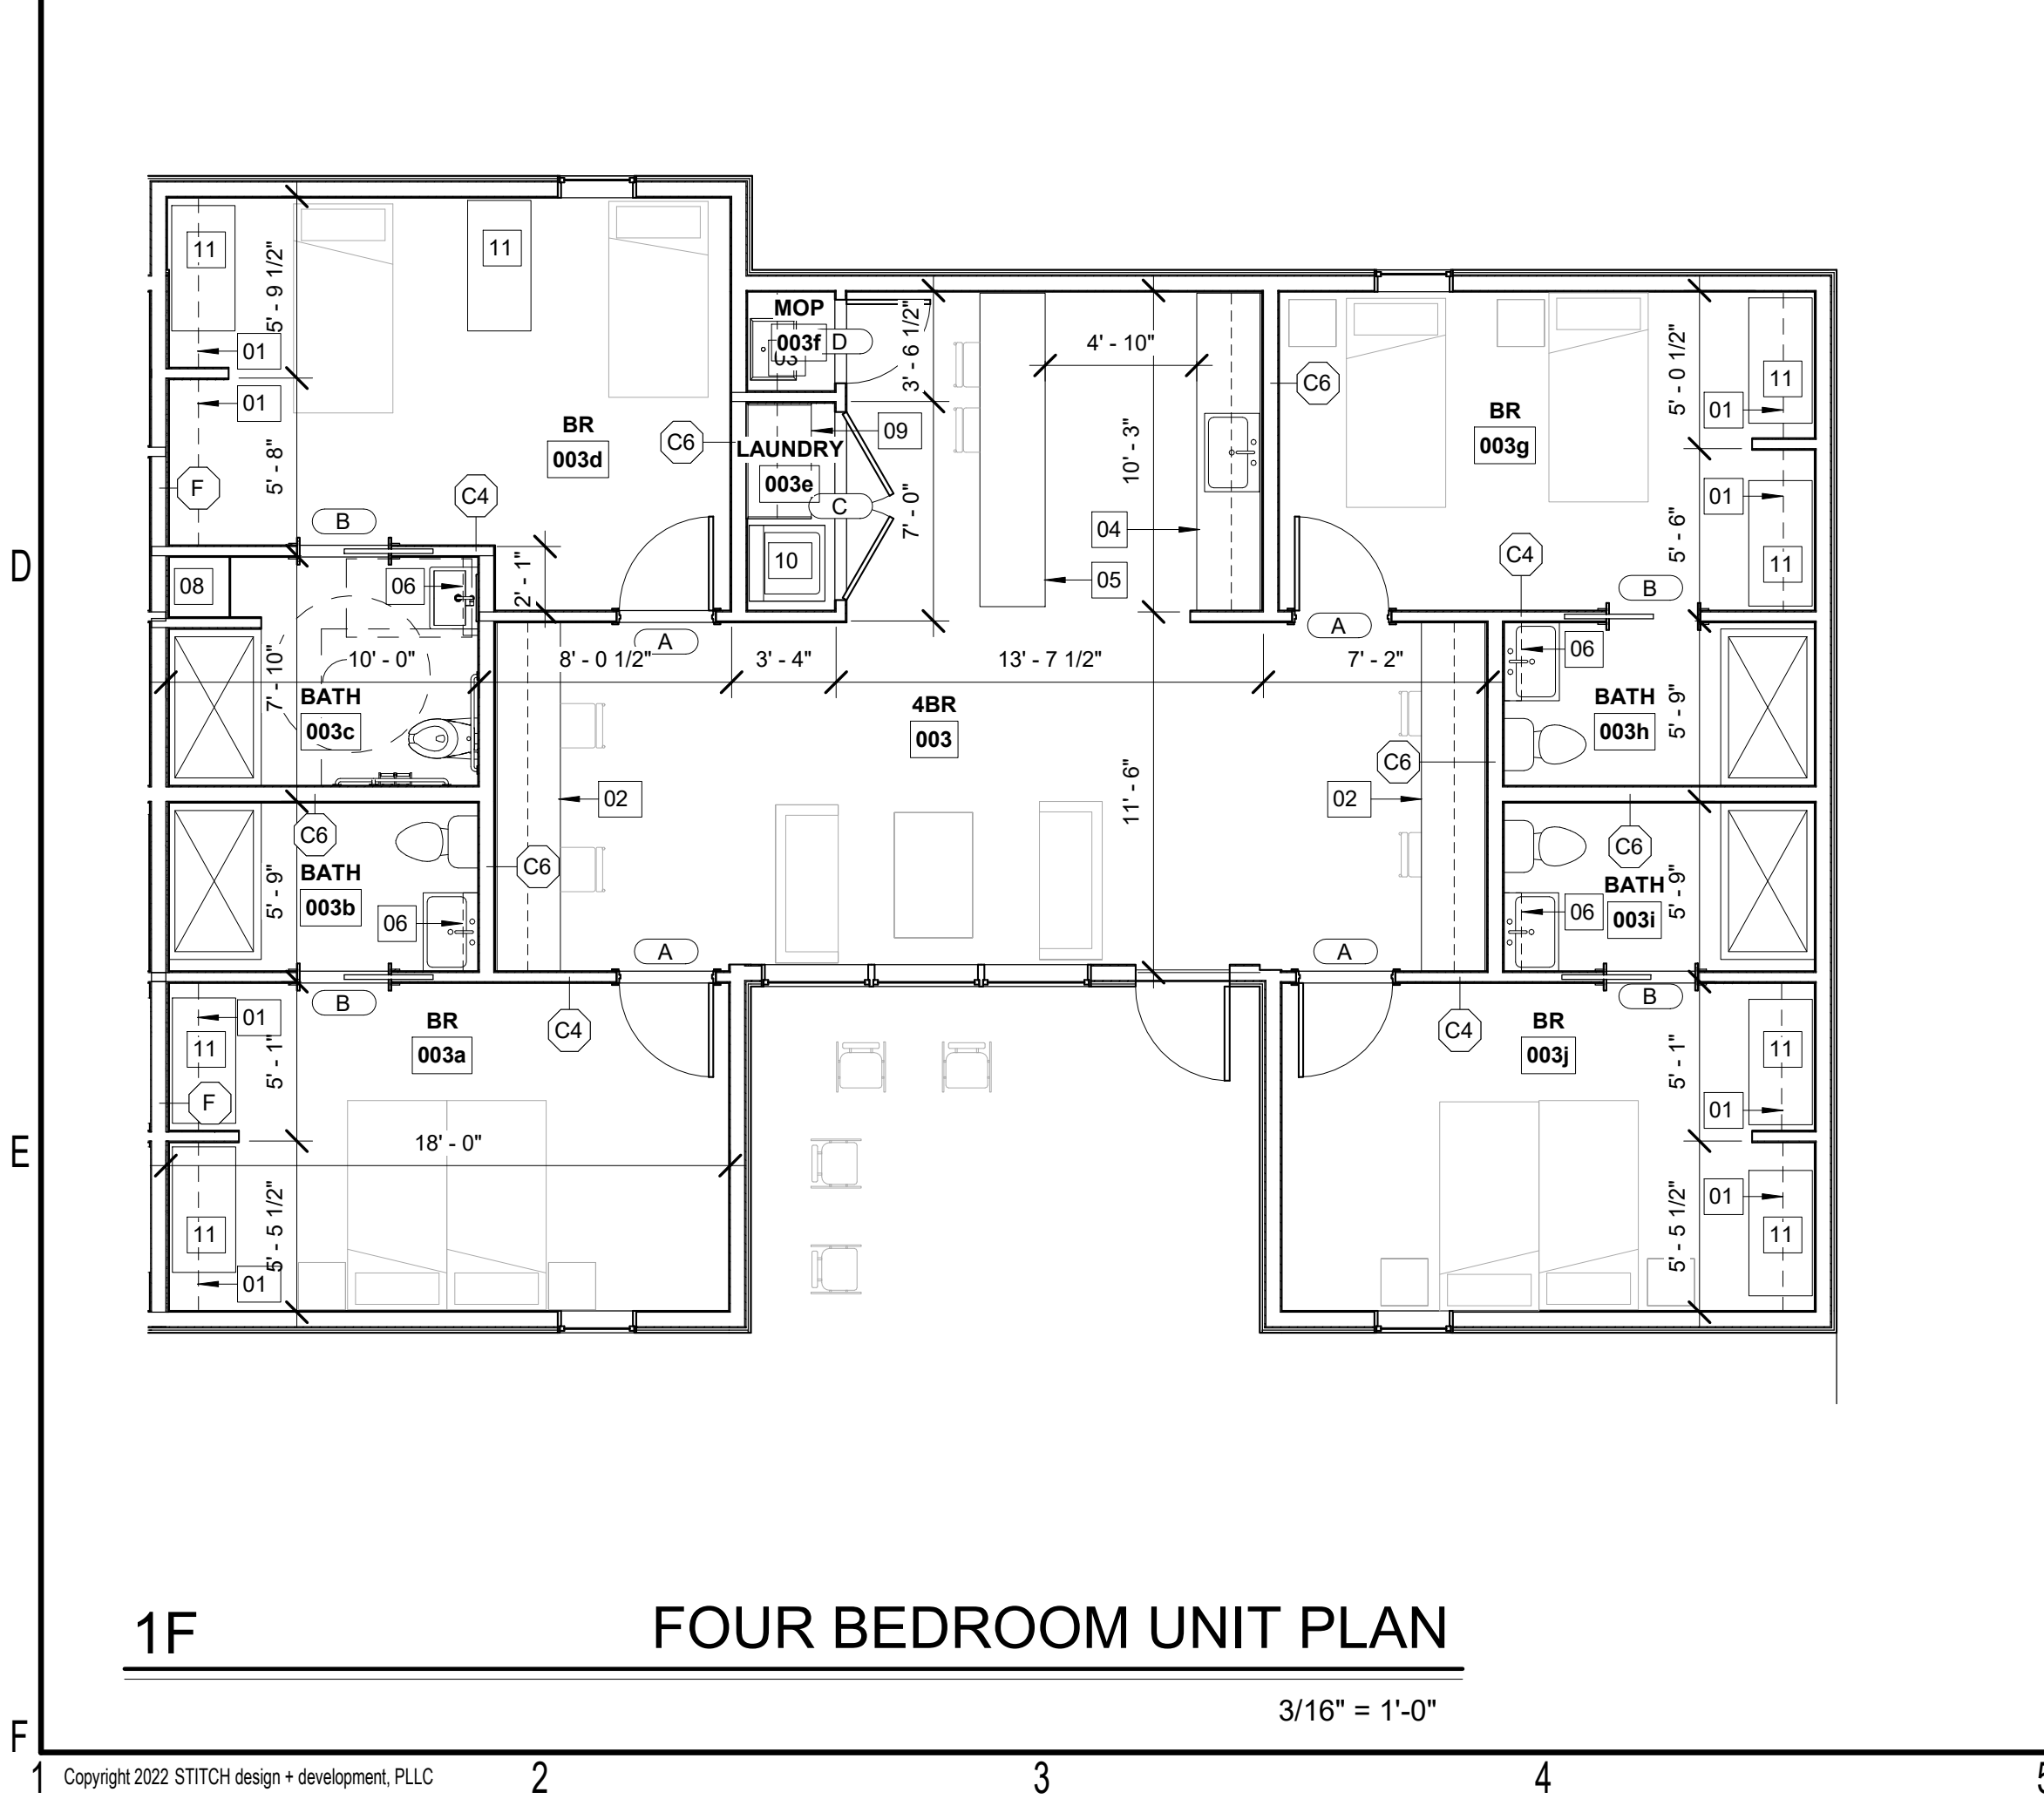
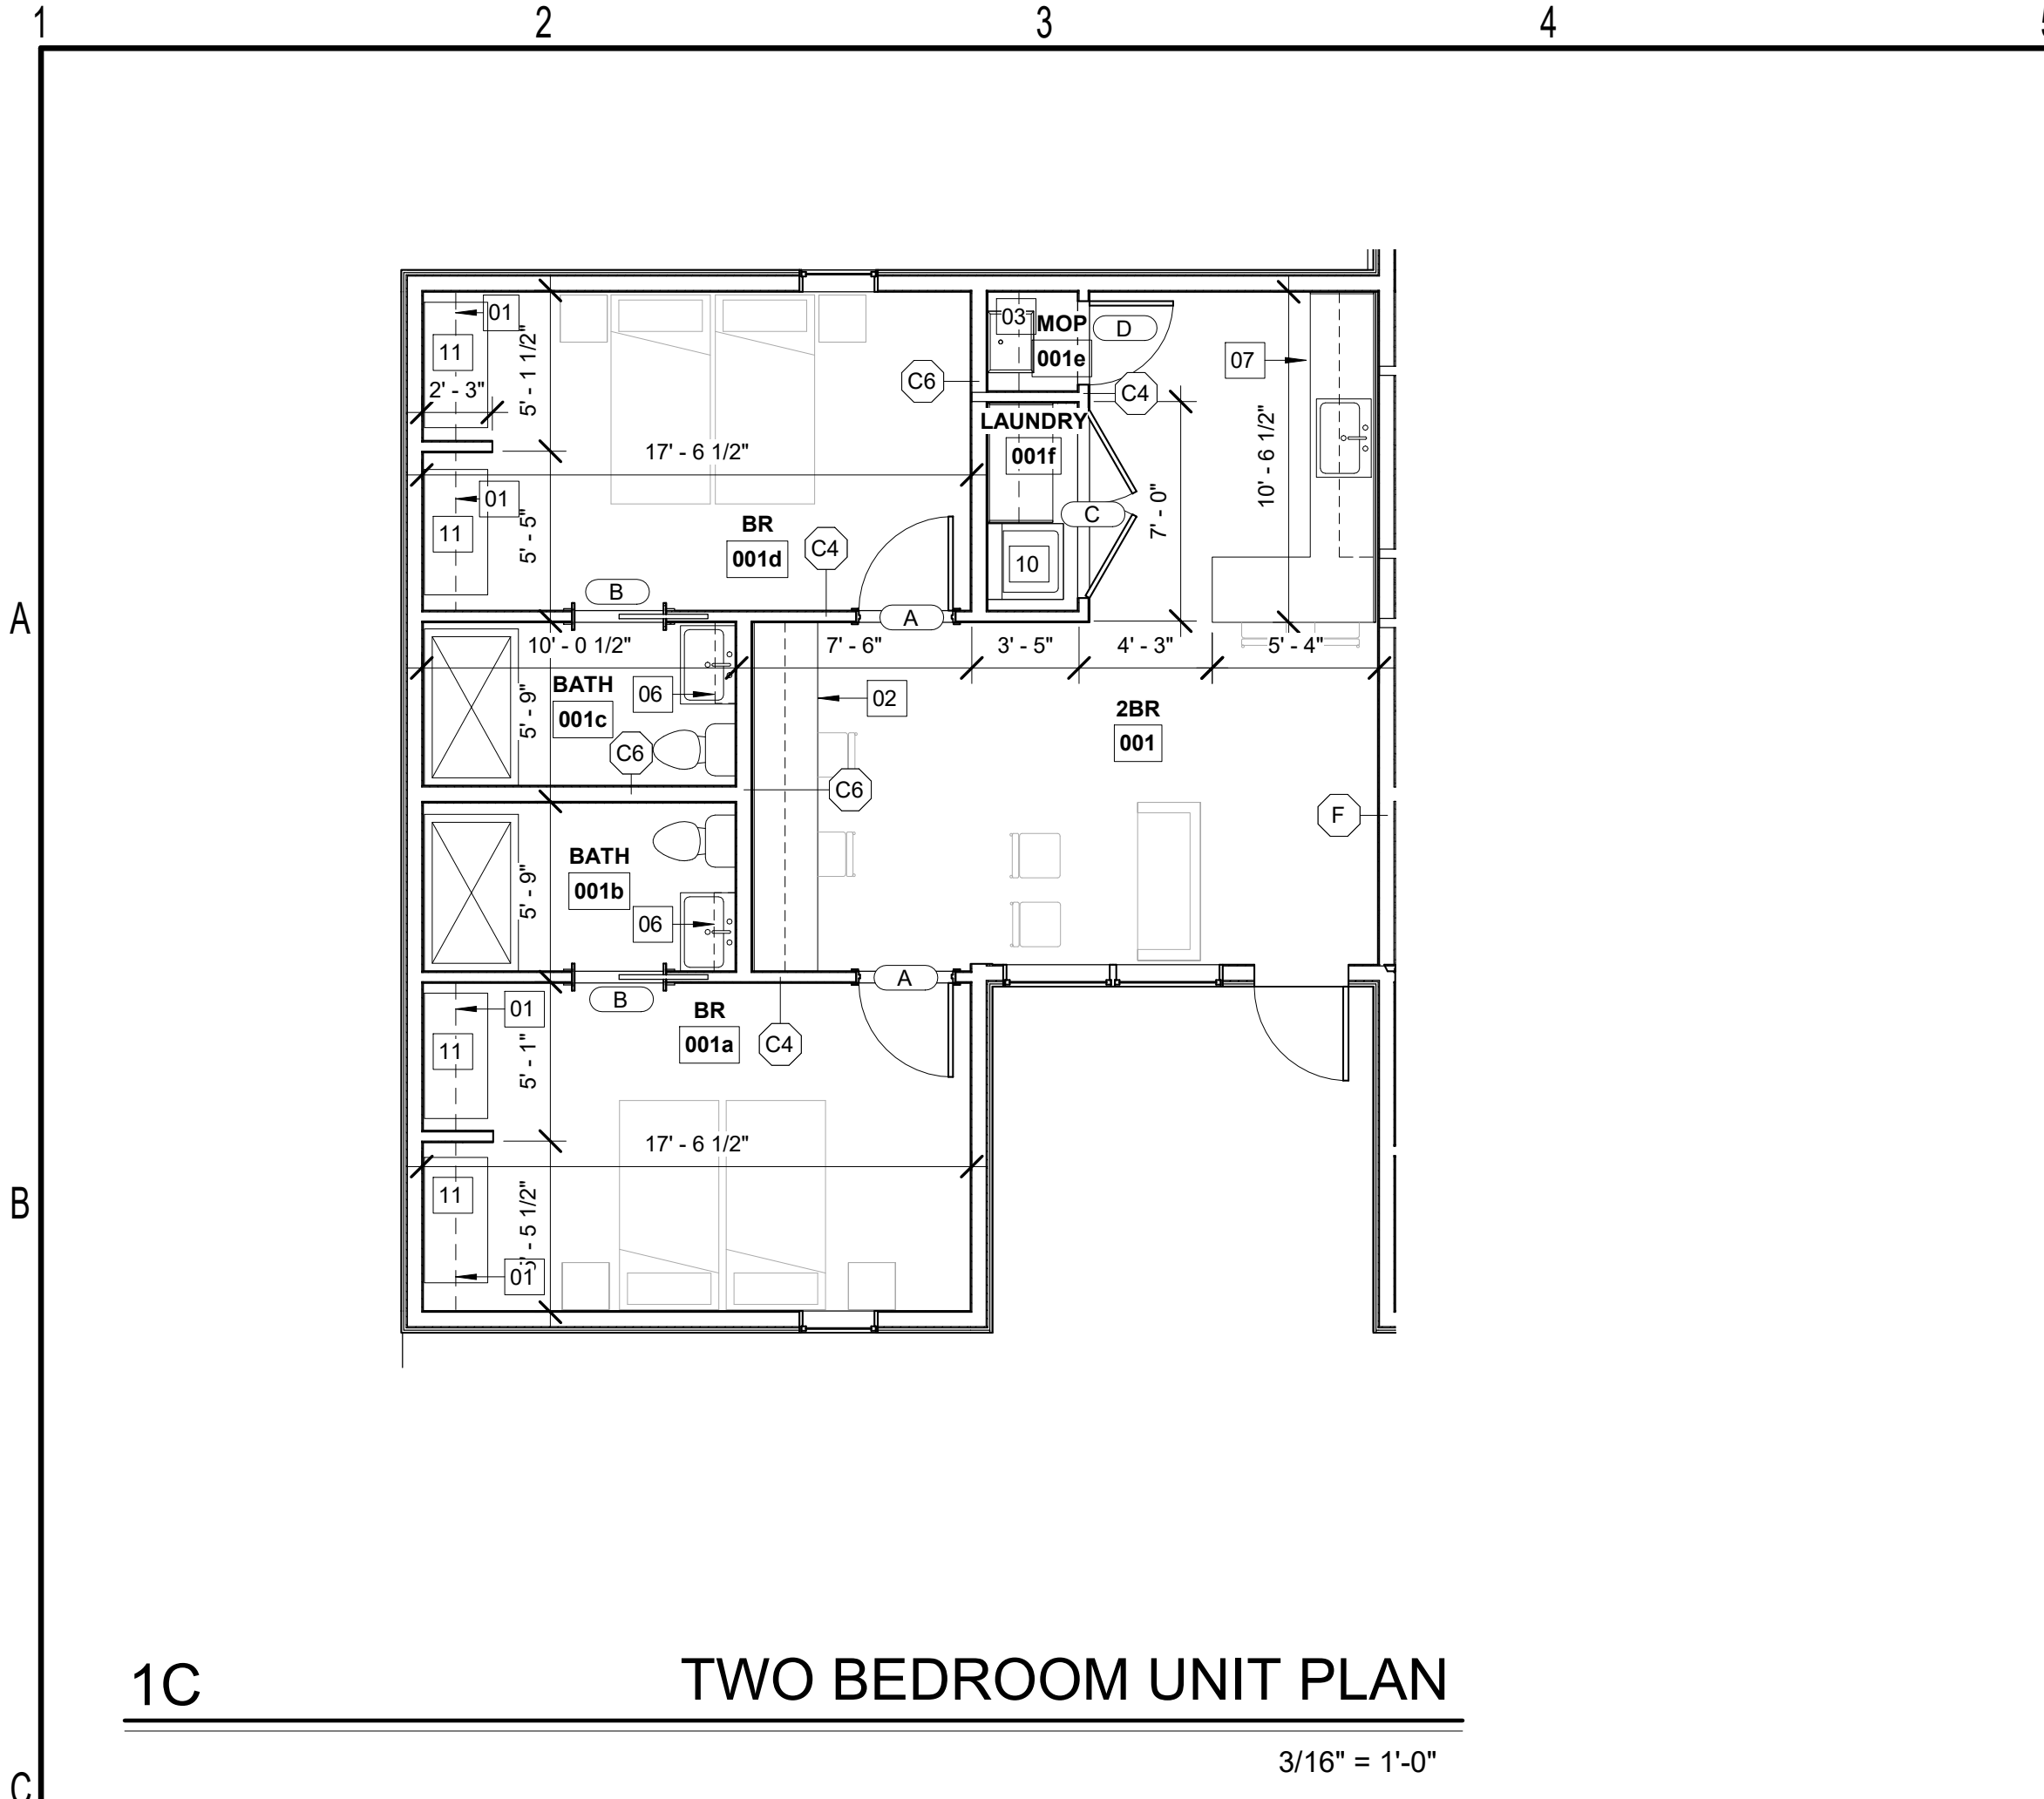
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No.	Description	Date

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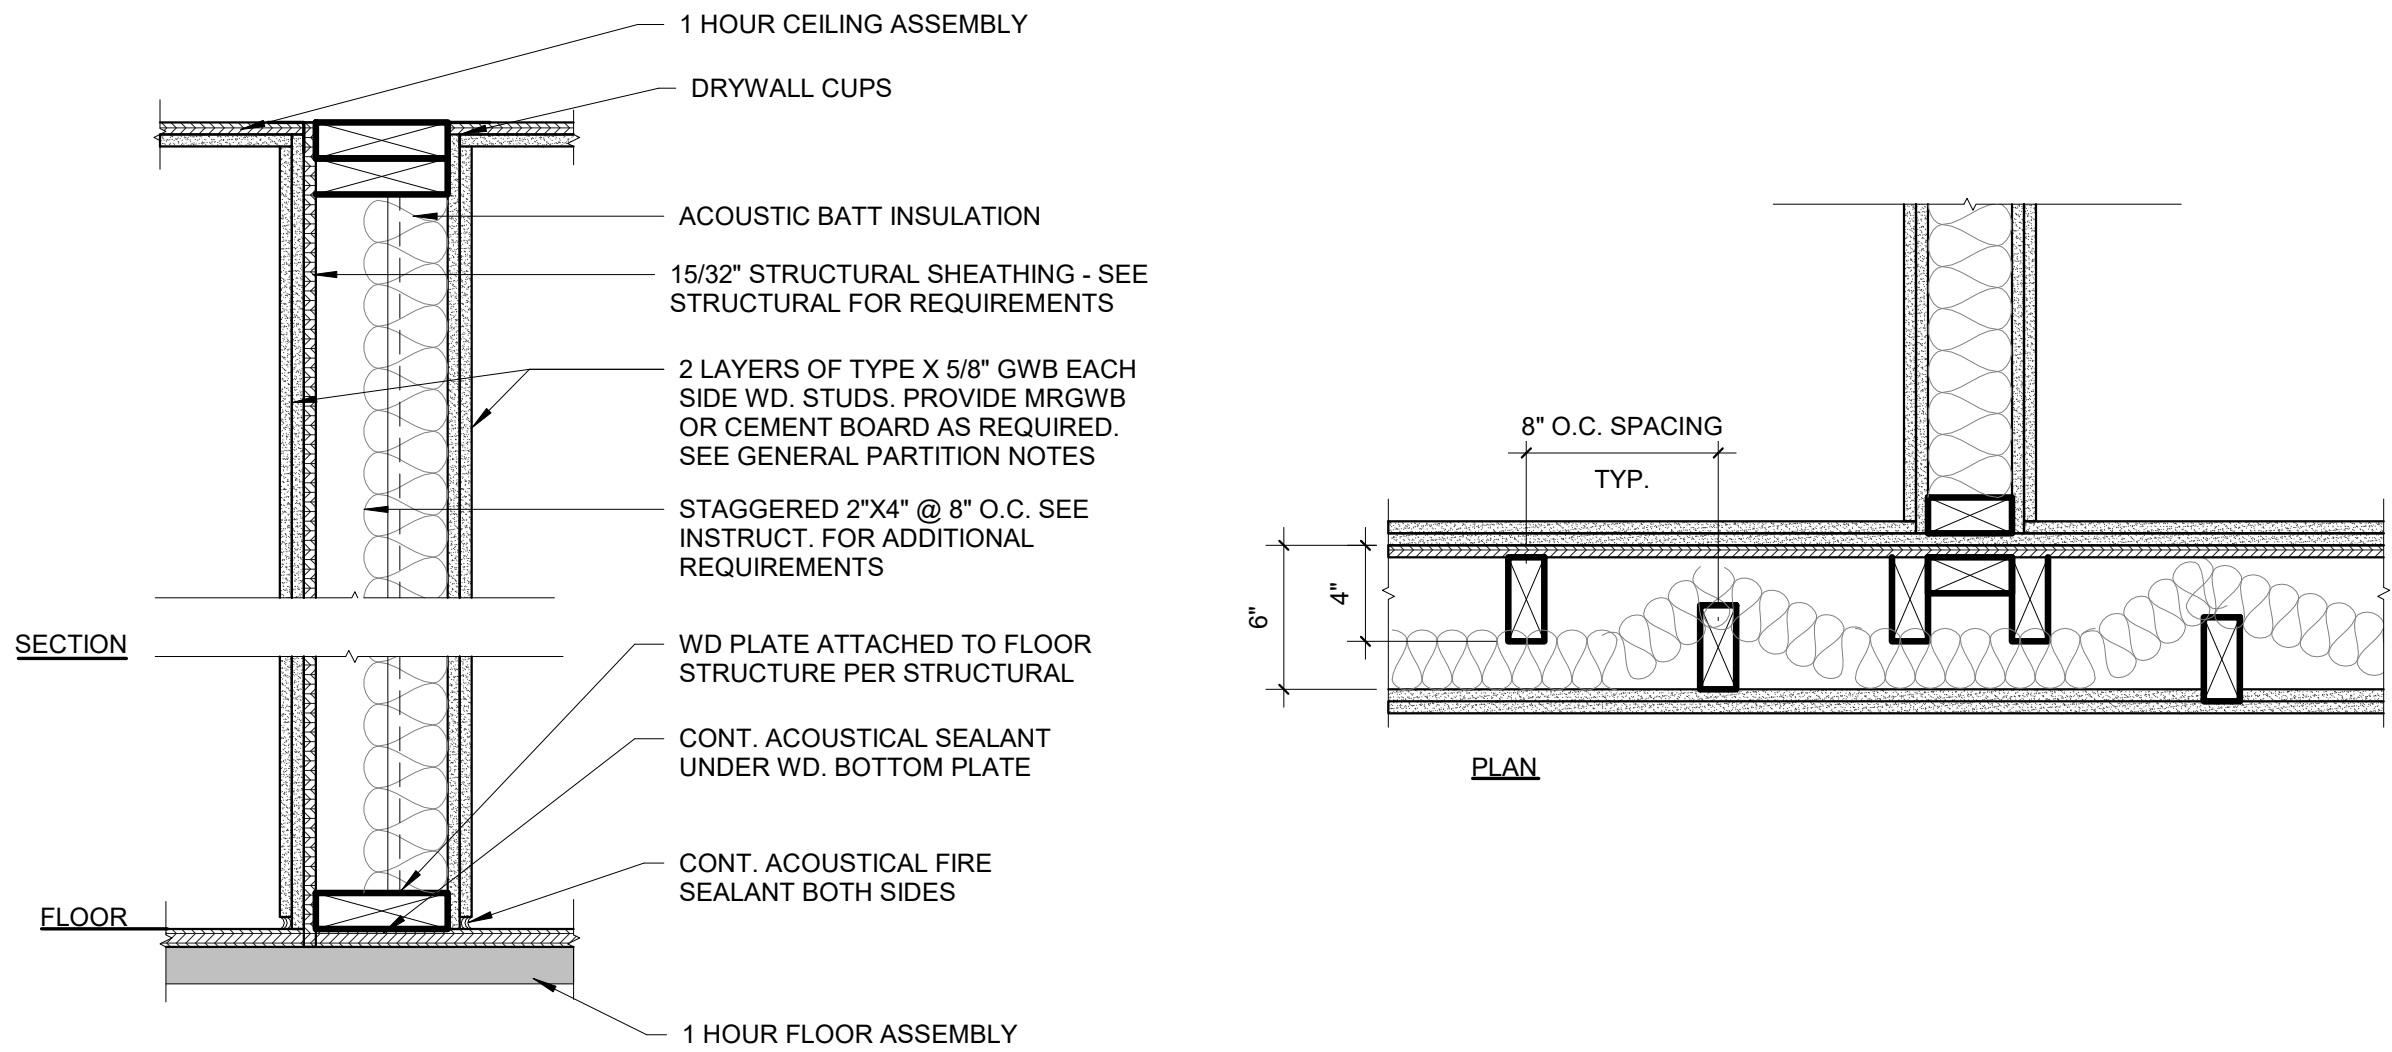
sheet title:
REFLECTED CEILING & ROOF PLANS

sheet no.:

A2.02




DOOR & FRAME SCHEDULE												
			DOOR		FRAME							
TYPE MARK	WIDTH	HEIGHT	THICKNESS	DOOR TYPE	DOOR MATERIAL	FRAME TYPE	FRAME MATERIAL	HEAD	JAMB	SILL	HARDWARE	REMARKS
MAIN LEVEL												
A	3'-0"	6'-8"	0'-1 3/4"		WD		WD					
B	3'-0"	7'-0"	0'-1 3/4"		WD		WD					POCKET DOOR
C	6'-0"	6'-8"	0'-1 3/4"		WD		WD					
D	2'-8"	6'-8"	0'-1 3/4"		WD		WD					



NOTES	UL ASSEMBLY
STUD SIZING	U340 - 1 HOUR
F6 2x6 WD STUDS STAGGERED ON 2"x8" PLATES - UNIT DIMENSING WALL	STC / NRC
	54

PARTITION - TYPE F


1 1/2" = 1'-0"

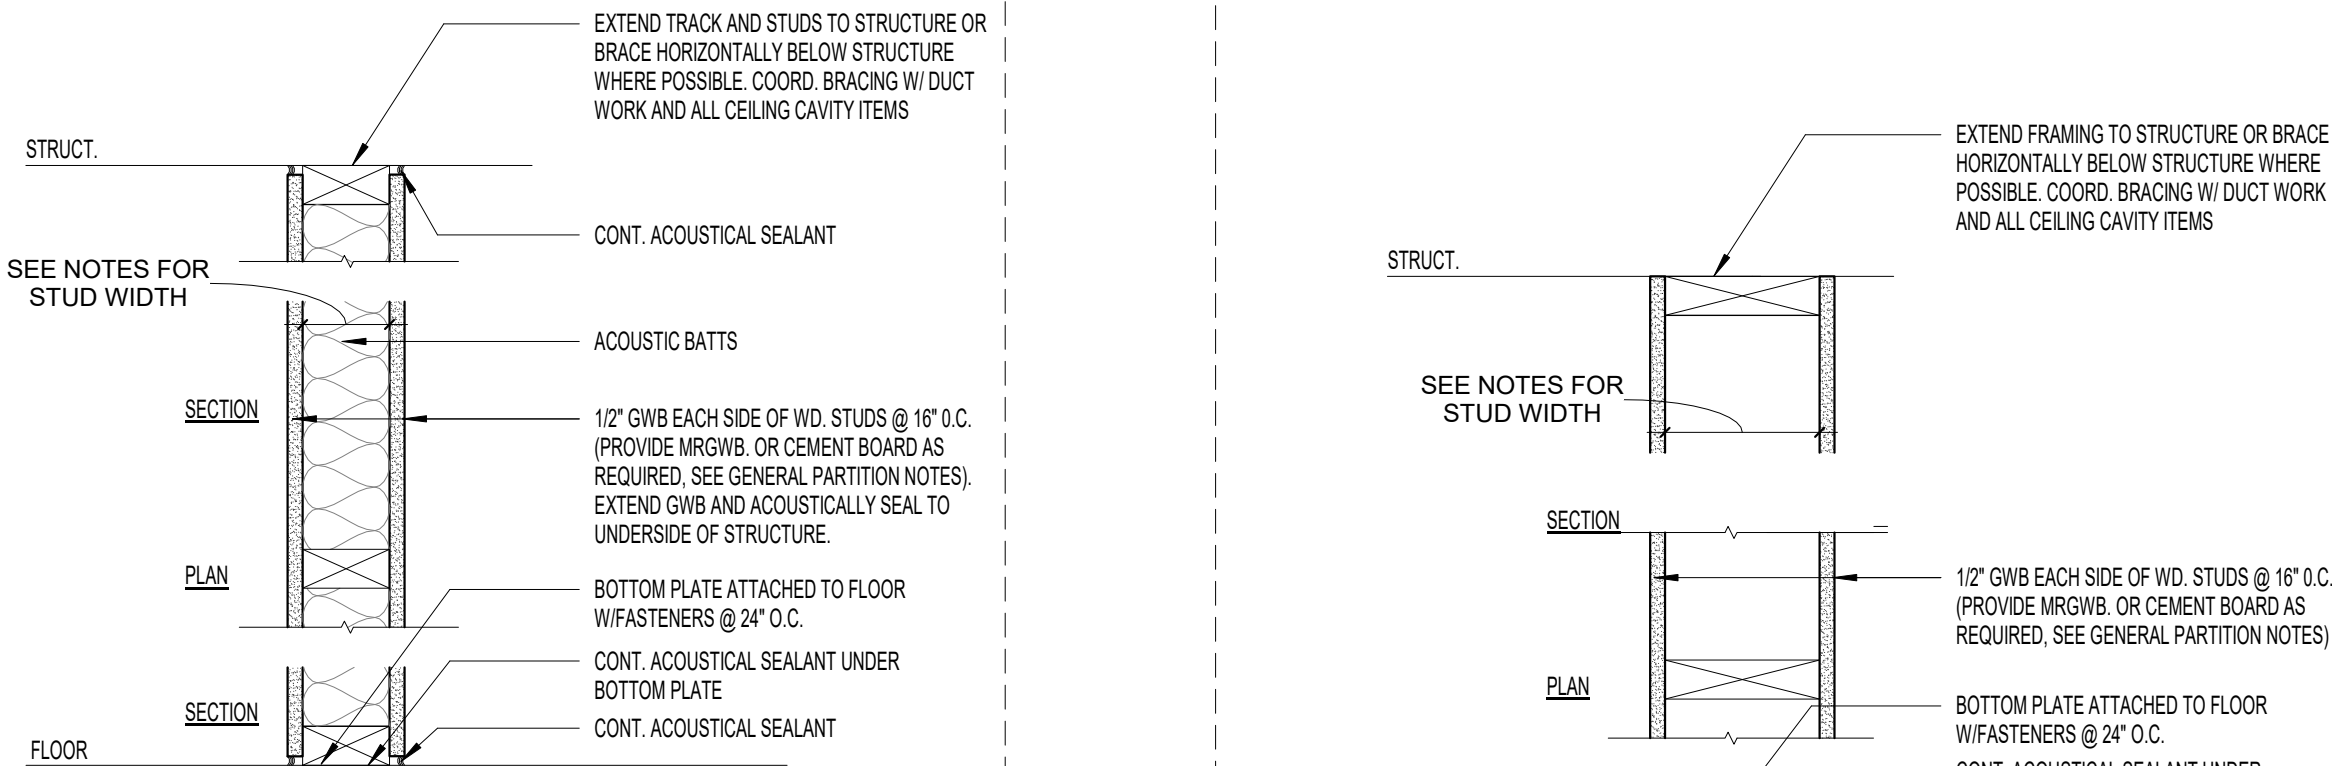

NOTES	UL ASSEMBLY
STUD SIZING	N/A
D2 2x2 WD STUDS	
D4 2x4 WD STUDS	
D6 2x6 WD STUDS	
D8 2x8 WD STUDS	
	STC / NRC
	N/A

PARTITION - TYPE D

1 1/2" = 1'-0"

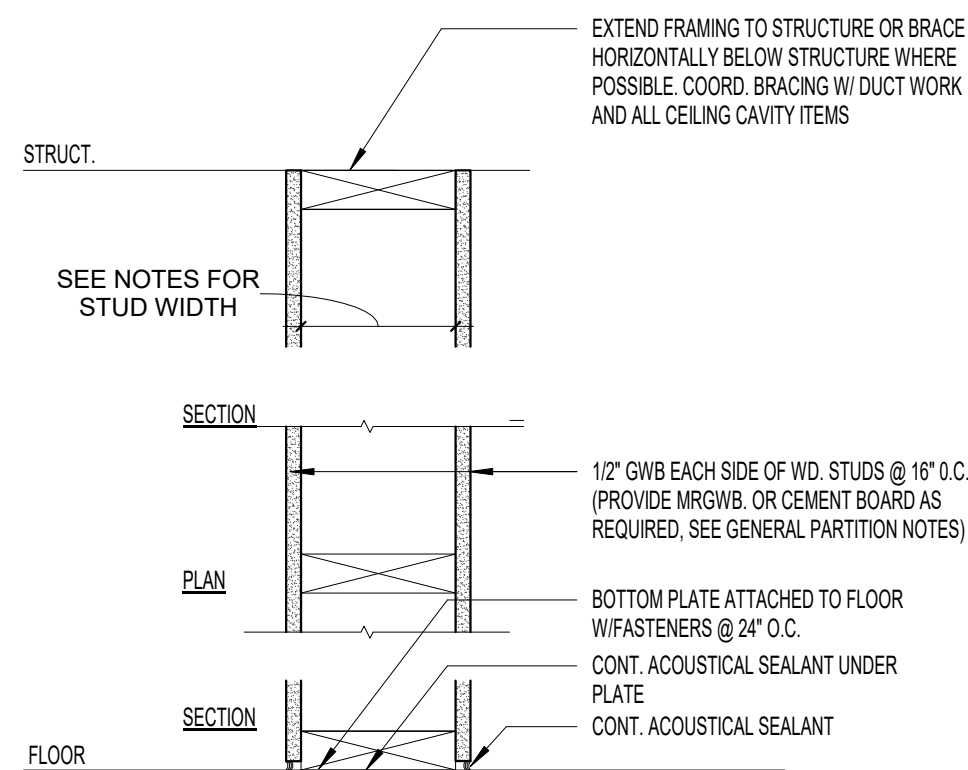

NOTES	UL ASSEMBLY
STUD SIZING	N/A
C2 2x2 WD STUDS	
C4 2x4 WD STUDS	
C6 2x6 WD STUDS	
C8 2x8 WD STUDS	
	STC / NRC
	N/A

PARTITION - TYPE C

1 1/2" = 1'-0"

KEYNOTES - UNIT PLANS

- 01 CLOSET HANGING ROD AND SHELF
- 02 11'-0" LF BUILT IN DESK W/ OVERHEAD SHELF
- 03 CLOSET SHELF AND MOP SINK
- 04 10' LF PLY01 BASE AND UPPER CABINETS AND SSM01 COUNTERTOP, INCLUDING SINK, UNDERCOUNTER MINI FRIG, AND UNDERCOUNTER MICROWAVE (REFER TO BASIS OF DESIGN SPECS)
- 05 10' LF COUNTERTOP BAR (NO BASE CABINETS)
- 06 2'-6" LF SHELF AND MIRROR
- 07 8'-5" LF PLY01 BASE AND UPPER CABINETS AND SSM01 COUNTERTOP, INCLUDING SINK, UNDERCOUNTER MINI FRIG, AND UNDERCOUNTER MICROWAVE (REFER TO BASIS OF DESIGN SPECS). W/ 5'-0" LF SSM01 COUNTERTOP BAR (NO BASE CABINETS)
- 08 2'-0" BUILT IN SHELVEING
- 09 3'-8" LF OF BASE CABINET AND UPPER SHELVEING
- 10 STACKABLE WASHER AND DRYER
- 11 CUSTOM WARDROBE ON CASTERS. REFER TO BASIS ON DESIGN CUSTOM WARDROBE AND ALTERNATE SPECIFIED

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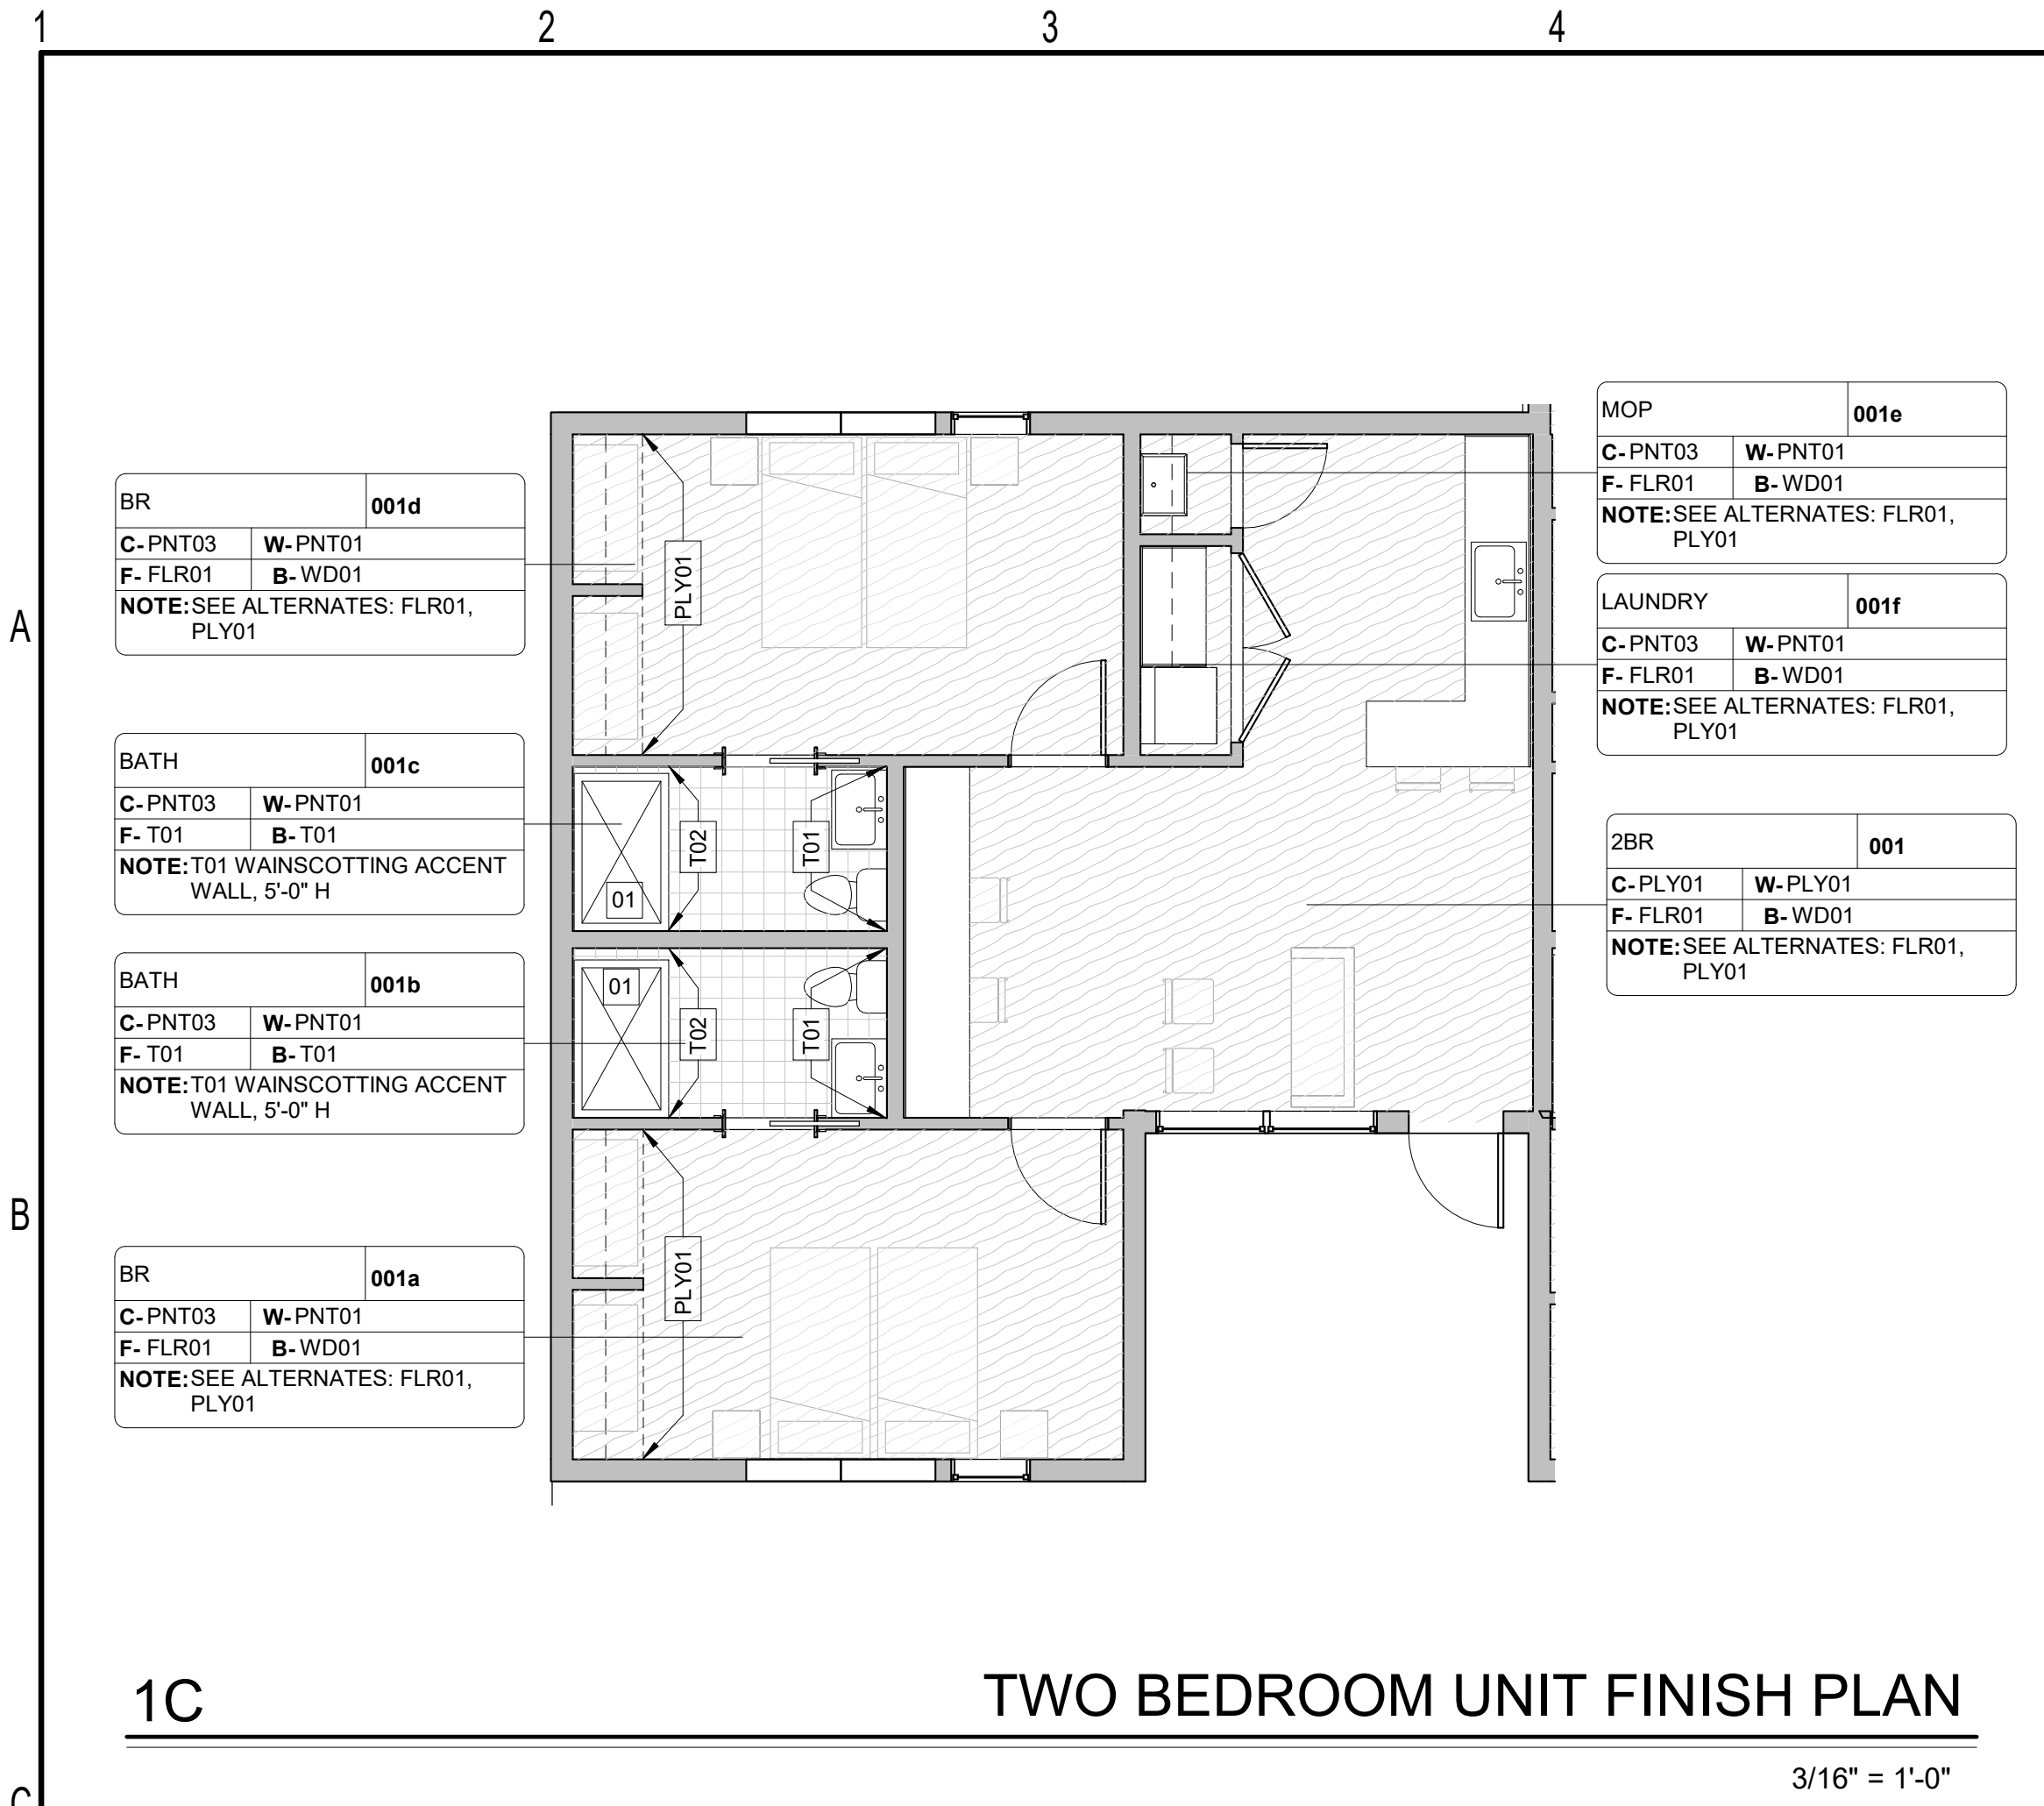
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sheet title:
TYPICAL UNIT PLANS

sheet no.:

A2.04



FINISH - FINISH LEGEND					
SYMBOL	PRODUCT	MANUFACTURER	PRODUCT # / STYLE	COLOR	NOTES
PLY01		LOCAL SUPPLIER	1/2" BALTIC BIRCH PLYWOOD	SEALED	SEE DEDUCT ALTERNATE
FLOORING					
FLR01	FLOORING	LOCAL SUPPLIER	23/32" OSB	SEALED AND STAINED	PROVIDE FLR01b W/ FLOR01. SEE ADD ALTERNATE
FLR01 (ALT 01)	FLOORING	LOCAL SUPPLIER	23/32" ADVANTECH OSB	SEALED AND STAINED	ADVANTECH: PRICE AS ADD ALTERNATE
FLOORING UNDERLAYMENT					
FLR01b	FLOORING UNDERLAYMENT	LEGGETT & PLATT	WHISPER STEP ACOUSTICAL UNDERLAYMENT		PROVIDE AT ALL AREAS W/ FLR01
GROUT					
GR01	GROUT	TBD	POLYMER MODIFIED SANDED GROUT	TO BE SELECTED FROM MANUFACTURER'S FULL RANGE	MUST MEET ANSI A118.7
GYPSUM CEILING					
GW01	GYPSUM CEILING	LOCAL SUPPLIER	5/8" GWB	PNT05	
OSB					
WD01	OSB	LOCAL SUPPLIER		SEALED AND STAINED	6" OSB BASE
OSB SHEET					
OSB (ALT FOR PLY01)	OSB SHEET	LOCAL SUPPLIER	23/32 OSB	SEALED	
PAINT, EG-SHEL					
PNT01	PAINT, EG-SHEL	SHERWIN WILLIAMS	PRO MAR 200 ZERO VOC INTERIOR LATEX	TO BE SELECTED FROM MANUFACTURER'S FULL RANGE	INTERIOR WALLS
PAINT, FLAT					
PNT03	PAINT, FLAT	SHERWIN WILLIAMS	PROMAR 200 ZERO VOC INTERIOR LATEX	HIGH REFLECTIVE WHITE SW 7757	GYPSUM CEILING AND SOFFITS
PAINT, SEMI-GLOSS					
PNT02	PAINT, SEMI-GLOSS	SHERWIN WILLIAMS	PROCLASSIC INTERIOR WATERBASED ACRYLIC ALKYD ENAMEL	TO BE SELECTED FROM MANUFACTURER'S FULL RANGE	INTERIOR WOOD DOORS AND TRIM
SIMULATED STONE MATERIAL					
SSM01	SIMULATED STONE MATERIAL	CAMBRIA	2CM QUARTZ	SKARA BREA	COUNTERTOP EDGE TO BE 1.5" MITER EDGE
TILE					
T01	TILE	BEST TILE	ORIGIN (12"x24")	CANYON	FLOOR TILE TO BE INSTALLED ASHLAR; GROUT TO BE GR01
T02	TILE	BEST TILE	STYLE (6" x 24")	PURE	WALL TILE TO BE INSTALLED STACKED; GROUT TO BE GR01

GENERAL NOTES - FINISH PLAN

- CONTRACTOR SHALL PROVIDE ALL INTERIOR FINISHES AS SPECIFIED. ARCHITECT SHALL BE NOTIFIED OF ANY DISCREPANCIES OR OMISSIONS PRIOR TO PROCEEDING WITH WORK.
- ALL INTERIOR FINISHES SHALL HAVE A CLASS A FLAME SPREAD RATING OR BETTER.
- CONTRACTOR SHALL BE SOLELY RESPONSIBLE FOR THE ACCURACY OF THEIR MEASUREMENTS AND TOTAL YARDAGE REQUIREMENTS TO BE FURNISHED.
- VARIATIONS IN FLOOR LEVEL IN EXCESS OF 1 INCH FOR EVERY 10 FEET SHALL BE LEVELED BY CONTRACTOR. LEVELING SHALL BE COMPLETED WITH FLOOR READY TO RECEIVE NEW FINISHES AS SPECIFIED. CONTRACTOR SHALL VERIFY SLAB CONDITION PRIOR TO PRICE SUBMISSION.
- ALL MISC. GRILLES, PLATES, OR OTHER DEVICES SHALL BE PAINTED TO MATCH THE WALL OR CEILING IN WHICH THEY ARE INSTALLED.
- ALL NEW AND EXISTING FINISHES SCHEDULED TO REMAIN SHALL BE PROTECTED DURING CONSTRUCTION. ANY DAMAGE SHALL BE REPAIRED BY CONTRACTOR INVOLVED AT HIS COST WITH NO COST TO OWNER.
- PROVIDE ATTIC STOCK AS FOLLOWS:
ACOUSTICAL CEILING TILE 10%
CERAMIC TILE 10%
RESILIENT MATERIALS (1) UNOPENED CARTON OF EACH COLOR & TYP.
PAINT ONE GALLON OF EACH COLOR AND FINISH
- CONTRACTOR TO PROVIDE STITCH DESIGN SHOP WITH FINISH SUBMITTALS PRIOR TO ORDERING OR INSTALLING ANY FINISHES
- GC TO PROVIDE SEAMING DIAGRAM / SHOP DRAWINGS PRIOR TO INSTALLATION FOR ARCHITECT TO REVIEW.

KEYNOTES - FINISH PLAN

- 01 REFER TO BASIS OF DESIGN IN FINISH NARRATIVE: SHOWER BASE PAN W/ T02 TILE SURROUND, PROVIDE DEDUCT ALTERNATE PRICING FOR BASIS OF DESIGN SHOWER STALL IN FINISH NARRATIVE.
- 02 --
- 03 --
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GEN NOTES - FINISH PLAN

- 01 REFER TO BASIS OF DESIGN SPECIFICATIONS IN DESIGN NARRATIVE FOR FINISHES, EQUIPMENT AND FIXTURES.

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SCHEMATIC DESIGN

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FINISH UNIT FLOOR PLANS & FINISH LEGEND

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A4.01

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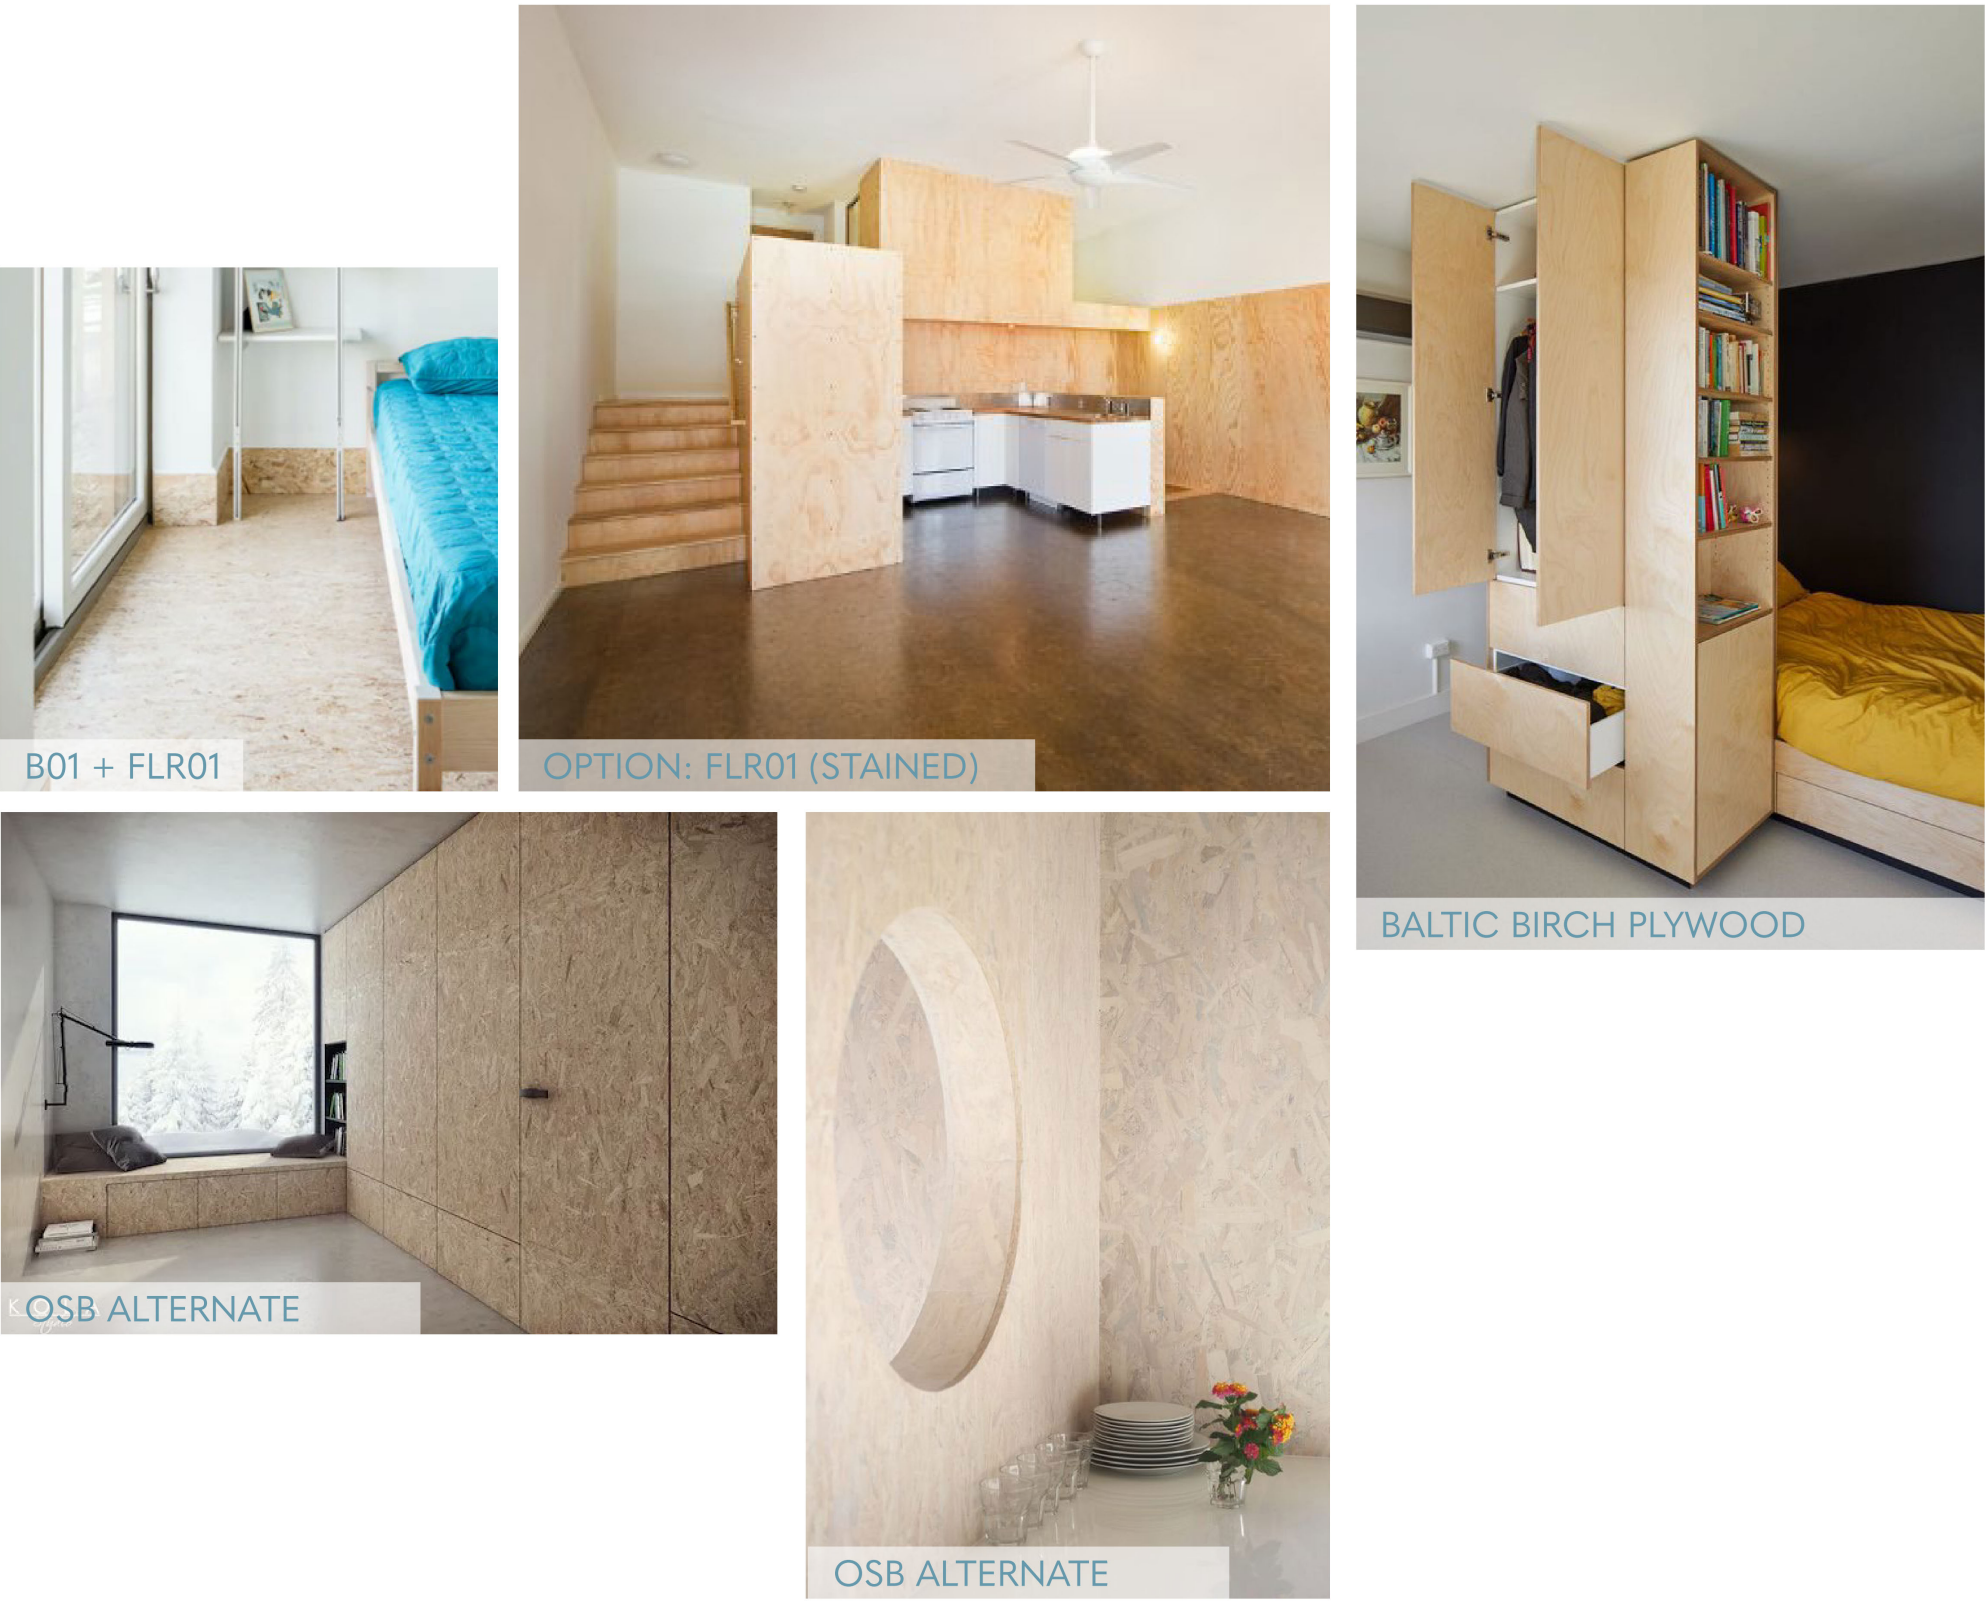
commission: 0054

sheet title:

FINISH NARRATIVE

sheet no.:

A4.02



PRECEDENT IMAGERY



FLOORING

FLR 01

MFR: Local Supplier

Style: 23/32" OSB

Color: Stained and Sealed

BASEBOARD:

B01 (typical throughout U.N.O.)

MFR: Local Supplier

Style: 6" OSB

Color: Sealed and stained



FINISH NARRATIVE

TILE

T01

MFR: Best Tile

Style: Origin

Type: Porcelain Tile

Color: Canyon

Size: 12x24

T02

MFR: Best Tile

Style: Style

Type: Porcelain Tile

Color: Pure

Size: 6x24

WALL FINISH

GW B (typical U.N.O.)

MFR: Local Supplier

Style: 5/8" GWB

Color: Paint as specified

PLY01 (typical U.N.O.)

MFR: Local Supplier

Style: 1/2" Baltic Birch Plywood

Color: Sealed

OSB01 (alternate for PLY01)

MFR: Local Supplier

Style: 23/32"OSB

Color: Sealed and Stained

PAINT:

PNT01 (typical walls)

MFR: Sherwin-Williams

Spec: ProMar 200 Zero VOC Interior Latex

Color: To Be Selected from Full Range

Sheen: Eg-Shel

PNT02 (doors & trim)

MFR: Sherwin-Williams

Spec: ProClassic Interior Waterbased Acrylic-Alkyd Enamel

Color: To Be Selected from Full Range

Sheen: Semi-Gloss

PNT03 (gwb ceilings & soffits)

MFR: Sherwin-Williams

Spec: ProMar 200 Zero VOC Interior Latex

Color: High Reflective White SW 7757 (typ.)

Sheen: Flat

TYPICAL EQUIPMENT:

Microwave

MFR: Frigidaire (or approved alternate)

Style: Built-in Microwave

Color: Smudge-Proof Stainless Steel

Undercounter Refrigerator

MFR: Summit (or approved alternate)

Style: 32" Undercounter ADA Compliant

Color: Black

(alternate) Undercounter Drawer Refrigerator/Freezer

MFR: Summit (or approved alternate)

Style: 24" Undercounter Drawer Refrigerator



PLUMBING FIXTURES

PLMB01

MFR: American Standard

Style: Origin

Type: Single Threshold ADA Shower Base

Color: White

Size: 64X34

PLMB01 ALT:

MFR: Aquatic

Style: Accessible Acrylic

Type: 1 piece ADA Shower Stall

Color: White

Size: 60x34x79



T02



PLMB01




CUSTOM FURNITURE

CUSTOM MOBILE WARDROBE

MFR: Custom

Color: Birch Plywood

Size: 48"W x 24"D x 72"H

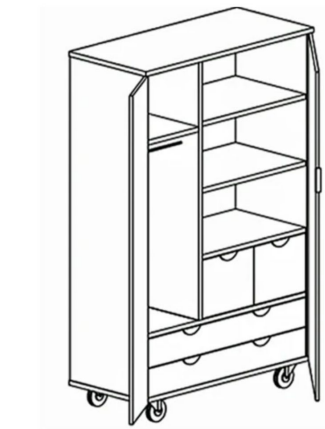

(alternate) MOBILE WARDROBE


MFR: ACE Office Systems

Style: CA376 Deluxe Heavy-Duty Mobile Storage/Wardrobe Cabinet

Color: 140 Hard Rock Maple

Size: 48"W x 24"D x 72"H



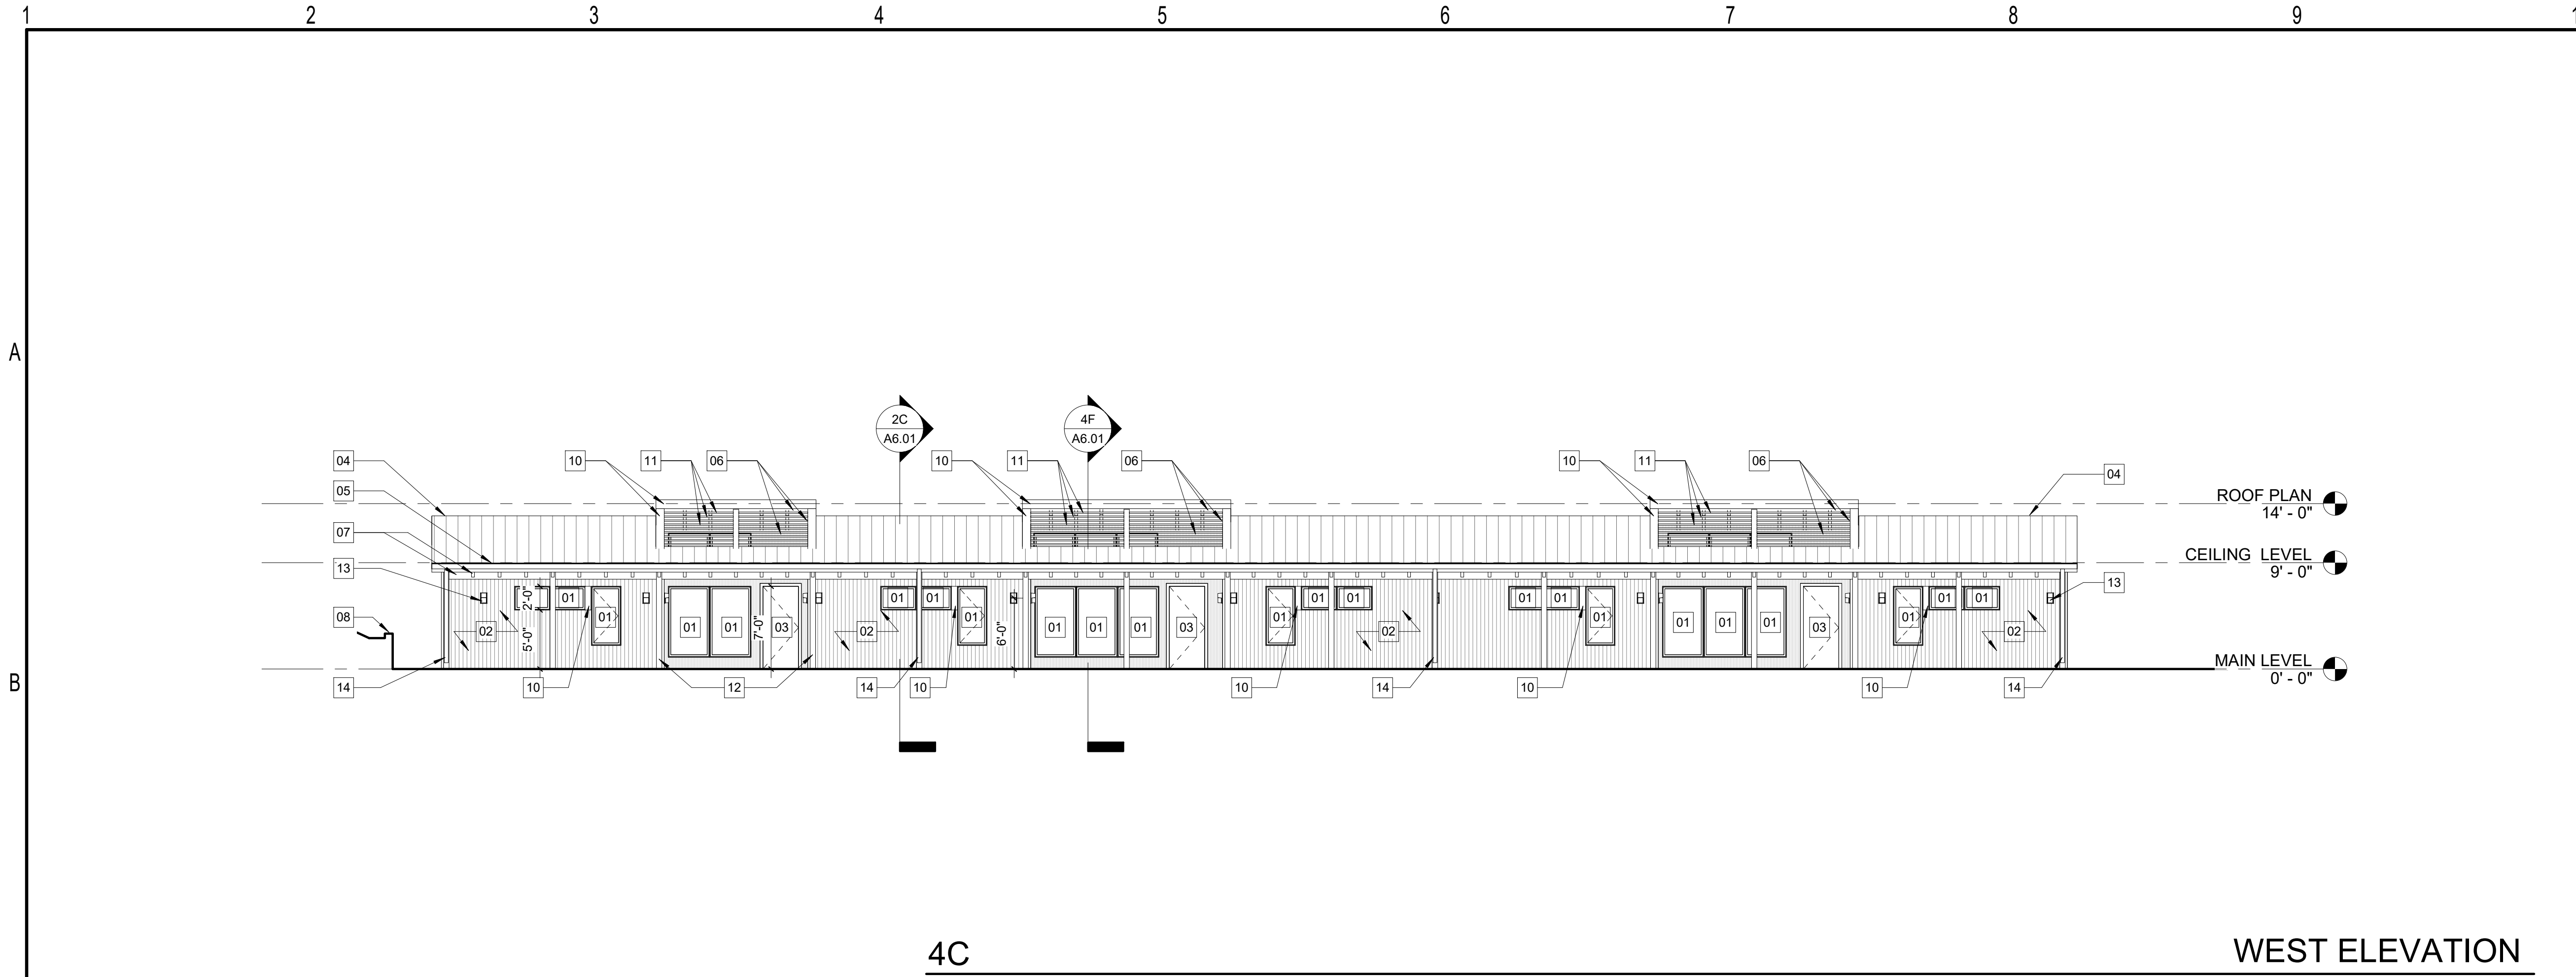

KEYED NOTES - ELEVATION

- 01 ALUMINUM CLAD WOOD
WINDOWS, CASEMENTS AND
AWNINGS AS SHOWN ON
ELEVATIONS, PREFINISHED BLACK
- 02 24GA PREFINISHED
CORRUGATED
METAL PANEL CLADDING W/
EXPOSED FASTENERS, BASIS OF
DESIGN: ATAS CORRUGATED
PANEL, FINISH COLOR:
ANTIQUÉ PATINA
- 03 INSULATED FIBERGLASS
EXTERIOR FLUSH DOOR,
PAINTED SW7076 CYBERSPACE
- 04 24GA STRIATED STANDING
SEAM METAL ROOF,
PREFINISHED SW7069 IRON ORE
- 05 PREFINISHED ALUMINUM BOX
GUTTER, PREFINISHED SW7069
IRON ORE
- 06 EQUITONE VERTICAL FINISH
LINEA; LT85 GRAPHITE 4X10
PANELS
- 07 PRESSURE TREATED WOOD
STRUCTURAL SUPPORT, FINISH
TBD
- 08 CAST IN PLACE CONCRETE SITE
WALL, SEE CIVIL
- 09 WRAPPING STRANDING SEAM
METAL PREFINISHED SW7069
IRON ORE
- 10 ALUMINUM MATTE PREFINISHED
SW7069 IRON ORE
- 11 2X5 ALUMINUM TUBES
PREFINISHED SW7069 IRON ORE
- 12 WRAPPED ENGINEERED POSTS;
FINISH TBD
- 13 OUTDOOR WALL SCENCE; BASIS
OF DESIGN: ALVA BRIAN, LONG
PANEL, MATTE BLACK
- 14 PREFINISHED METAL
DOWNSPOUT,
FINISH COLOR TO MATCH
GUTTER

- 15 --
- 16 --
- 17 --
- 18 --
- 19 --
- 20 --

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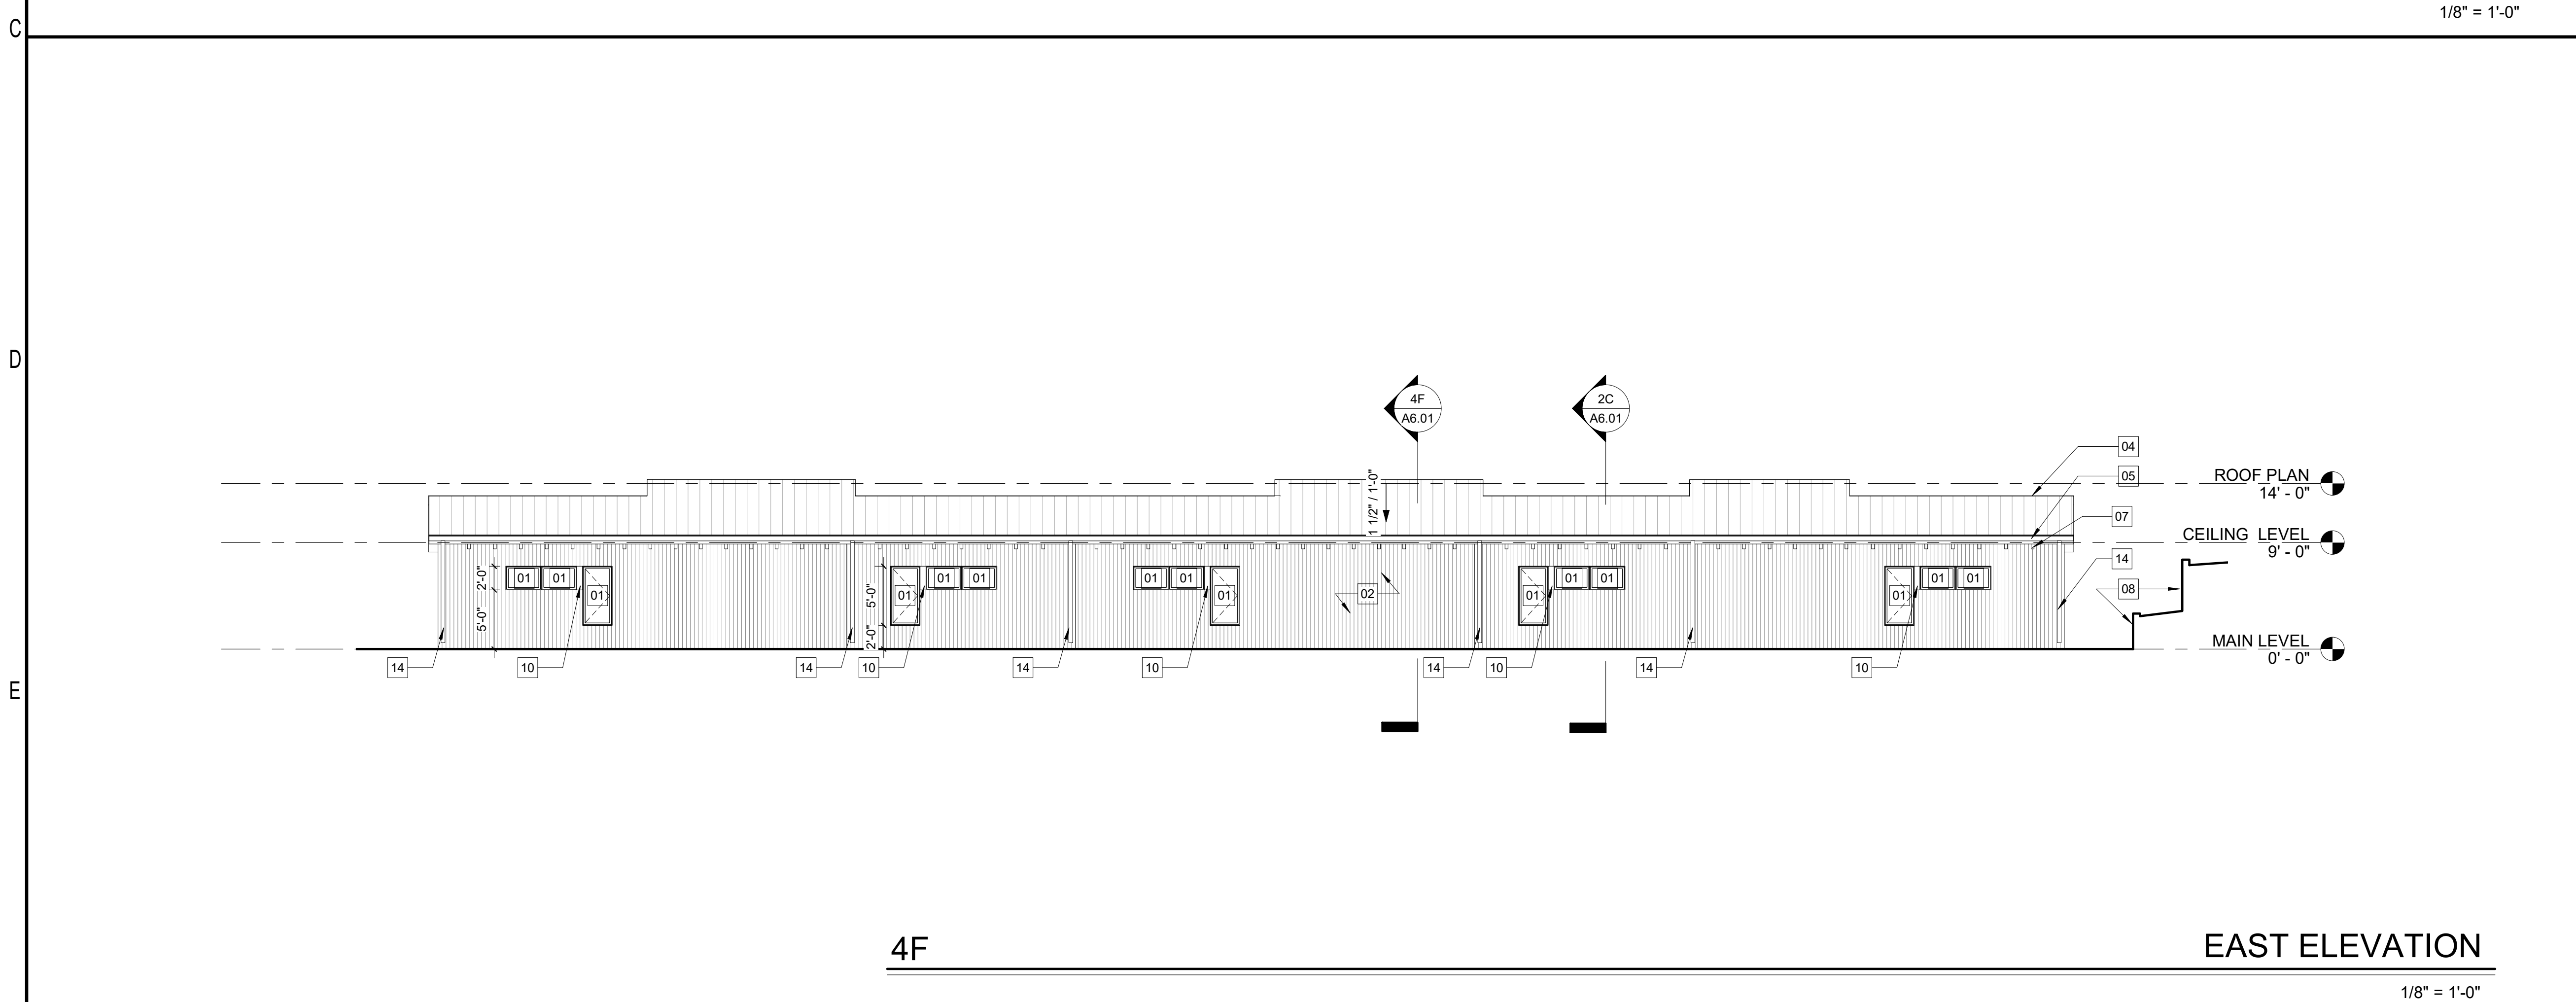
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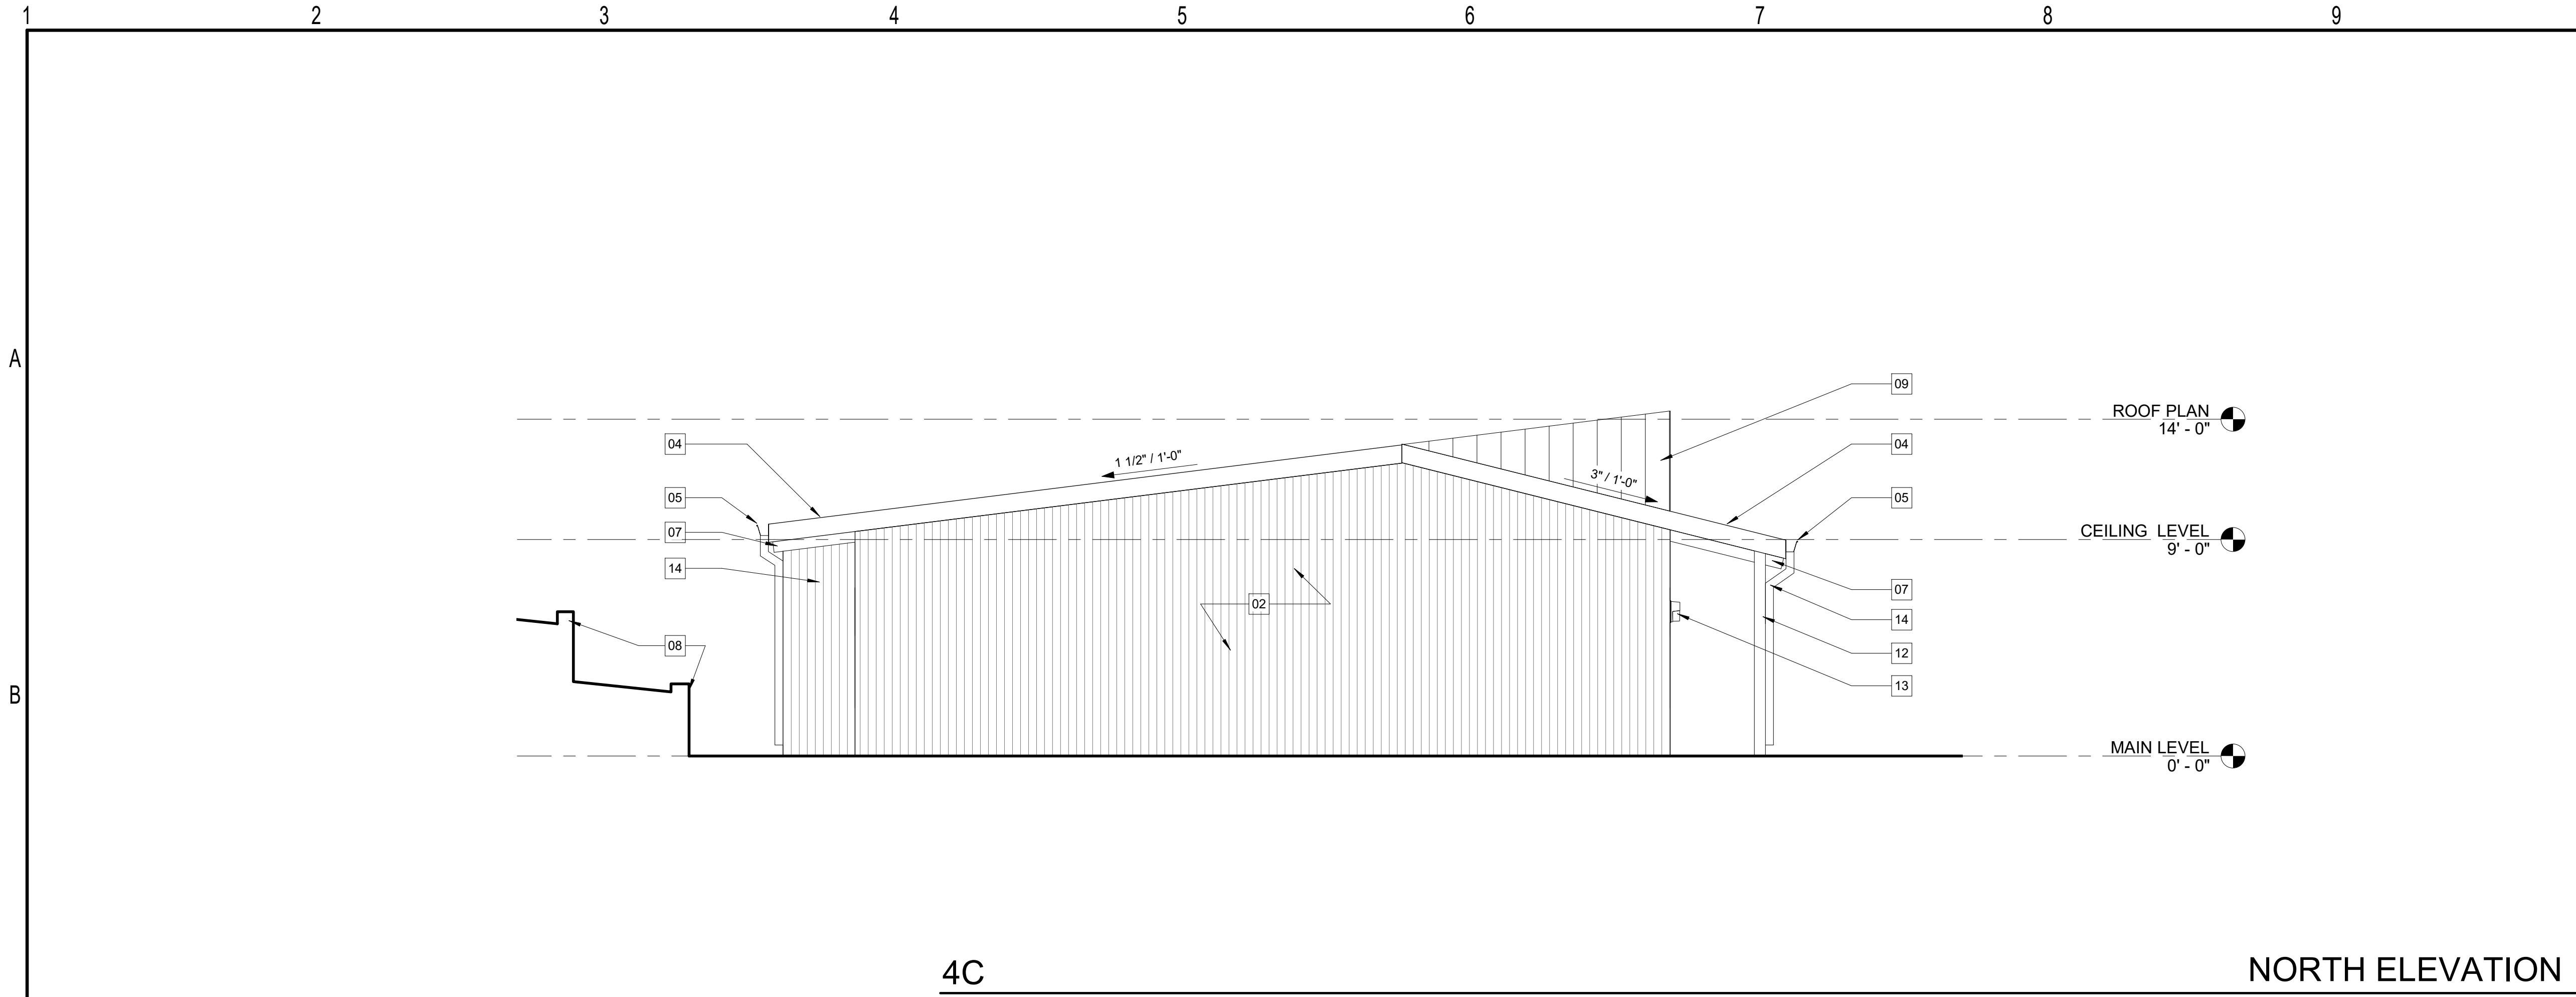
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EXTERIOR ELEVATIONS

sheet no.:
A5.01





KEYED NOTES - ELEVATION

- 01 ALUMINUM CLAD WOOD WINDOWS; CASEMENTS AND AWNINGS AS SHOWN ON ELEVATIONS; PREFINISHED BLACK
- 02 24GA PREFINISHED CORRUGATED METAL PANEL CLADDING W/ EXPOSED FASTENERS; BASIS OF DESIGN: ATAS CORRUGATED PANEL; FINISH COLOR: ANTIQUE PATINA
- 03 INSULATED FIBERGLASS EXTERIOR FLUSH DOOR, PAINTED SW7076 CYBERSPACE
- 04 24GA STRIATED STANDING SEAM METAL ROOF, PREFINISHED SW7069 IRON ORE
- 05 PREFINISHED ALUMINUM BOX GUTTER, PREFINISHED SW7069 IRON ORE
- 06 EQUITONE VERTICAL FINISH LINEA; LT85 GRAPHITE 4X10 PANELS
- 07 PRESSURE TREATED WOOD STRUCTURAL SUPPORT, FINISH TBD
- 08 CAST IN PLACE CONCRETE SITE WALL; SEE CIVIL
- 09 WRAPPING STRANDING SEAM METAL PREFINISHED SW7069 IRON ORE
- 10 ALUMINUM MATTE PREFINISHED SW7069 IRON ORE
- 11 2X5 ALUMINUM TUBES PREFINISHED SW7069 IRON ORE
- 12 WRAPPED ENGINEERED POSTS; FINISH TBD
- 13 OUTDOOR WALL SCENCE; BASIS OF DESIGN: ALVA BRIAN, LONG PANEL, MATTE BLACK
- 14 PREFINISHED METAL DOWNSPOUT, FINISH COLOR TO MATCH GUTTER
- 15 --
- 16 --
- 17 --
- 18 --
- 19 --
- 20 --



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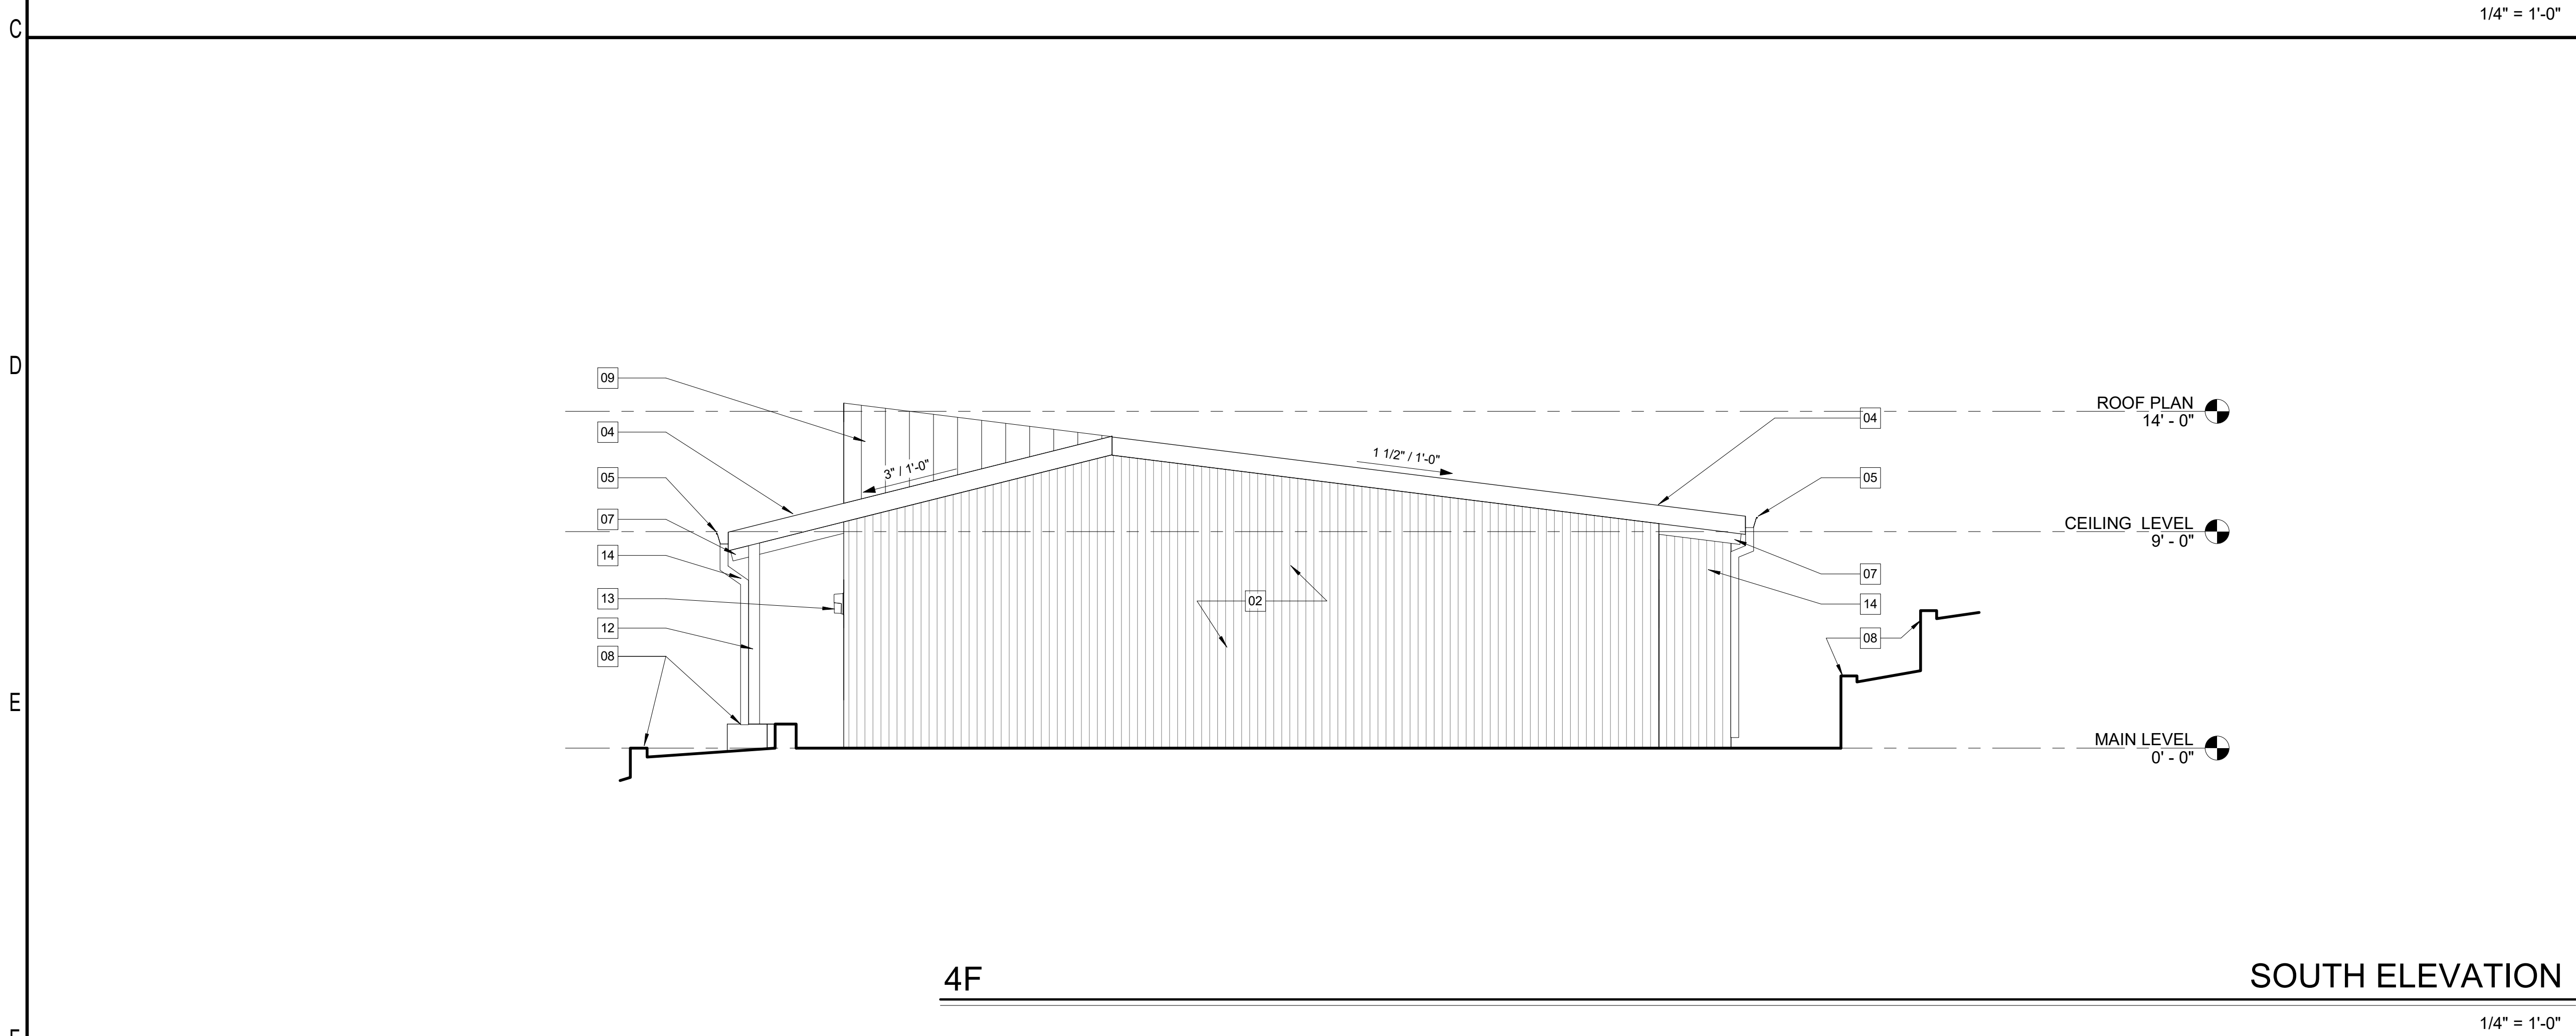
SCHEMATIC DESIGN

Revisions		
No.	Description	Date

date: 12-04-2023
commission: 0054

sheet title:
EXTERIOR ELEVATIONS

sheet no.:
A5.02



1 2 3 4 5 6 7 8 9 10 11

A

B

C



4C

WEST PERSPECTIVE

NOT TO SCALE

D

E

F



4F

FRONT VIEW

NOT TO SCALE

STITCH
DESIGN SHOP

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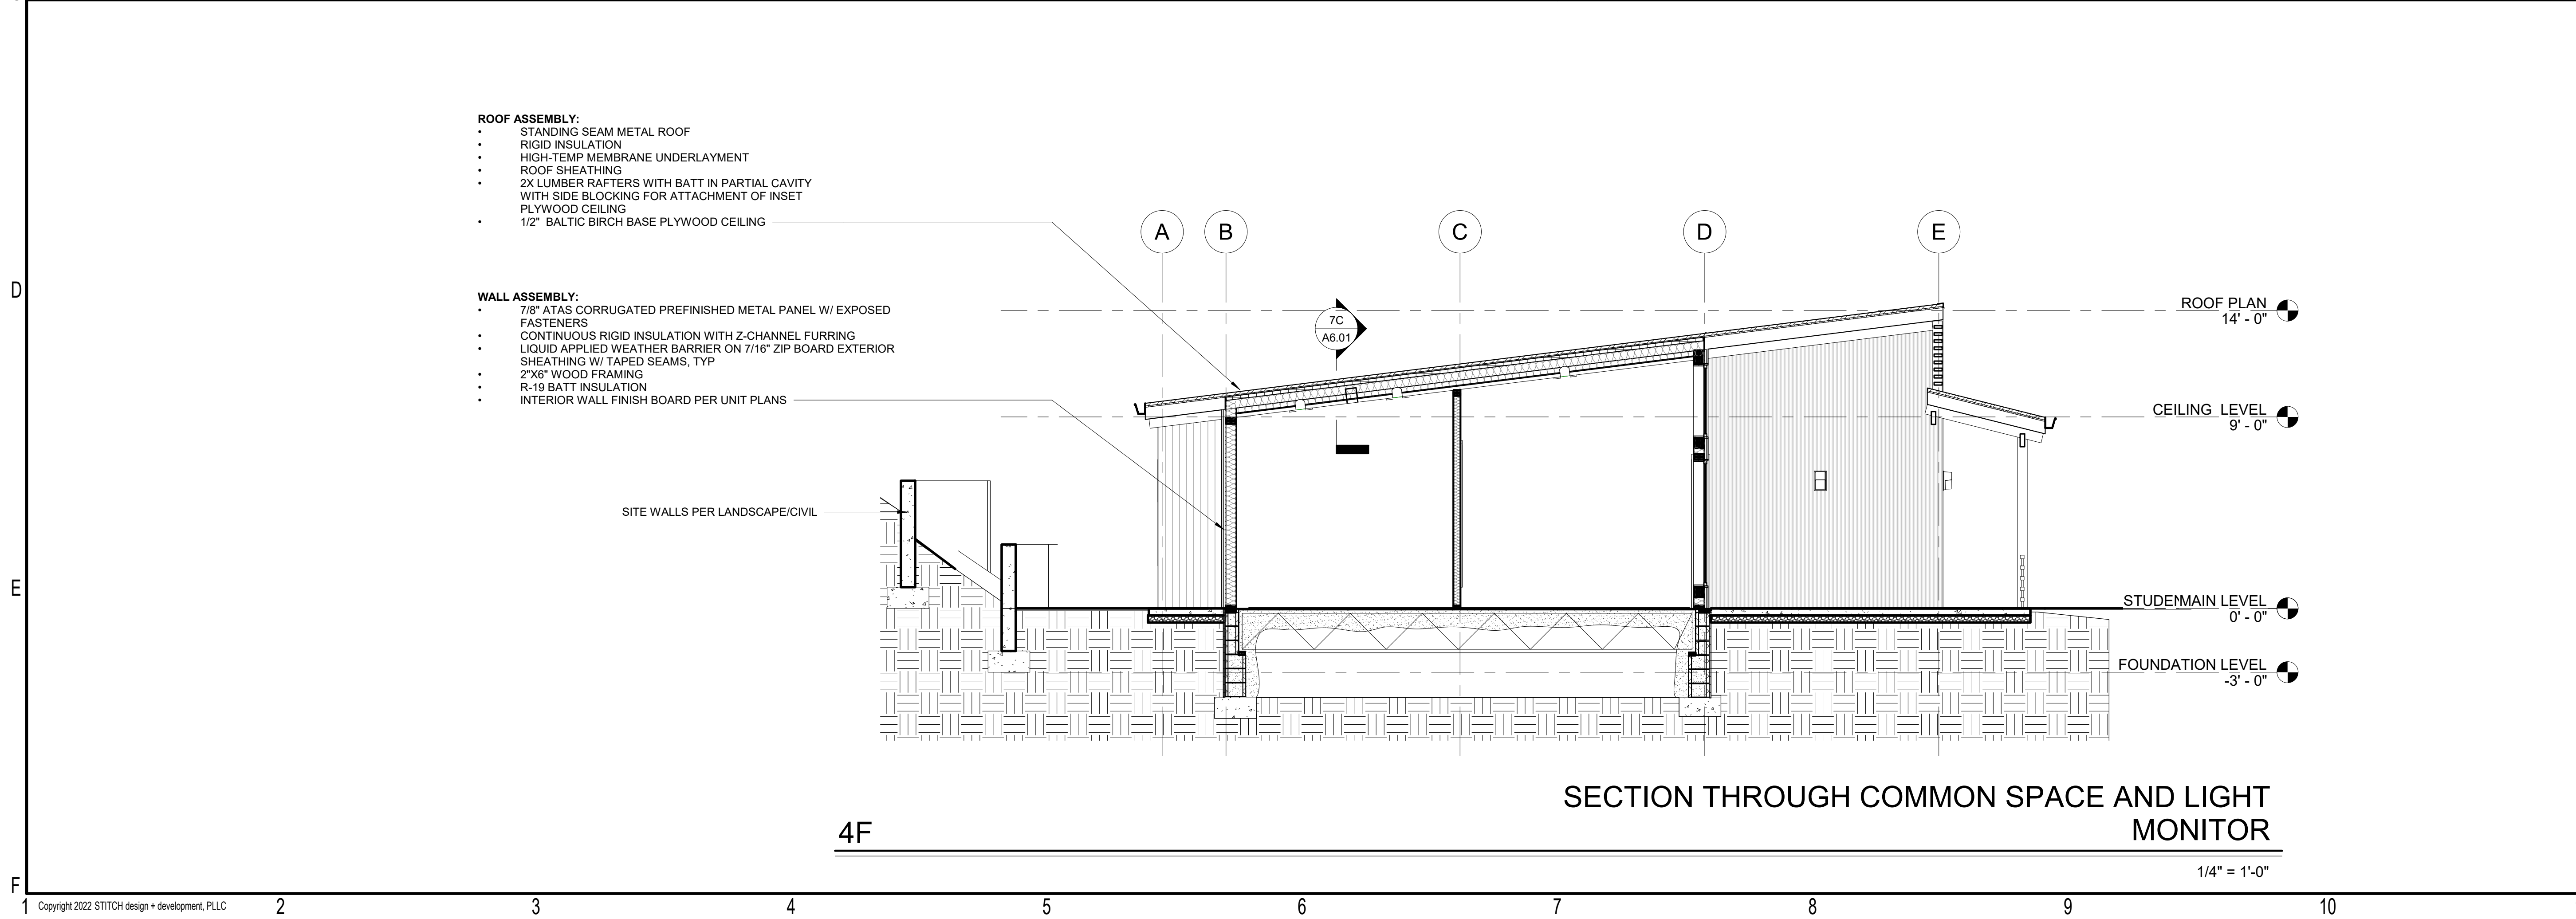
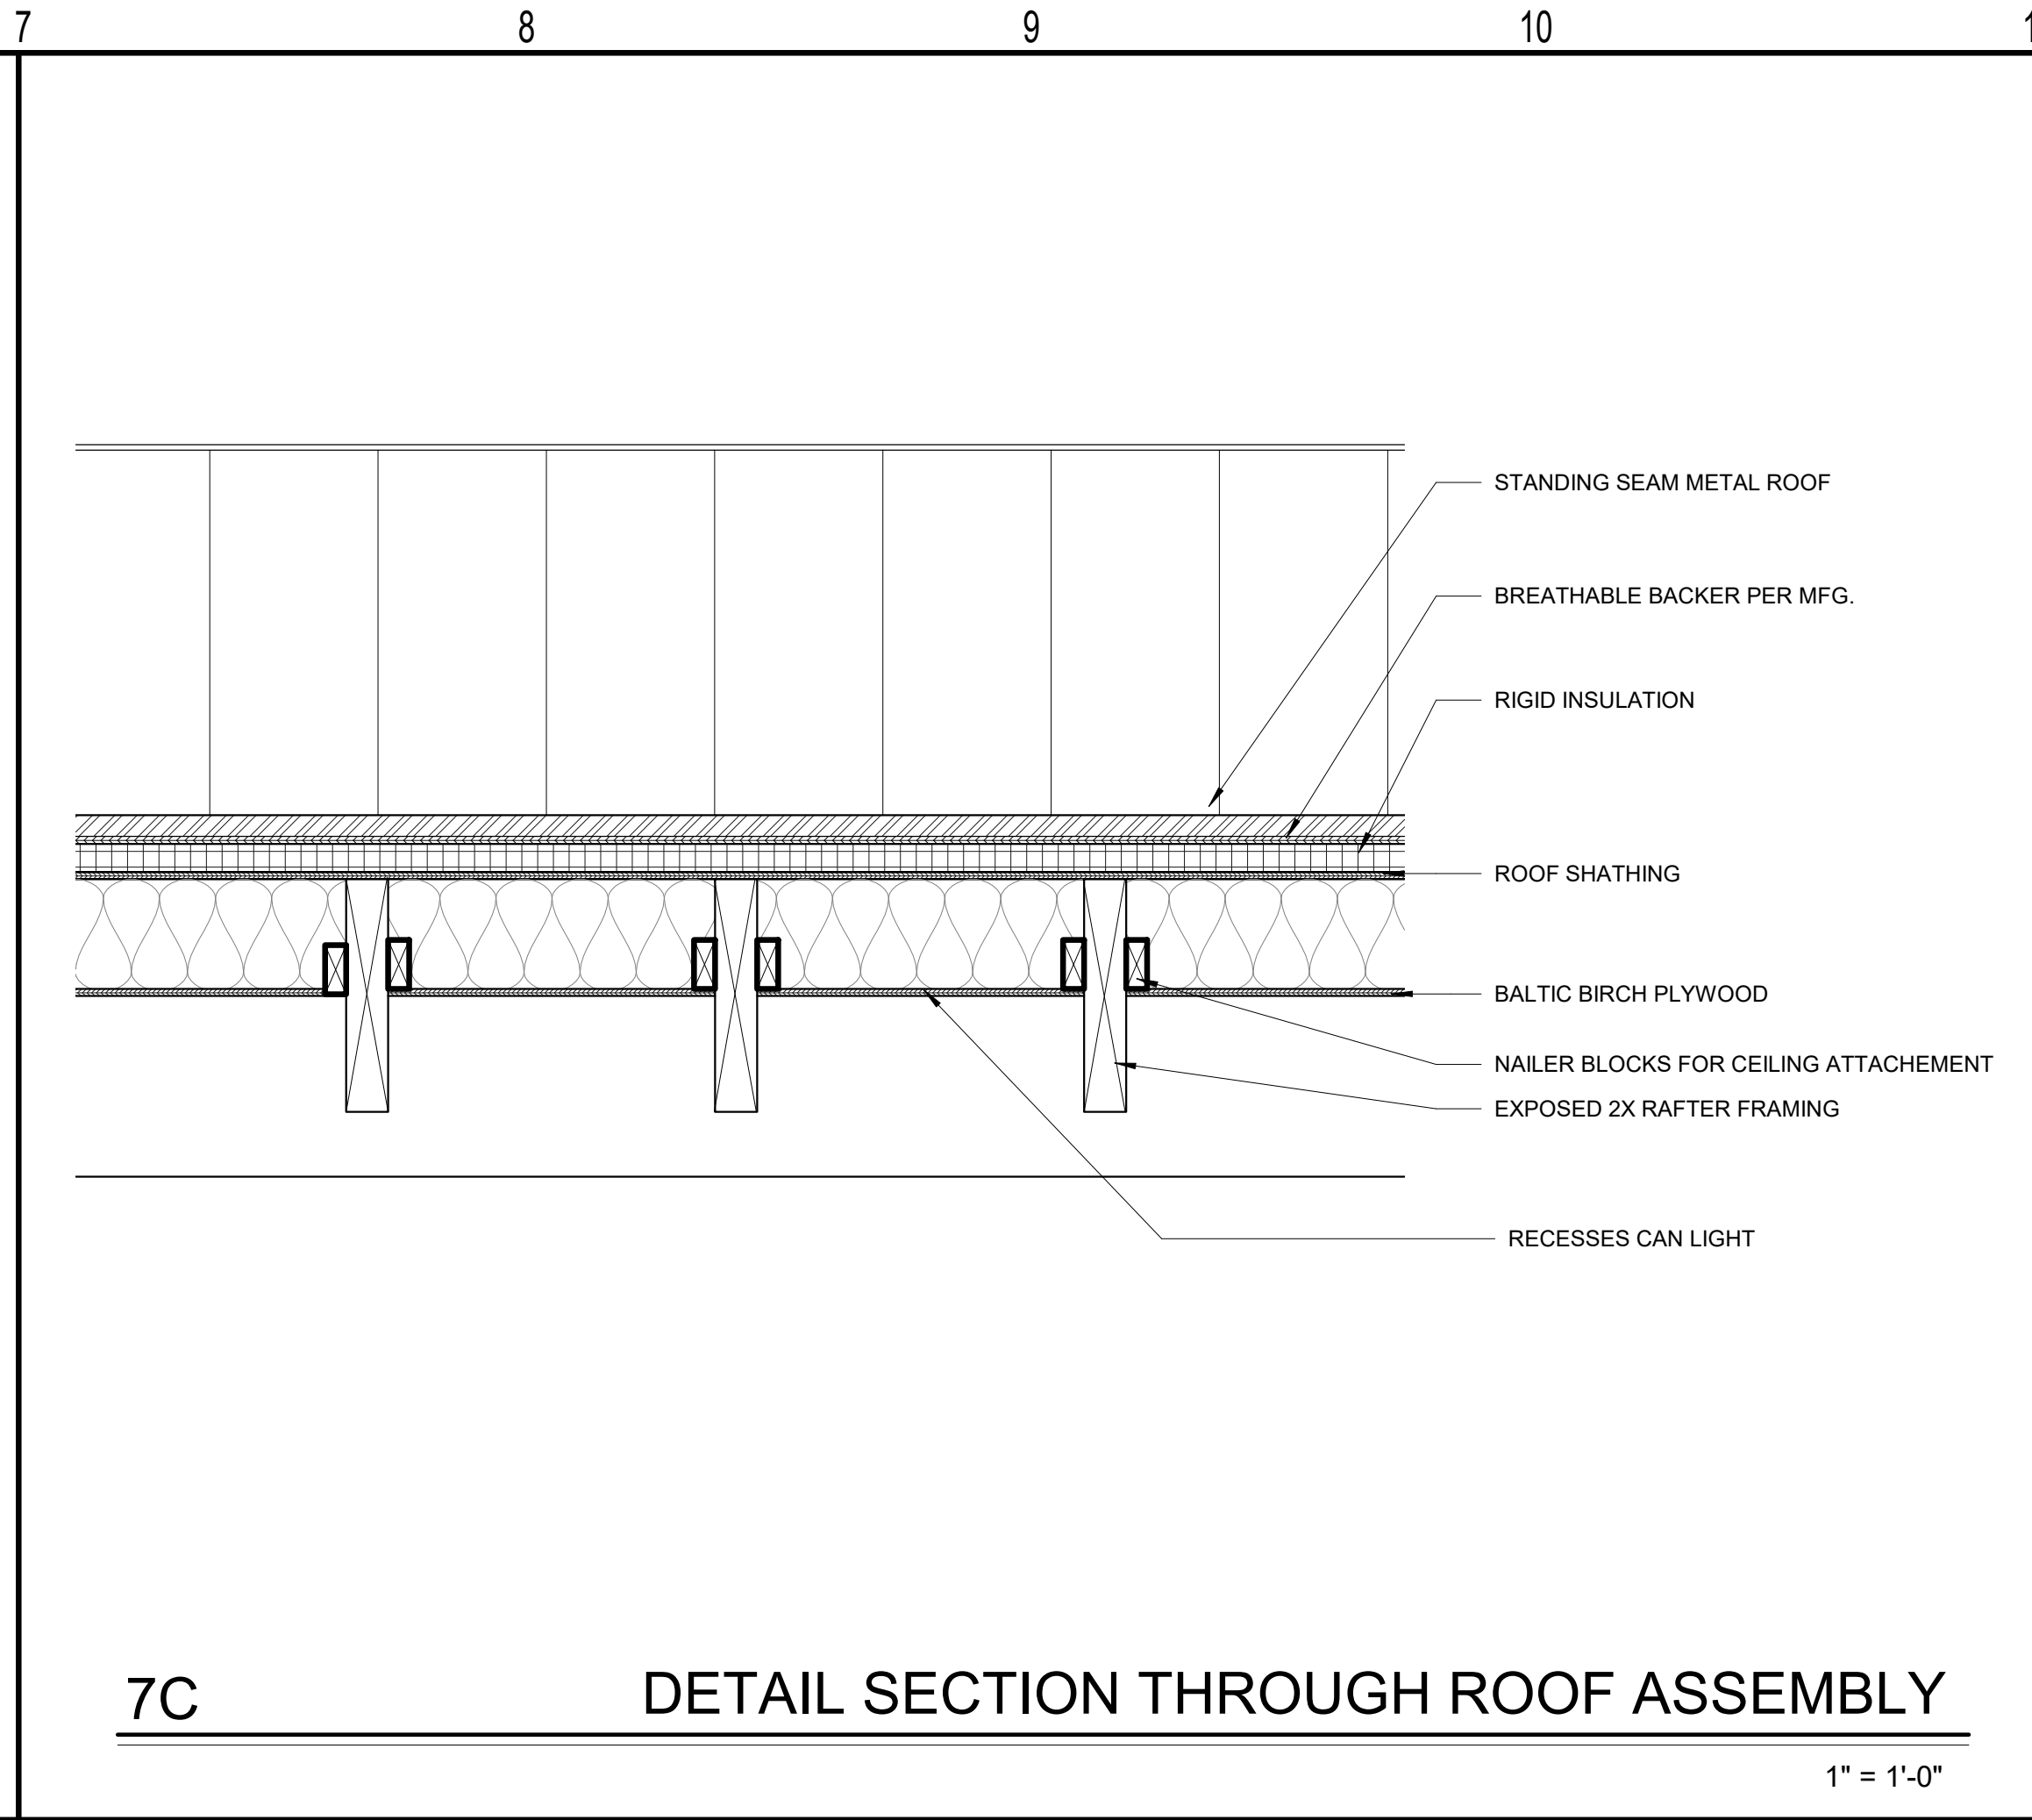
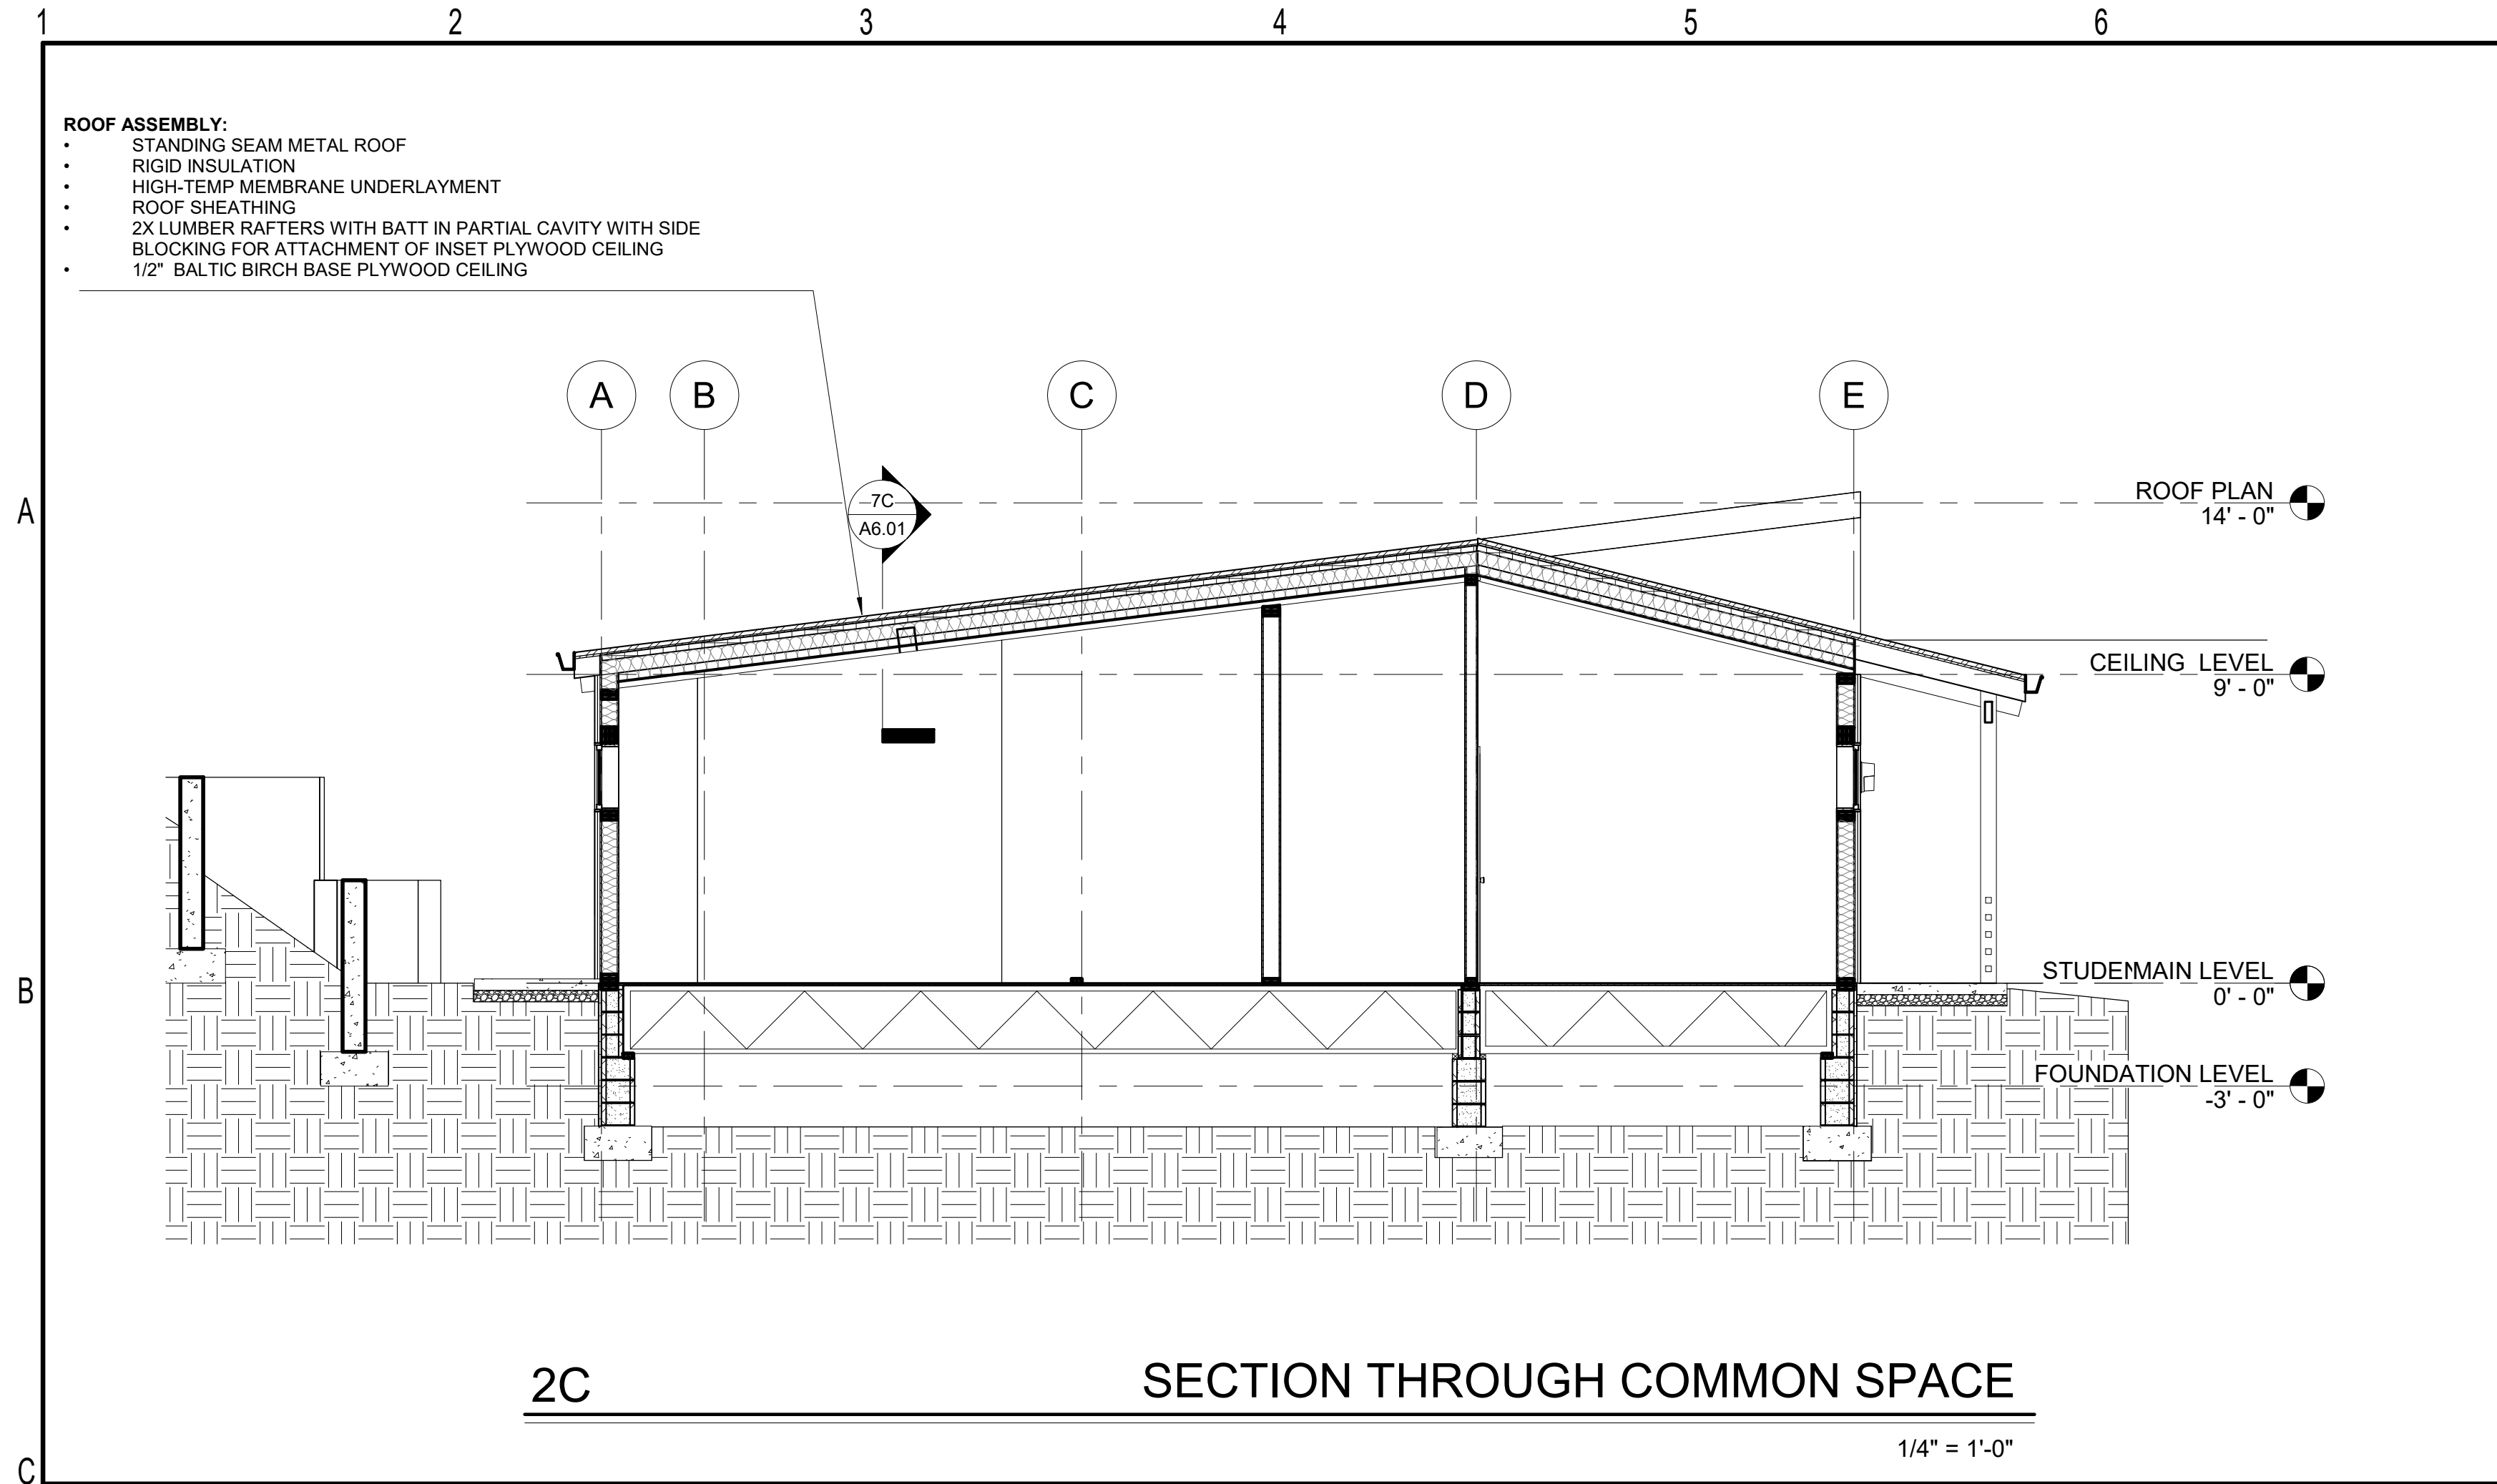
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sheet title:
EXTERIOR PERSPECTIVES

sheet no.:

A5.03



STITCH
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