


DEMOLITION NOTES:

- 1.) THE CONTRACTOR IS RESPONSIBLE FOR OBTAINING THE DEMOLITION PERMIT AND COORDINATING WITH THE MUNICIPALITY FOR DEMOLITION AND CONSTRUCTION ACTIVITIES.
- 2.) THE CONTRACTOR SHALL NOT DEVIATE FROM THESE PLANS AND SPECIFICATIONS WITHOUT THE PRIOR WRITTEN CONSENT OF THE ENGINEER.
- 3.) ALL EROSION AND SEDIMENT CONTROL MEASURES SHALL BE INSTALLED PRIOR TO ANY WORK INCLUDING DEMOLITION.
- 4.) ALL CONSTRUCTION RELATED PERMITS DURING THE CONSTRUCTION PHASE OF THIS PROJECT ARE THE RESPONSIBILITY OF THE CONTRACTOR.
- 5.) REMOVE SHRUBS AND TREES AS NOTED. GRUB OUT ROOTS AND STUMPS AND LEGALLY DISPOSE OF DEBRIS.
- 6.) ALL NEW WORK SHOWN IN THESE SHEETS SHALL COMPLY WITH APPLICABLE STATE, FEDERAL, AND LOCAL BUILDING AND UTILITY INSTALLATION CODES.
- 7.) ALL MATERIALS AND CONSTRUCTION METHODS SHALL BE IN ACCORDANCE WITH NORTH CAROLINA DEPARTMENT OF TRANSPORTATION STANDARD SPECIFICATIONS FOR ROADS AND STRUCTURES EXCEPT IN CASES WHERE, WITHIN THE MUNICIPALITY JURISDICTION, THE TOWN'S STANDARD SPECIFICATIONS ARE MORE STRINGENT.
- 8.) THE CONTRACTOR SHALL CONTACT THE UTILITIES PROTECTION CENTER PRIOR TO ANY EXCAVATION, AS THERE MAY BE ADDITIONAL UTILITIES NOT SHOWN ON THESE PLANS. THE ENGINEER ASSUMES NO RESPONSIBILITY FOR LOCATIONS SHOWN, AND IT SHALL BE THE RESPONSIBILITY OF THE CONTRACTOR TO FIELD VERIFY THE LOCATIONS OF ALL UTILITIES WITHIN THE LIMITS OF CONSTRUCTION AND TO NOTIFY THE OWNER IN CASE OF DISCREPANCIES THAT AFFECT THE CONSTRUCTION PROJECT.
- 9.) THE CONTRACTOR IS RESPONSIBLE FOR CONTACTING THE MUNICIPALITY AND ALL EXISTING UTILITY PROVIDERS BEFORE REMOVING AND/OR RELOCATING ANY/ALL UTILITIES FROM THEIR EXISTING LOCATIONS ON THE SITE. THE CONTRACTOR SHALL PERFORM ALL UTILITY DEMOLITION OR RELOCATION ACTIVITIES IN ACCORDANCE WITH THE EXISTING UTILITIES SPECIFICATIONS, MATERIALS, AND REQUIREMENTS.
- 10.) CONTRACTOR IS RESPONSIBLE FOR ANY DAMAGE THAT MAY OCCUR TO ANY ADJACENT STRUCTURES OR PROPERTY, OR ANY EXISTING STRUCTURES WITHIN LIMITS OF CONSTRUCTION THAT ARE DESIGNATED ON THE PLANS TO REMAIN, AND SHALL REPAIR OR REPLACE SUCH DAMAGED PROPERTY TO THE PROPERTY OWNER'S SATISFACTION AT NO COST TO THE OWNER.
- 11.) THE CONTRACTOR SHALL SEQUENCE THE WORK AND PROVIDE TEMPORARY MEASURES AS NECESSARY TO MAINTAIN ACCESS TO THE SITE THROUGH ALL ENTRANCES AT ALL TIMES DURING CONSTRUCTION. TEMPORARY PROVISIONS MAY INCLUDE, BUT ARE NOT LIMITED TO: BARRICADES, FLASHING LIGHTS, FLAGMAN, TEMPORARY PAVEMENT, AND DIRECTIONAL SIGNAGE AS NECESSARY TO ACCOMPLISH THE WORK.
- 12.) CONTRACTOR SHALL CONSIDER COORDINATION ASPECTS OF CRANES AND CONSTRUCTION EQUIPMENT OPERATIONS DURING DEMOLITION ACTIVITY.
- 13.) CONTRACTOR EQUIPMENT SHALL NOT BE PARKED IN COUNTY, CITY OR STATE RIGHT-OF-WAY, AND MUST BE STORED WITHIN SITE.
- 14.) APPROVAL OF THESE PLANS DOES NOT CONSTITUTE APPROVAL BY THE MUNICIPALITY OF ANY LAND DISTURBING ACTIVITIES WITHIN WETLAND AREAS. IT IS THE RESPONSIBILITY OF THE PROPERTY OWNER TO CONTACT THE APPROPRIATE REGULATORY AGENCY FOR APPROVAL OF ANY WETLAND AREA DISTURBANCE.
- 15.) ALL BUFFERS AND SAVE AREAS SHALL BE CLEARLY IDENTIFIED BY FLAGGING AND/OR FENCING PRIOR TO COMMENCEMENT OF ANY LAND DISTURBANCE.
- 16.) THE CONTRACTOR SHALL DISPOSE OF ANY HAZARDOUS MATERIALS IN STRICT ACCORDANCE WITH ALL APPLICABLE LOCAL, STATE, AND FEDERAL LAWS.

| LEGEND |                                       |
|--------|---------------------------------------|
|        | UTILITIES/FENCE TO BE REMOVED         |
|        | BUILDING/CURB & GUTTER TO BE REMOVED  |
|        | ASPHALT/GRAVEL/CONCRETE TO BE REMOVED |
|        | EXISTING FENCE                        |
|        | TREE PROTECTION FENCE                 |
|        | LIMITS OF CLEARING                    |

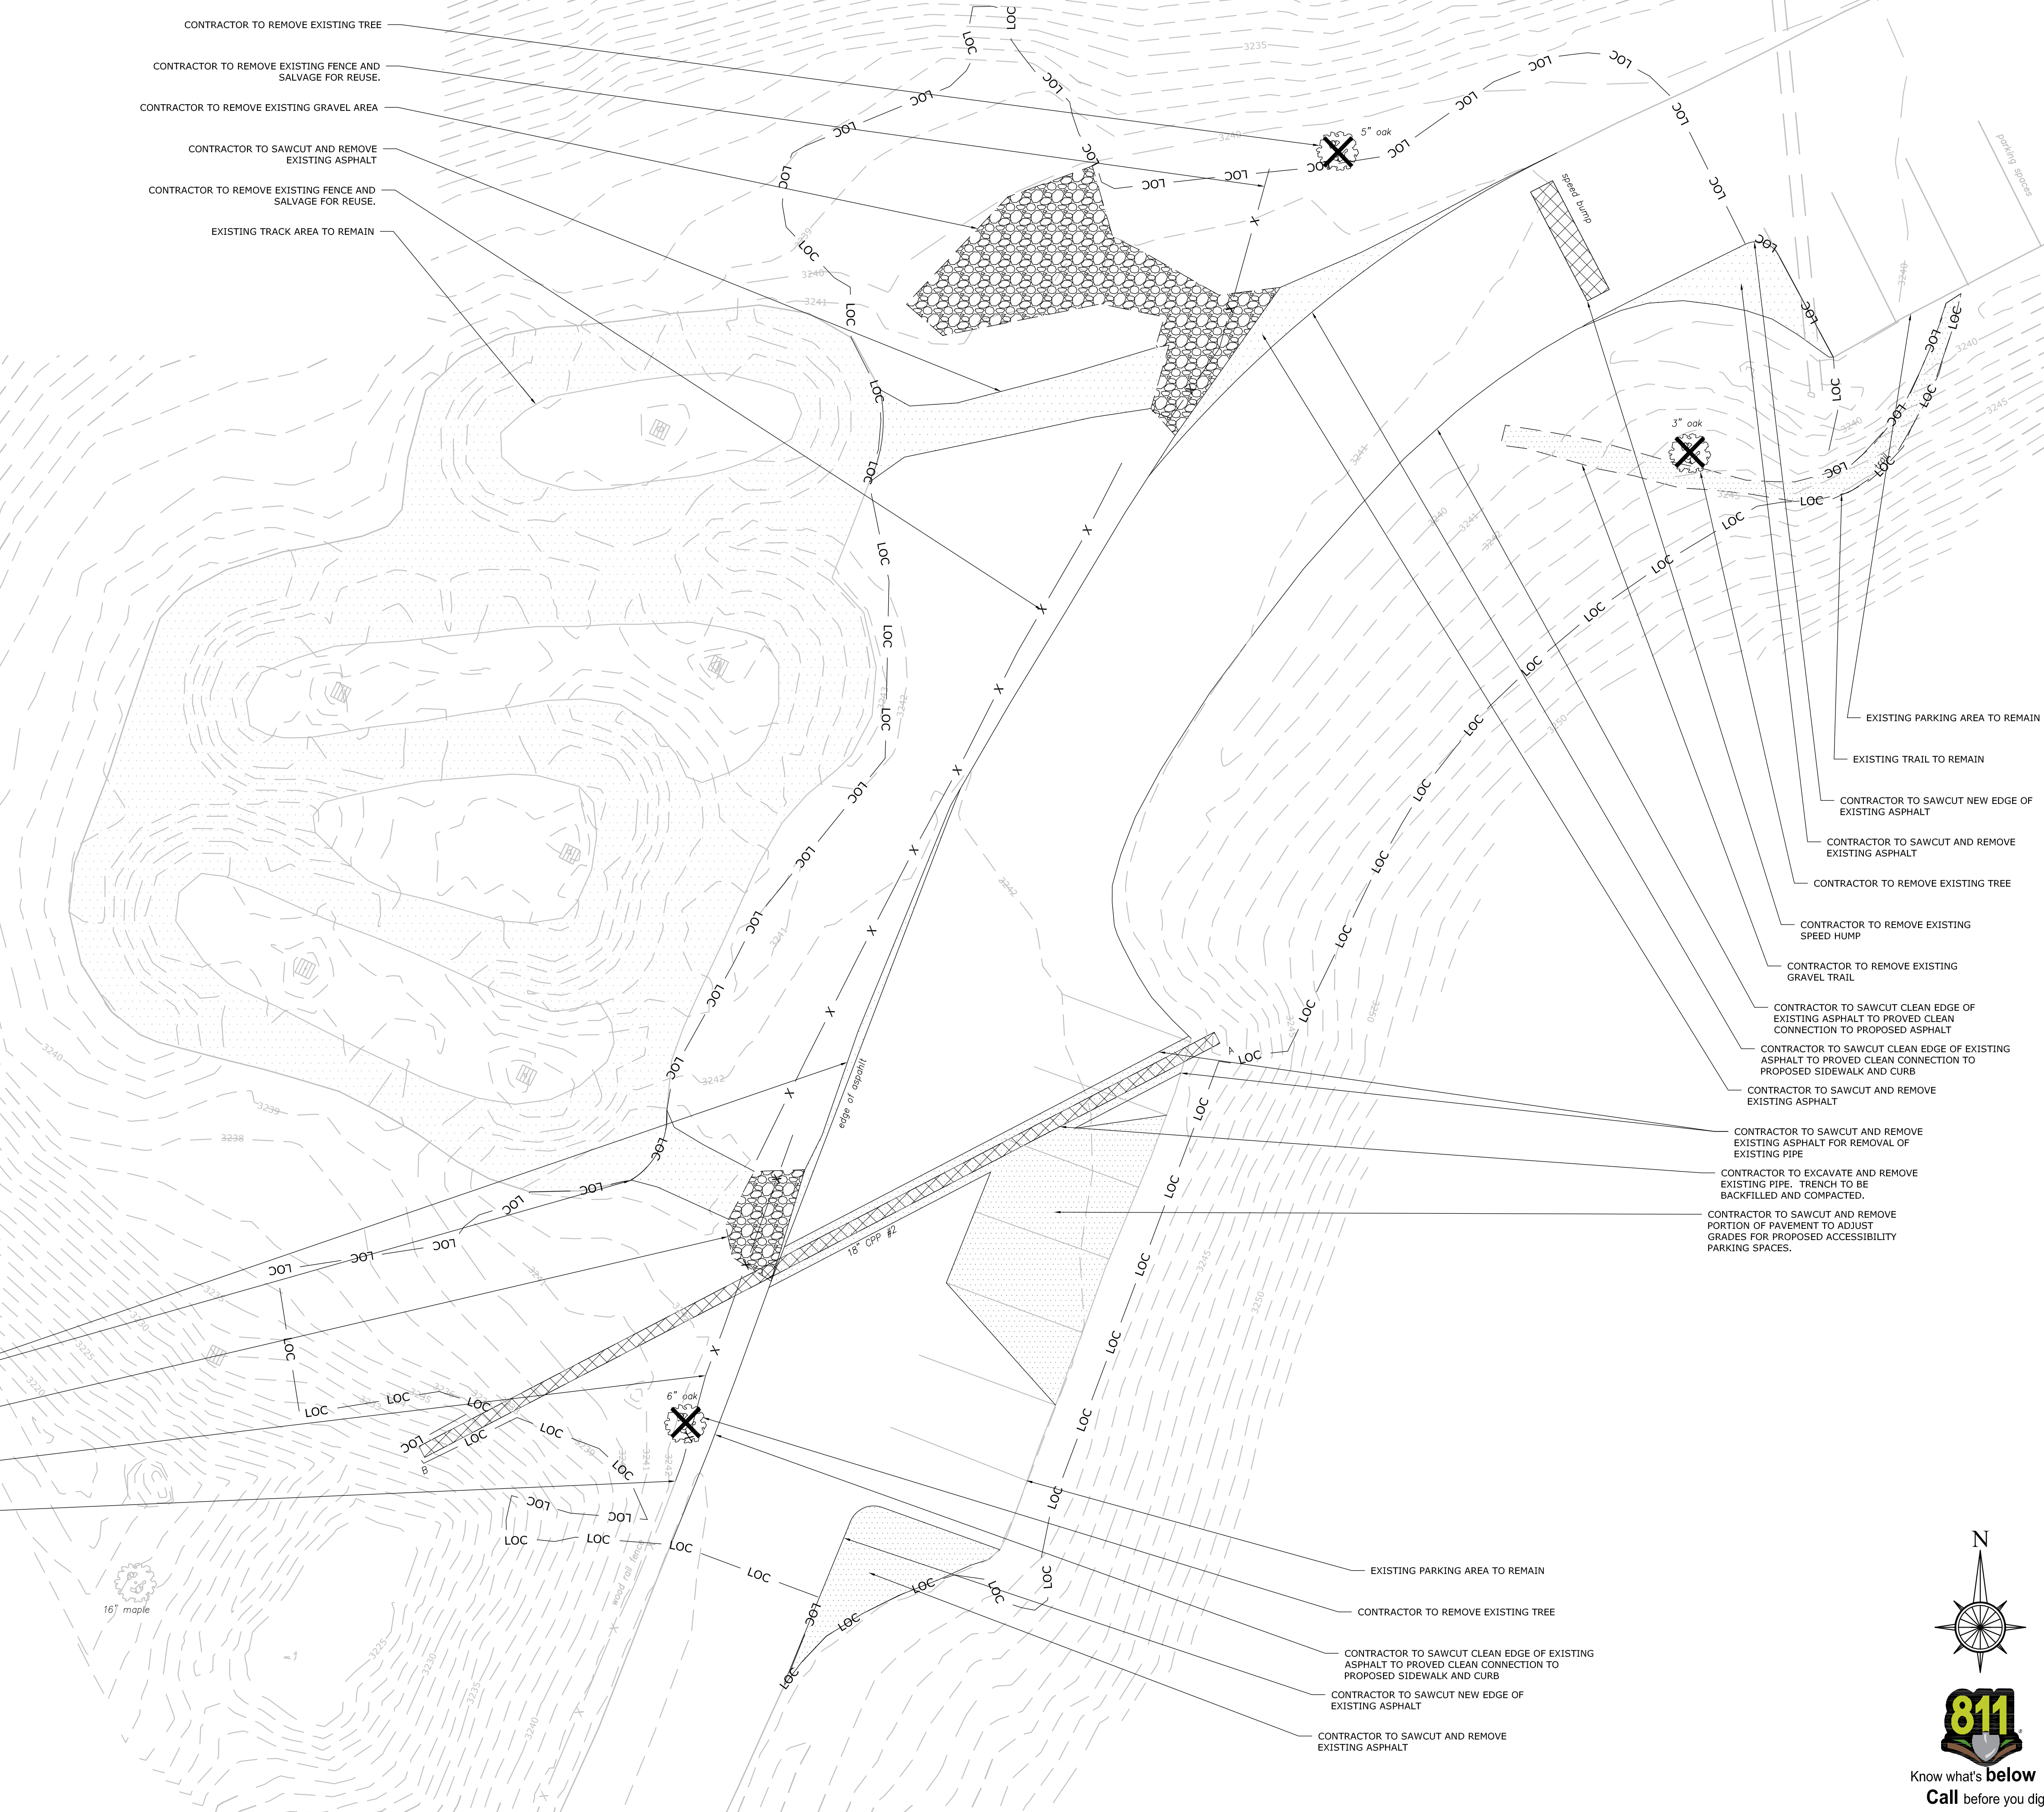

PROJECT:



ROCKY KNOB PARK  
EXPANSION

ADDRESS: 285 MOUNTAIN BIKE WAY | BOONE |  
WATAUGA COUNTY | NC | 28607

CLIENT:



WATAUGA CO. TDA

CONTACT: L. WRIGHT TILLEY, EXECUTIVE  
DIRECTOR  
ADDRESS: 331 QUEEN STREET, SUITE 101 |  
BOONE | WATAUGA COUNTY | NC | 28607

CIVIL ENGINEER:



DESTINATION BY DESIGN ENGINEERING

ADDRESS: 136 FURMAN RD., STE. 6  
BOONE | NC | 28607

SEAL:



REVISIONS DATE

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PROJECT MANAGER: CAG

DRAWING BY: JEG



JURISDICTION: WATAUGA COUNTY

DATE: 04/28/23

SHEET TITLE:

DEMOLITION PLAN

SHEET NUMBER: C-0

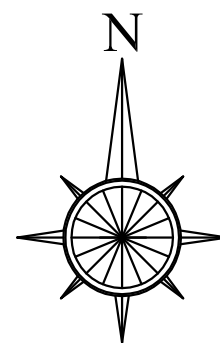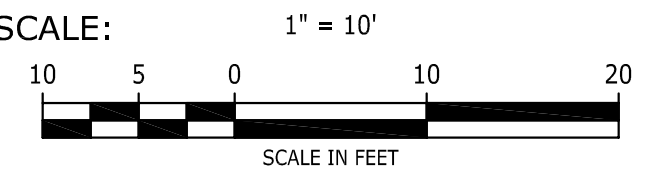

Know what's below  
Call before you dig





#### GENERAL NOTES:

1. ALL PROPOSED DIMENSIONS USED TO SHOW THE GEOMETRIC LAYOUT OF THE PROPOSED PARKING LOT ARE SHOWN AT THE FACE OF CURB. ALL PROPOSED DIMENSIONS USED TO SHOW THE GEOMETRIC LAYOUT OF THE PROPOSED BUILDING LOCATION ARE GIVEN AT THE OUTSIDE FACE OF THE BUILDING CORNERS. ALL CURB RADII ARE GIVEN AT THE FACE OF CURB.
2. CONTRACTOR SHALL NOTIFY ENGINEER OF ANY DISCREPANCIES BETWEEN THE EXISTING CONDITIONS IN THE FIELD AND THE SURVEY SHOWN ON THE PLANS BEFORE PROCEEDING WITH ANY NEW CONSTRUCTION.
3. CONTRACTOR IS RESPONSIBLE FOR CORRECT HORIZONTAL AND VERTICAL ALIGNMENT OF ALL TIES BETWEEN PROPOSED AND EXISTING PAVEMENTS, CURB AND GUTTER, SIDEWALKS, WALLS, AND UTILITIES.

#### SITE NOTES:

1. SEE ARCHITECTURAL PLANS FOR BUILDING FLOOR PLAN DIMENSIONS, DOOR LOCATIONS, AND OTHER ARCHITECTURAL DETAILS.
2. NO CERTIFICATE OF OCCUPANCY WILL BE ISSUED UNTIL ALL SITE IMPROVEMENTS HAVE BEEN COMPLETED ON THE SITE.
3. HIGH INTENSITY LIGHTING FACILITIES SHALL BE SO ARRANGED THAT THE SOURCE OF ANY LIGHT IS CONCEALED FROM THE PUBLIC VIEW AND DOES NOT INTERFERE WITH TRAFFIC. (SEE PHOTOMETRICS PLAN IN ADD'L PLANS).
4. ALL BUFFERS, TREE SAVE AREAS, AND UNDISTURBED AREAS SHALL BE CLEARLY IDENTIFIED BY FLAGGING AND/OR FENCING PRIOR TO COMMENCEMENT OF ANY LAND DISTURBANCE.
5. SIGN LOCATION, NUMBER, AND SIZE ARE NOT APPROVED UNDER THIS DEVELOPMENT PERMIT. A SEPARATE PERMIT IS REQUIRED FOR ON-SITE SIGNAGE.
6. ALL PAVEMENT MARKING WITHIN R/W SHALL BE CONSTRUCTED ACCORDING TO MUNICIPALITY SPECIFICATIONS.
7. CONSTRUCTION TRAILERS ARE TO BE PERMITTED THROUGH THE ZONING DIVISION OF PLANNING & INSPECTIONS.
8. ALL EROSION, SEDIMENT CONTROL AND TREE PROTECTION MEASURES SHALL BE INSTALLED PRIOR TO ANY GRADING.
9. THE JURISDICTION ACCEPTS NO RESPONSIBILITY FOR THE AMERICANS WITH DISABILITIES ACT (ADA), EXCEPT FOR NOTIFICATION REQUIREMENT. THE OWNER/DEVELOPER IS SOLELY RESPONSIBLE FOR COMPLIANCE FOR ADA ACT.

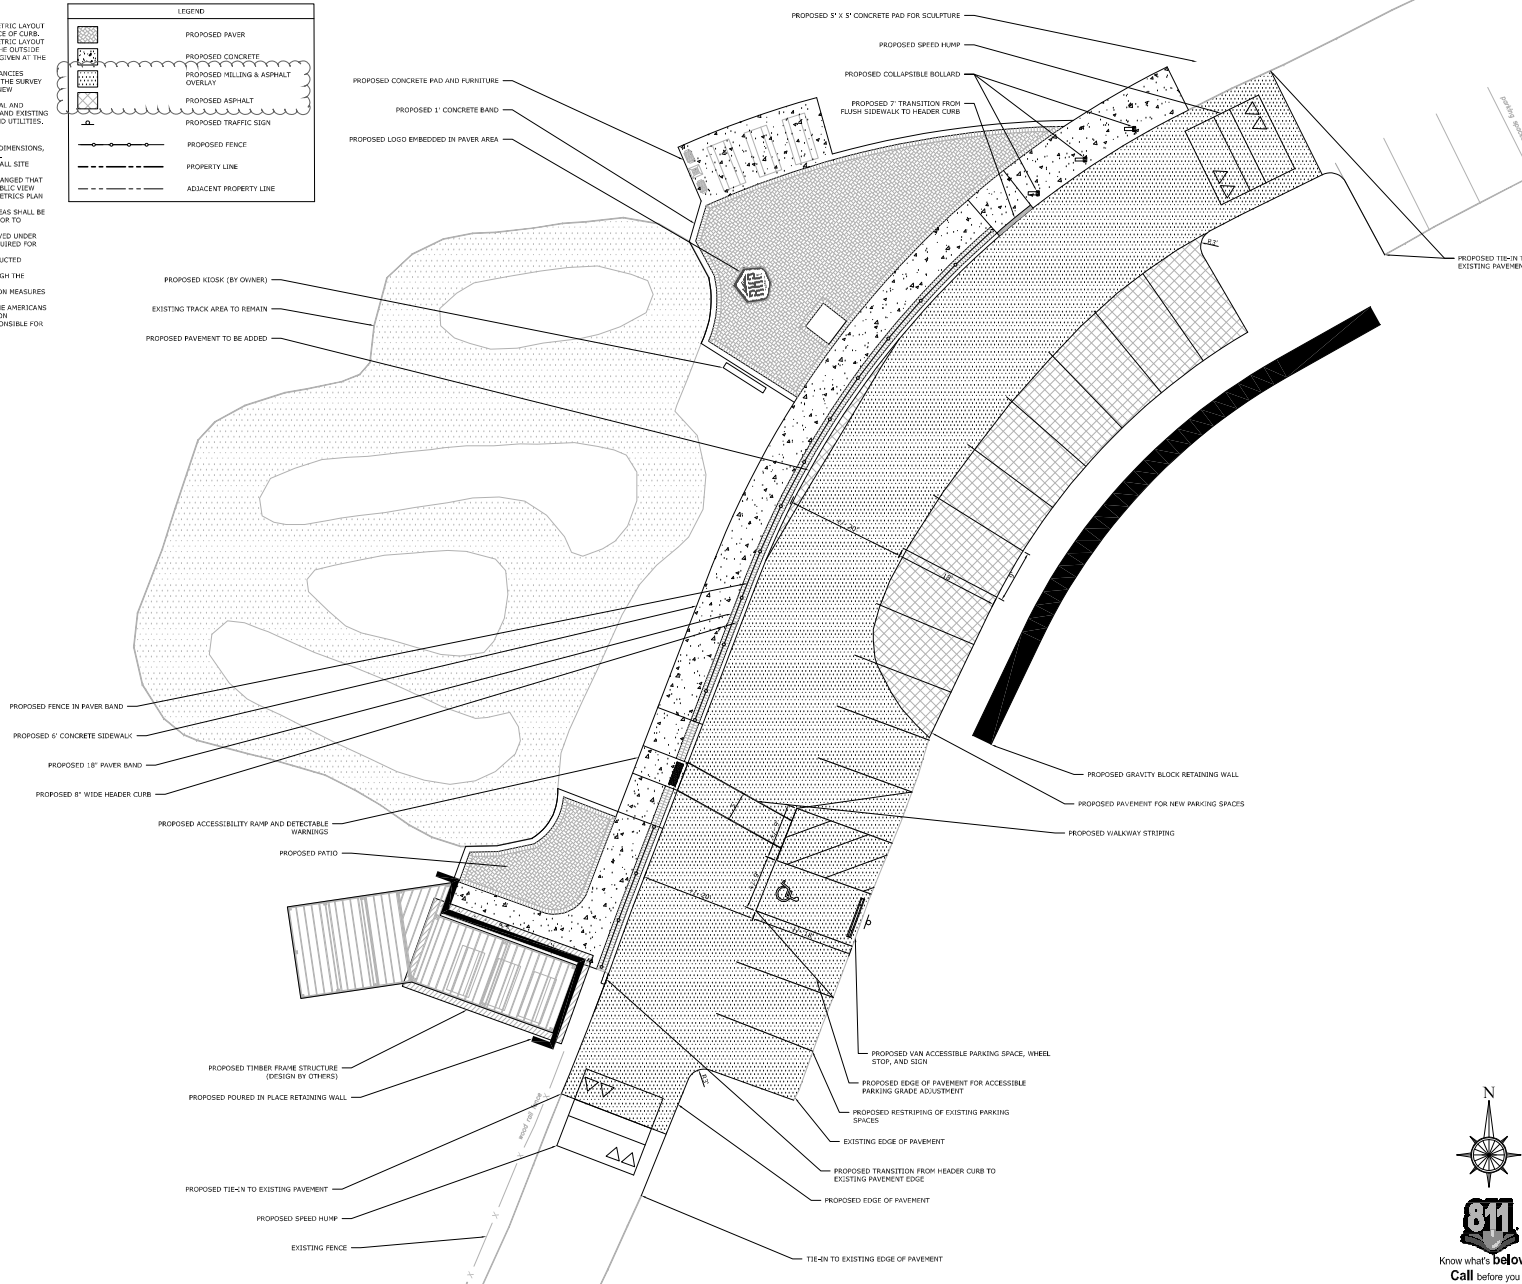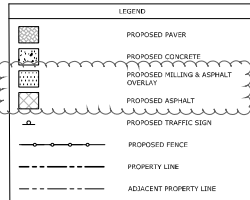

#### PROJECT:



#### ROCKY KNOB PARK EXPANSION

ADDRESS: 285 MOUNTAIN BIKE WAY | BOONE | WATAUGA COUNTY | NC | 28607

#### CLIENT:



#### WATAUGA CO. TDA

CONTACT: L. WRIGHT TILLEY, EXECUTIVE DIRECTOR  
ADDRESS: 331 QUEEN STREET, SUITE 101 | BOONE | WATAUGA COUNTY | NC | 28607

#### CIVIL ENGINEER:

#### DESTINATION BY DESIGN

DESTINATION BY DESIGN ENGINEERING

ADDRESS: 136 FURMAN RD., STE. 6  
BOONE | NC | 28607

#### SEAL:



| REVISIONS   | DATE    |
|-------------|---------|
| Addendum #3 | 10/6/23 |

PROJECT MANAGER: CAG  
DRAWING BY: JEG  
JURISDICTION: WATAUGA COUNTY  
DATE: 09/25/23  
SHEET TITLE:

#### SITE PLAN

SHEET NUMBER: C-1

SCALE: 1" = 10'  
10 5 0 10 20  
SCALE IN FEET





| EARTHWORK CALCULATIONS                      |       |    |  |
|---|-------|----|--|
| REQ'D CUT =                                 | + 200 | CY |  |
| REQ'D FILL =                                | - 100 | CY |  |
| ADDITIONAL REQ'D FILL FOR SHRINKAGE, ETC. = | - 20  | CY |  |
| ADDITIONAL CUT FROM PAVEMENT BASE =         | + 10  | CY |  |
| ADDITIONAL CUT FROM HARDSCAPE               | + 10  | CY |  |
| BALANCE:                                    | + 100 | CY |  |

- EARTHWORK NOTES:
- 1.) A SHRINKAGE OF 15% WAS TO ACCOUNT FOR REMOVAL OF TOPSOIL, COMPACTION, ETC.
  - 2.) REQ'D CUT IS IN SITU CUT.
  - 3.) ANY SOIL MATERIAL TO BE TRANSPORTED OFFSITE SHALL BE EXPORTED TO A SPOIL SITE APPROVED BY THE GOVERNING JURISDICTION.
  - 4.) IT IS THE RESPONSIBILITY OF THE CONTRACTOR TO VERIFY ALL QUANTITIES AND BID NUMBERS. THESE CALCULATIONS ARE PROVIDED FOR REFERENCE ONLY.

| LEGEND |                         |
|--------|-------------------------|
| XXX.XX | EXISTING SPOT ELEVATION |
| XXX.XX | PROPOSED SPOT ELEVATION |
| XXXX   | EXISTING CONTOURS       |
| XXXX   | PROPOSED CONTOURS       |

#### GRADING NOTES:

- 1.) ALL SPOT ELEVATIONS SHOWN ARE @ THE EOP UNLESS OTHERWISE NOTED.
- 2.) ALL PROPOSED SIDEWALKS SHALL BE BUILT WITH A 2% CROSS-SLOPE.
- 3.) THE CONTRACTOR SHALL CLEAN OUT ACCUMULATED SILT IN STORM WATER CONVEYANCE CHANNELS, PIPES, AND DETENTION FACILITIES AT END OF CONSTRUCTION WHEN DISTURBED AREAS HAVE BEEN STABILIZED.
- 4.) REFER TO SUBSURFACE EXPLORATION AND GEOTECHNICAL ENGINEERING EVALUATION REPORTS AS PROVIDED BY OWNER FOR RECOMMENDATIONS ASSOCIATED WITH: GENERAL SITE PREPARATION, BUILDING PAD PREPARATION, PAVEMENT SECTIONS, FILL, SLOPES AND EXCAVATION.
- 5.) THE CONTRACTOR SHALL RE-ESTABLISH ALL RIGHT OF WAY AREA WHICH IS DAMAGED OR DISTURBED TO ORIGINAL CONDITIONS OR BETTER DURING AUTHORIZED WORK. ALL WORK IN NCDOT RIGHT OF WAY SHALL COMPLY WITH NCDOT SPECIFICATIONS.
- 6.) ALL CURBED ISLANDS SHALL BE FILLED TO TOP OF CURB WITH TOPSOIL AND SEEDED.
- 7.) MAXIMUM CUT SLOPE IS 1.5:1 AND MAXIMUM FILL SLOPE IS 2:1. ANY PROPOSED SLOPE > 2:1 SHALL BE PROPERLY DESIGNED AND CERTIFIED BY A NORTH CAROLINA REGISTERED PROFESSIONAL ENGINEER OR GEOLOGIST.
- 8.) ALL BUFFERS, TREE SAVE AREAS, AND UNDISTURBED AREAS SHALL BE CLEARLY IDENTIFIED BY FLAGGING AND/OR FENCING PRIOR TO COMMENCEMENT OF ANY LAND DISTURBANCE.
- 9.) ALL HDPE STORM PIPE SHOWN ON THIS PLAN SHALL BE WRAPPED WITH LOCATION WIRE AND TAPE.
- 10.) IN ALL AREAS OF FILL OR OTHERWISE DISTURBANCE OF EXISTING CONDITIONS, UNLESS OTHERWISE NOTED, THE CONTRACTOR SHALL FULLY AND COMPLETELY REMOVE AND LEGALLY DISPOSE OFF-SITE, ALL PLANT MATERIALS INCLUDING BUT NOT LIMITED TO ROOT SYSTEMS, CONCRETE, REINFORCED CONCRETE, ASPHALT DEBRIS, UNDERBRUSH, TOPSOIL, AND OTHER DELETERIOUS MATERIAL. THE SUBGRADE TO REMAIN SHALL BE COMPACTED TO 95% STANDARD PROCTOR MAXIMUM DRY DENSITY FOLLOWING FULL REMOVAL OF THESE MATERIALS.
- 11.) ALL SUBGRADE PREP AND AREAS OF THE SITE TO RECEIVE FILL SHALL BE COMPLETED IN STRICT CONFORMANCE WITH THE RECOMMENDATIONS PROVIDED BY THE PROJECT GEOTECHNICAL ENGINEER. THE CONTRACTOR SHALL HAVE THIS REPORT ON THE JOB SITE FOR REFERENCE AT ALL TIMES. THE CONTRACTOR SHALL PROVIDE EARTHWORK OPERATIONS AND CONSTRUCTION PHASE MONITORING TO ENSURE THAT ALL COMPACTION IS COMPLETED IN ACCORDANCE WITH THE GEOTECHNICAL REPORT. THE CONTRACTOR SHALL PROVIDE TESTING REPORTS TO THE OWNER REGARDING COMPACTION TESTING PER THE TESTING PROTOCOL IN THE GEOTECHNICAL REPORT.
- 12.) STORMWATER MANAGEMENT FACILITIES AND EROSION CONTROL MEASURES ARE TO BE ACCOMPLISHED PRIOR TO ANY OTHER CONSTRUCTION ON THE SITE AND MAINTAINED UNTIL PERMANENT GROUND COVER IS ESTABLISHED. STORM WATER MANAGEMENT SHALL BE IN ACCORDANCE WITH COUNTY, STATE, AND OTHER APPROPRIATE ORDINANCES AND REGULATIONS IN EFFECT AT TIME OF CONSTRUCTION PLAN APPROVAL.
- 13.) EXTREME CAUTION SHALL BE USED WHEN WORKING WITHIN THE VICINITY OF THE EXISTING OVERHEAD POWER LINES. CONTRACTORS SHALL NOTIFY/COORDINATE WITH POWER COMPANY PRIOR TO CONSTRUCTION.

OPEN THROAT CATCH BASIN  
NCDOT STD 840.04  
OPEN ON ALL 4 SIDES

PROPOSED POURED IN PLACE RETAINING WALL  
ENDWALL  
NCDOT STD 838.80

ENDWALL  
NCDOT STD 838.80

OPEN THROAT CATCH BASIN  
NCDOT STD 840.04  
OPEN ON ALL 4 SIDES

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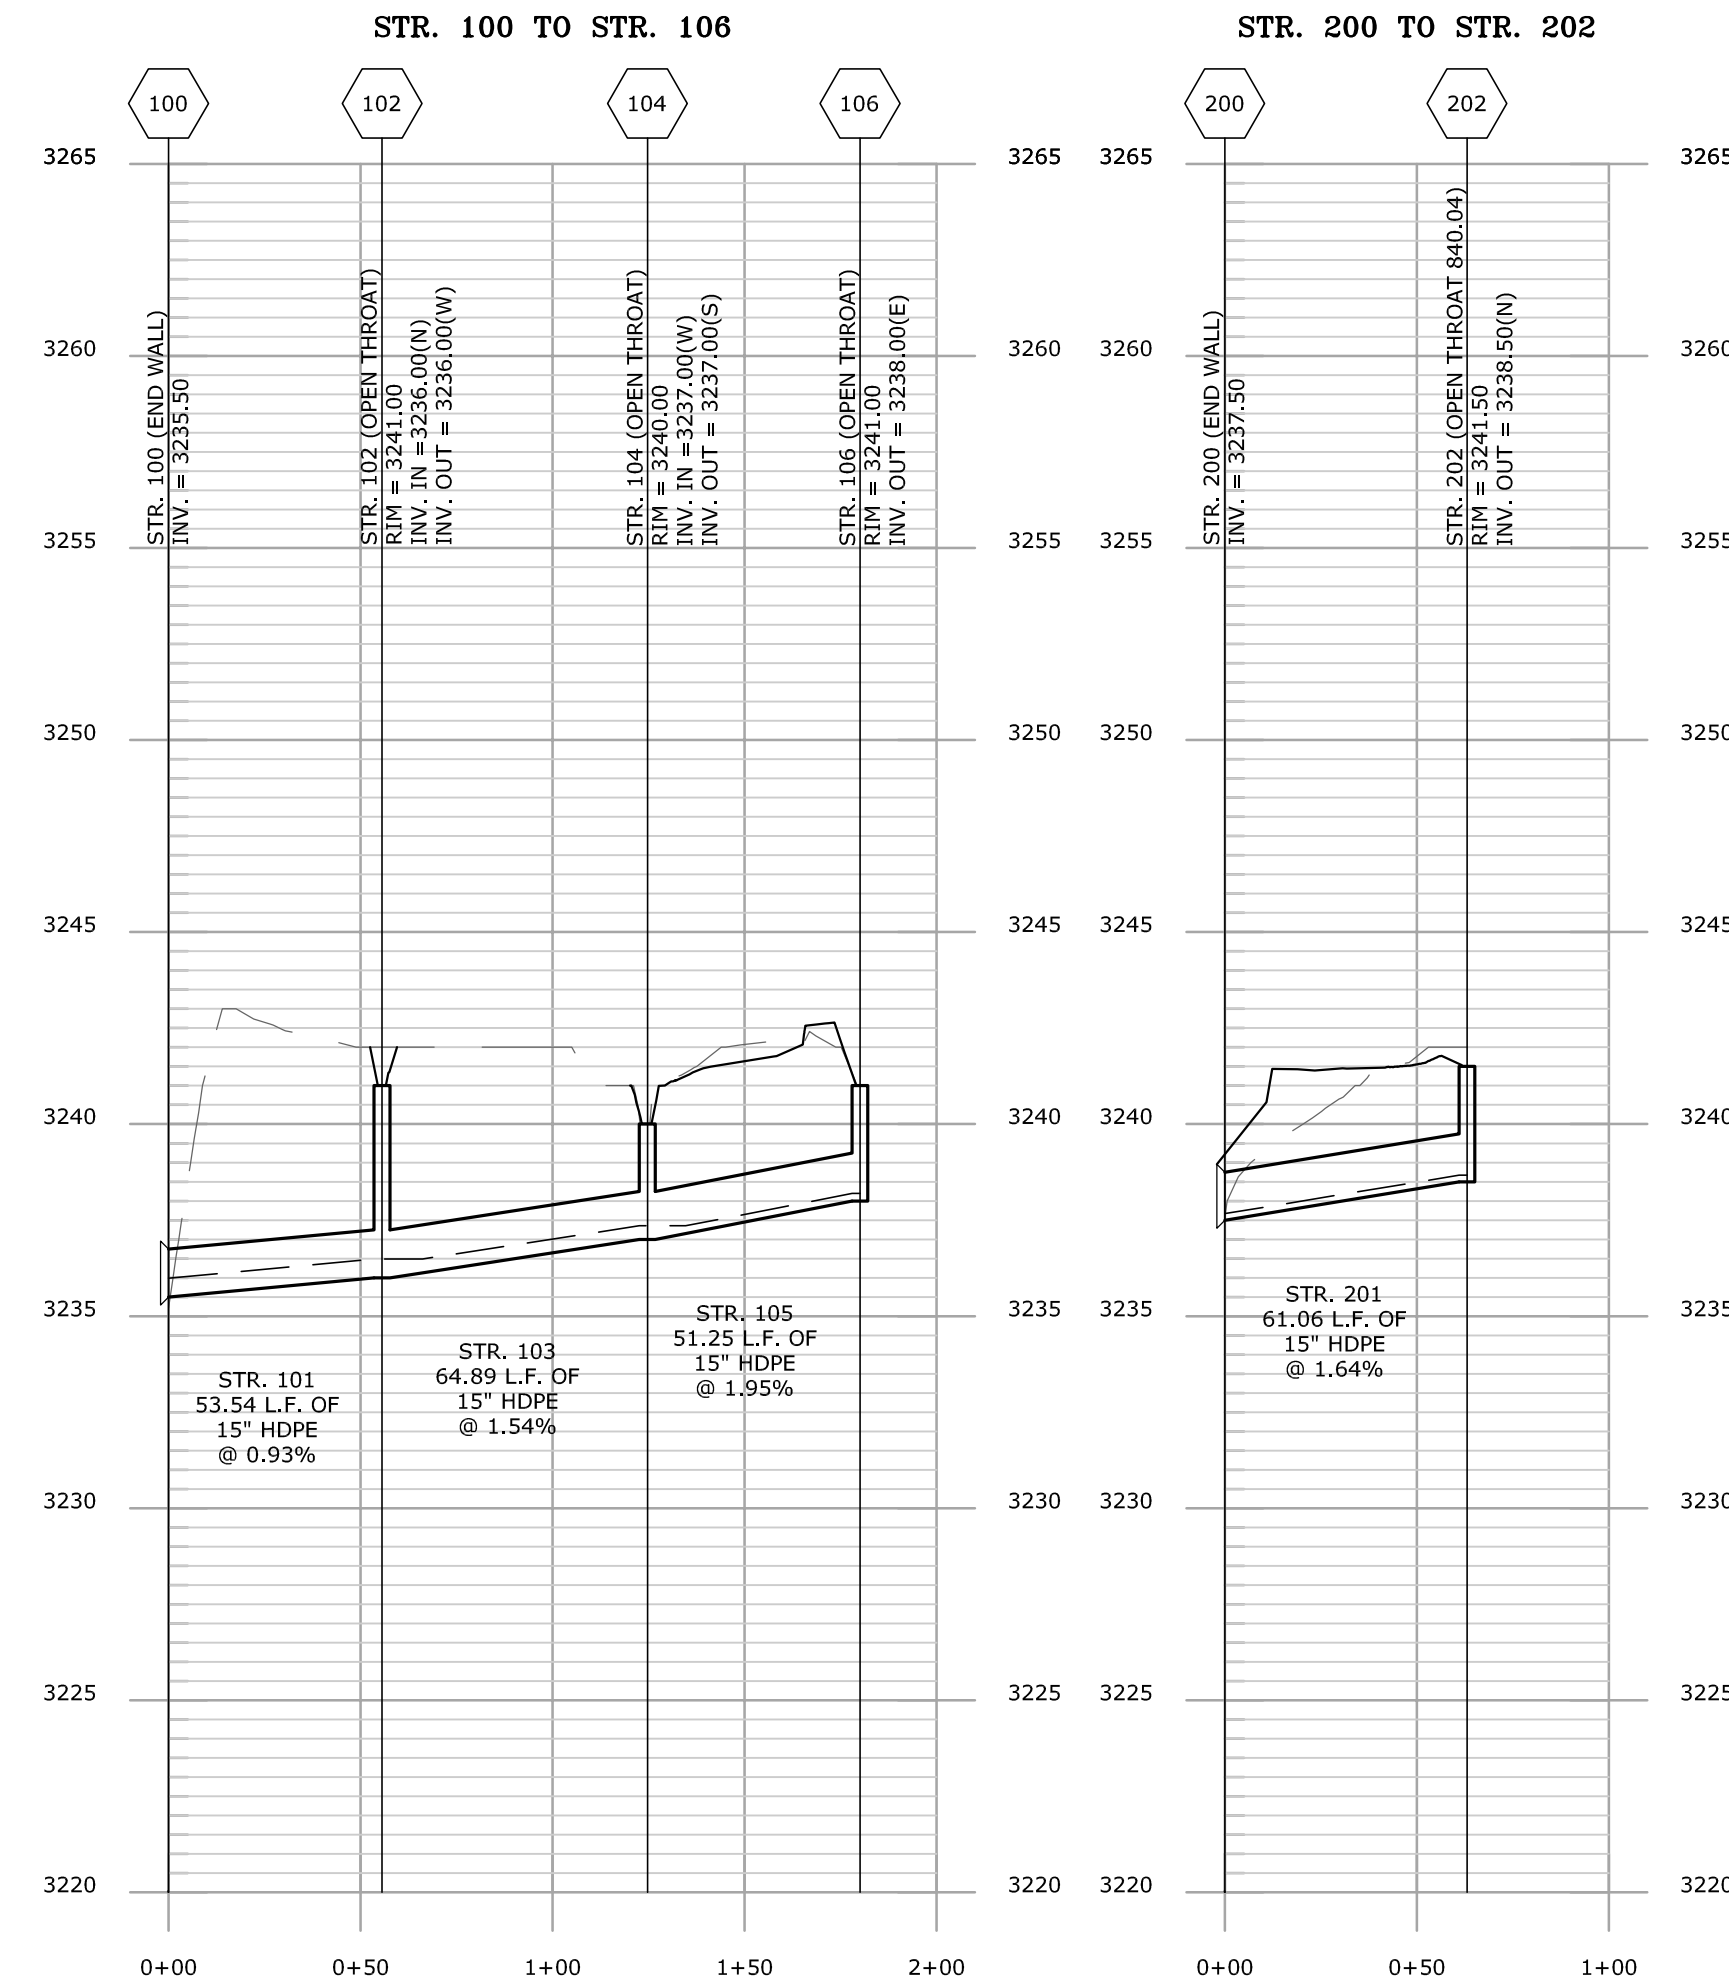
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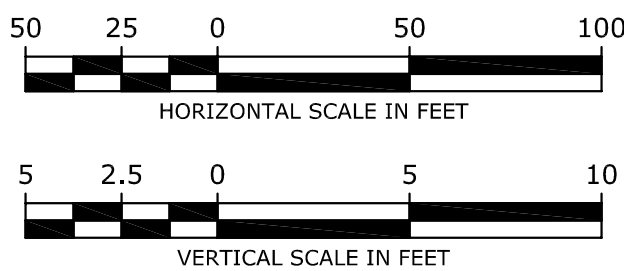
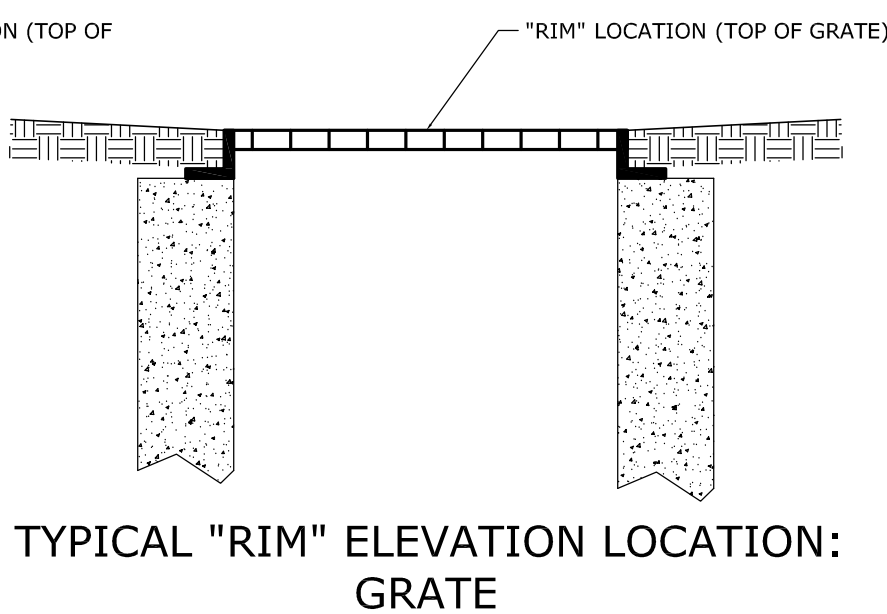
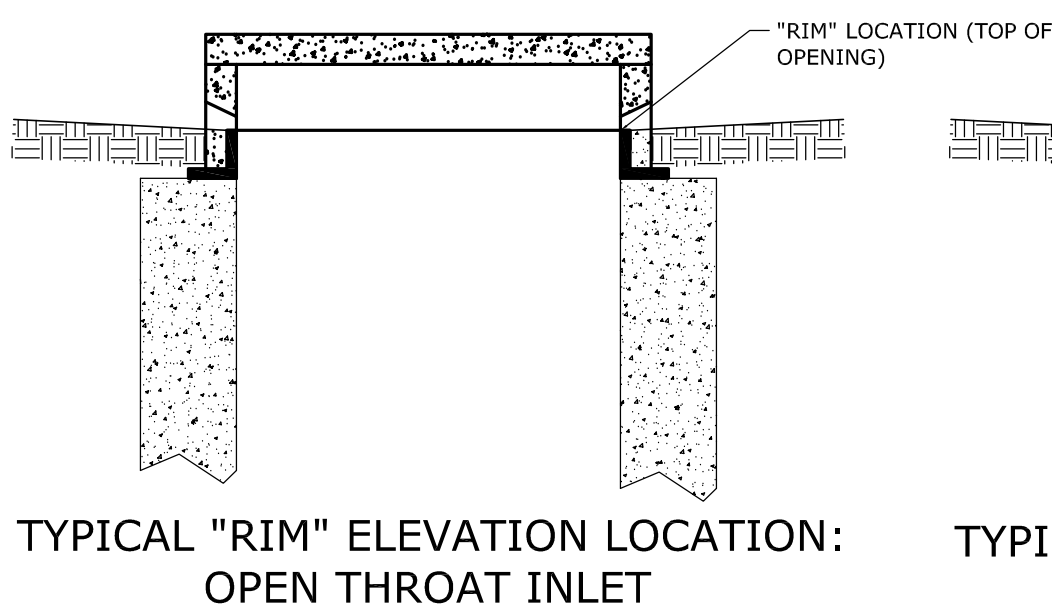
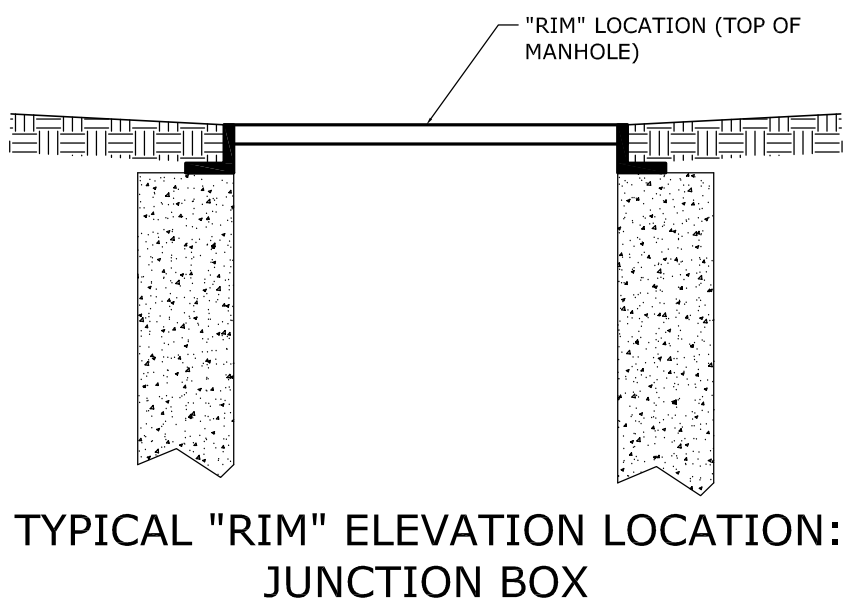
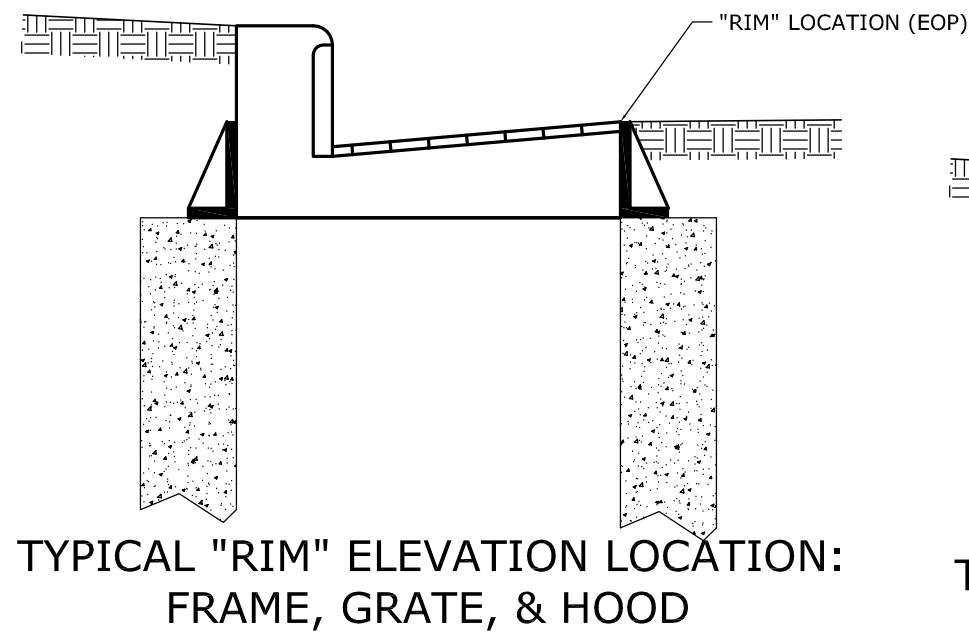
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25-YR PIPE CHART

| PIPE ID | UPSTREAM ID | DOWNSTREAM ID | PIPE LENGTH (ft) | PIPE SIZE (in) | Material | Slope (%) | TotalFlow (cfs) |
|---------|-------------|---------------|------------------|----------------|----------|-----------|-----------------|
| 101     | 102         | 100           | 53.54            | 15             | HDPE     | 0.93      | 1.98            |
| 103     | 104         | 102           | 64.89            | 15             | HDPE     | 1.54      | 1.4             |
| 105     | 106         | 104           | 51.25            | 15             | HDPE     | 1.95      | 0.47            |
| 201     | 202         | 200           | 61.06            | 15             | HDPE     | 1.64      | 0.32            |



LEGEND

|         |                              |
|---------|------------------------------|
| —       | PROPOSED GRADE               |
| - - -   | EXISTING GRADE               |
| - - - - | HYDRAULIC GRADE LINE (25-YR) |

- NOTES:
- ALL CONVEYANCE HDPE IS TO BE SMOOTH INTERIOR HDPE N-12 PIPE PER ASTM F2468 WITH SOIL TIGHT GASKET AND BELL AND SPIGOT CONNECTION BY ADS OR APPROVED EQUAL.
  - "FGH" = FRAME, GRATE AND HOOD.
  - "JB" = JUNCTION BOX
  - ALL FGH IN LOW POINTS SHALL HAVE "TYPE E" GRATES.



PROJECT:



## ROCKY KNOB PARK EXPANSION

ADDRESS: 285 MOUNTAIN BIKE WAY | BOONE |  
WATAUGA COUNTY | NC | 28607

CLIENT:



## WATAUGA CO. TDA

CONTACT: L. WRIGHT TILLEY, EXECUTIVE  
DIRECTOR  
ADDRESS: 331 QUEEN STREET, SUITE 101 |  
BOONE | WATAUGA COUNTY | NC | 28607

CIVIL ENGINEER:



DESTINATION BY DESIGN ENGINEERING

ADDRESS: 136 FURMAN RD., STE. 6  
BOONE | NC | 28607

SEAL:



REVISIONS

DATE

PROJECT MANAGER: CAG

DRAWING BY: JEG

JURISDICTION: WATAUGA COUNTY

DATE: 04/28/23

SHEET TITLE:

## DRAINAGE PROFILES

SHEET NUMBER: C-2.1

SCALE: AS SHOWN



EROSION AND SEDIMENT CONTROL LEGEND

| PRACTICE   | DETAIL | MAP SYMBOL |
|--|--------|------------|
| CONSTRUCTION EXIT  |        | Co         |
| SEDIMENT FENCE   |        | ■          |
| DISTURBED AREA STABILIZATION (WITH PERMANENT VEGETATION) |        | PS         |
| MATting AND BLANKETING                                   |        | REC        |
| DUST CONTROL ON DISTURBED AREAS                          |        | DC         |
| SILT SACK INLET PROTECTION                               |        | □          |
| LIMITS OF DISTURBANCE                                    |        | LOC        |

SITE DATA

TOTAL DISTURBED AREA = 0.38 AC.

EROSION CONTROL NOTES:

- 1.) IT IS THE RESPONSIBILITY OF THE CONTRACTOR TO OBTAIN QUALIFIED PROFESSIONAL ADVICE WHEN QUESTIONS ARISE CONCERNING DESIGN AND EFFECTIVENESS OF EROSION CONTROL DEVICES. 24 HR CONTACT: JASON GASTON, P.E. 770-722-9178.
- 2.) THE INSTALLATION OF EROSION CONTROL MEASURES AND PRACTICES SHALL TAKE PLACE PRIOR TO OR CONCURRENT WITH ALL LAND DISTURBING ACTIVITIES THROUGHOUT THE ENTIRE PROJECT.
- 3.) EROSION AND SEDIMENT CONTROL MEASURES WILL BE MAINTAINED AT ALL TIMES. IF FULL IMPLEMENTATION OF THE APPROVED PLAN DOES NOT PROVIDE FOR EFFECTIVE EROSION CONTROL, ADDITIONAL EROSION AND SEDIMENT CONTROL MEASURES SHALL BE IMPLEMENTED TO CONTROL OR TREAT THE SEDIMENT SOURCE.
- 4.) THE ESCAPE OF SEDIMENT FROM THE SITE SHALL BE PREVENTED BY THE INSTALLATION OF EROSION CONTROL MEASURES AND PRACTICES PRIOR TO, OR CONCURRENT WITH, ALL LAND DISTURBING ACTIVITIES THROUGHOUT THE ENTIRE PROJECT.
- 5.) SEDIMENT STORAGE INDICATORS MUST BE INSTALLED IN SEDIMENT STORAGE STRUCTURES, INDICATING THE 1/3 FULL VOLUME. WHEN SILT FENCES BECOME 1/3 FULL OF SEDIMENT, THE SEDIMENT MUST BE REMOVED.
- 6.) MAINTENANCE OF ALL SOIL EROSION AND SEDIMENTATION CONTROL MEASURES AND PRACTICES, WHETHER TEMPORARY OR PERMANENT, SHALL BE AT ALL TIMES THE RESPONSIBILITY OF THE PROPERTY OWNER.
- 7.) ALL FILL SLOPES SHALL HAVE SILT FENCE PLACED AT THE SLOPE'S TOE.
- 8.) EROSION CONTROL DEVICES THAT ARE INSTALLED AS DIRECTED BY THE LAND DEVELOPMENT INSPECTOR BUT NOT SHOWN ON THE APPROVED PLAN AND WHICH ALSO SUBSEQUENTLY FAIL, ARE THE RESPONSIBILITY OF THE CONTRACTOR.
- 9.) ALL TEMPORARY AND PERMANENT SEEDING MUST BE PERFORMED AT THE APPROPRIATE SEASON. ADDITIONAL PLANTINGS WILL BE NECESSARY IF A SUFFICIENT STAND OF GRASS FAILS TO GROW.
- 10.) TOPSOIL SHALL BE STOCKPILED AND USED TO DRESS FINAL GRADES.
- 11.) NO PORTION OF THE SUBJECT PROPERTY LIES WITHIN A 100 YEAR FLOOD HAZARD AREA.
- 12.) STANDARDS & SPECIFICATIONS: ALL DESIGNS WILL CONFIRM TO AND ALL WORK WILL BE PERFORMED IN ACCORDANCE WITH THE STANDARDS AND SPECIFICATIONS DETAILED IN THE CURRENT DEVELOPMENT REGULATIONS OF TOWN OF BOONE AND THE PUBLICATION "EROSION AND SEDIMENT CONTROL PLANNING AND DESIGN MANUAL".
- 13.) THE CONTRACTOR WILL CLEAN OUT ACCUMULATED SILT IN THE STORM DRAINAGE PIPES AT END OF CONSTRUCTION WHEN DISTURBED AREAS HAVE BEEN STABILIZED.
- 14.) APPROVAL OF THESE PLANS DOES NOT CONSTITUTE APPROVAL BY WATAUGA COUNTY OR EPD OF ANY LAND DISTURBING ACTIVITIES WITHIN WETLAND AREAS. IT IS THE RESPONSIBILITY OF THE PROPERTY OWNER TO CONTACT THE APPROPRIATE REGULARITY AGENCY FOR APPROVAL OF ANY WETLAND THAT IS DISTURBED.
- 15.) APPROVAL OF THESE PLANS DOES NOT CONSTITUTE APPROVAL BY TOWN OF BOONE OR EPD OF ANY LAND DISTURBING ACTIVITIES WHICH MAY IMPACT AND ENDANGERED SPECIES. IT IS THE RESPONSIBILITY OF THE PROPERTY OWNER TO CONTACT THE APPROPRIATE REGULATORY AGENCY FOR APPROVAL OF ANY DISTURBANCE WHICH MAY HAVE THIS EFFECT.

NPDES STABILIZATION TABLE:

| Site Area Description                          | Stabilization Time Frame | Stabilization Time Frame Exceptions   |
|--|--------------------------|---|
| • Perimeter dikes, swales, ditches and slopes  | 7 days                   | None  |
| • High Quality Water (HQW) Zones               | 7 days                   | None  |
| • Slopes steeper than 3:1                      | 7 days                   | If slopes are 10' or less in length and are not steeper than 3:1, 14 days are allowed |
| • Slopes 3:1 or flatter                        | 14 days                  | 7 days for slopes greater than 50 feet in length                                      |
| • All other areas with slopes flatter than 4:1 | 14 days                  | None (except for perimeter dikes and HQW Zones)                                       |

\* Extensions of time may be approved by the permitting authority based on weather or other site-specific conditions that make compliance impracticable. (Section II.B(2)(b))

ANTICIPATED ACTIVITY SCHEDULE

BEGIN CONSTRUCTION - MAY 15, 2023  
END CONSTRUCTION - NOVEMBER 15, 2023

| ACTIVITY                                   | 1.0 MTH | 2.0 MTH | 3.0 MTH | 4.0 MTH | 5.0 MTH | 6.0 MTH |
|--|---------|---------|---------|---------|---------|---------|
| 1 INITIAL EROSION CONTROL BMP INSTALLATION |         |         |         |         |         |         |
| 2 MAINTENANCE OF E&SC PRACTICES            |         |         |         |         |         |         |
| 3 CLEARING, GRUBBING, & DEMO               |         |         |         |         |         |         |
| 4 GRADING                                  |         |         |         |         |         |         |
| 5 STORM & UTILITY INSTALLATION             |         |         |         |         |         |         |
| 6 PAVING/STRIPING & HARDSCAPE              |         |         |         |         |         |         |
| 7 TEMPORARY SEEDING                        |         |         |         |         |         |         |
| 8 PERMANENT VEGETATION                     |         |         |         |         |         |         |
| 9 FINAL CLEAN UP                           |         |         |         |         |         |         |


RIP RAP STORM DRAIN OUTLET PROTECTION  
- LENGTH = 10'  
- WIDTH = 11.25'  
- D50 = 0.75'  
- Dmax = 1.0'

PROPOSED MATTING AND BLANKET ON SLOPE

PROPOSED SILT FENCE

PROPOSED INLET PROTECTION TO EXISTING PIPE

PROPOSED SILT SACK INLET PROTECTION (TYP.)

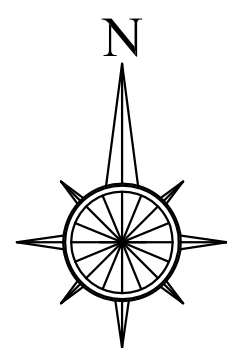

PROJECT:



ROCKY KNOB PARK EXPANSION

ADDRESS: 285 MOUNTAIN BIKE WAY | BOONE | WATAUGA COUNTY | NC | 28607

CLIENT:



WATAUGA CO. TDA

CONTACT: L. WRIGHT TILLEY, EXECUTIVE DIRECTOR  
ADDRESS: 331 QUEEN STREET, SUITE 101 | BOONE | WATAUGA COUNTY | NC | 28607

CIVIL ENGINEER:



DESTINATION BY DESIGN ENGINEERING

ADDRESS: 136 FURMAN RD., STE. 6  
BOONE | NC | 28607

SEAL:



REVISIONS DATE

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PROJECT MANAGER: CAG

DRAWING BY: JEG

JURISDICTION: WATAUGA COUNTY

DATE: 04/28/23











SHEET TITLE:

EROSION CONTROL PLAN


SHEET NUMBER: C-3

SCALE: 1" = 10'  
10 5 0 10 20  
SCALE IN FEET



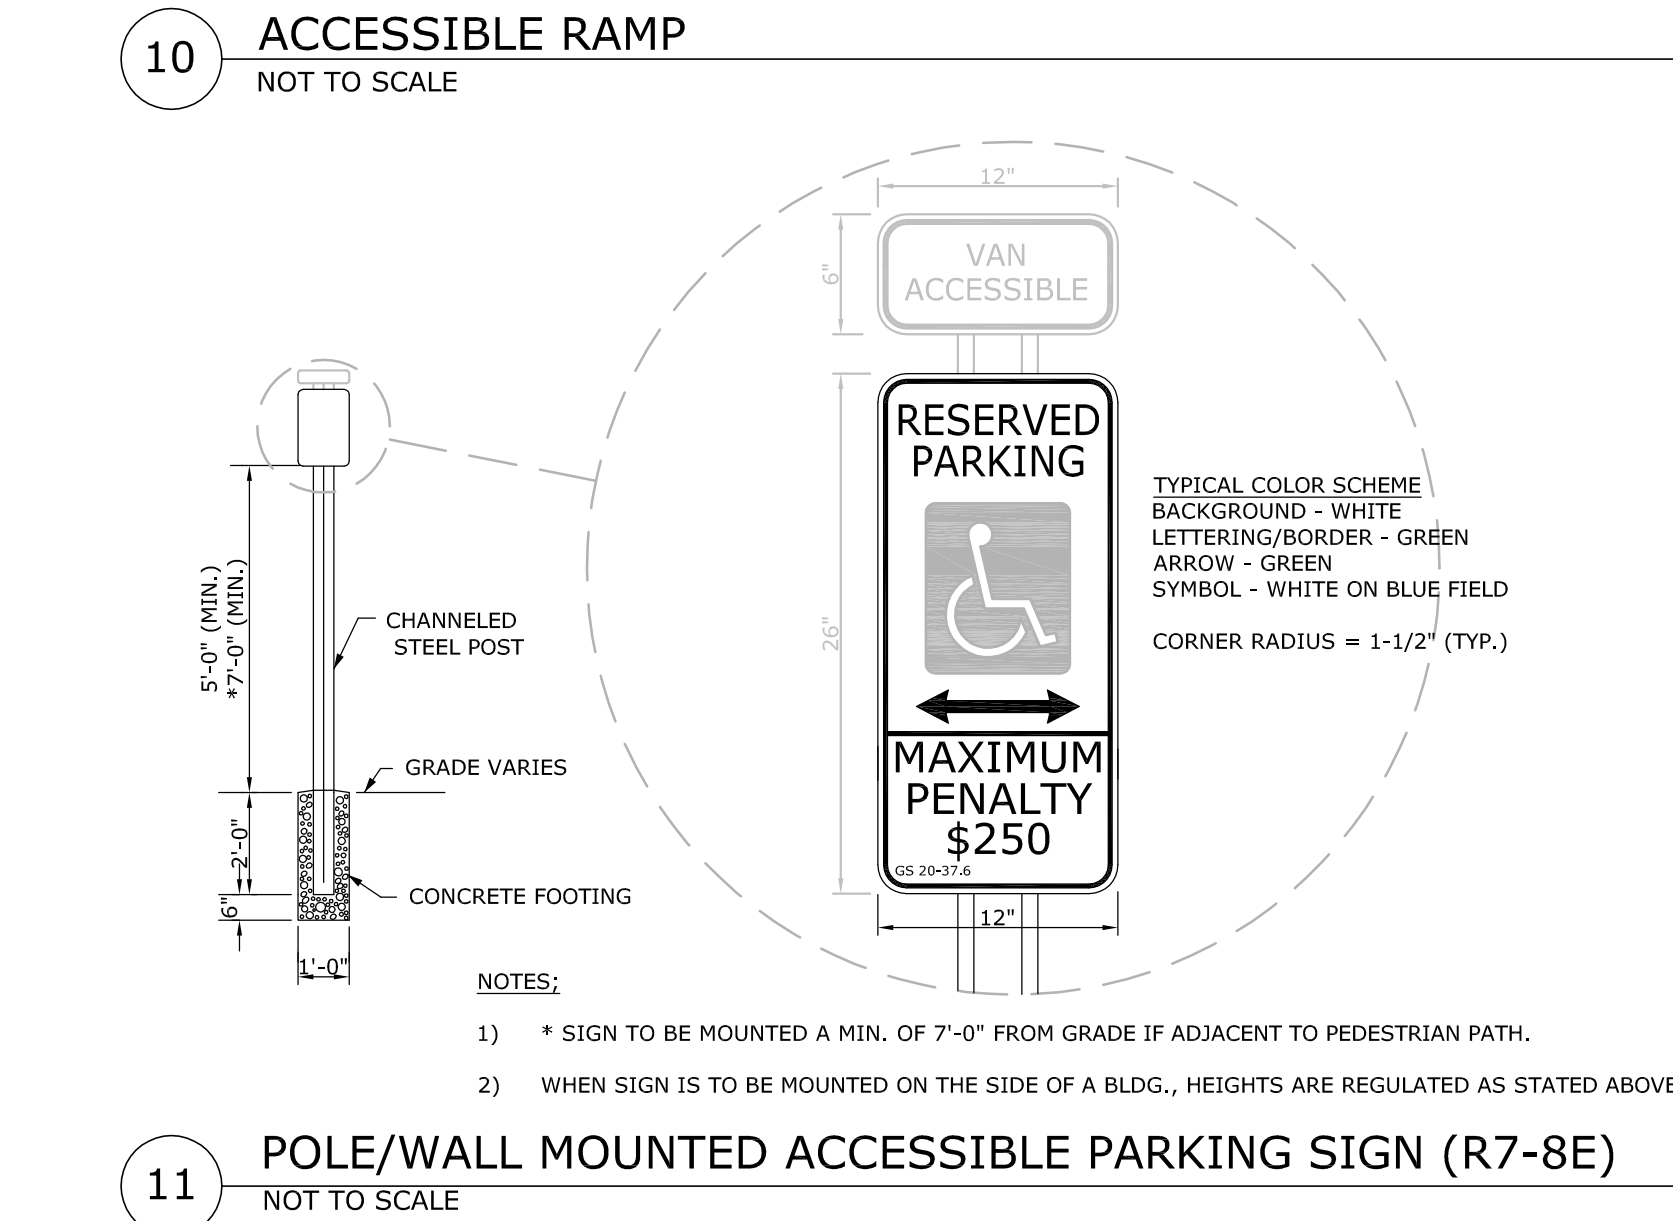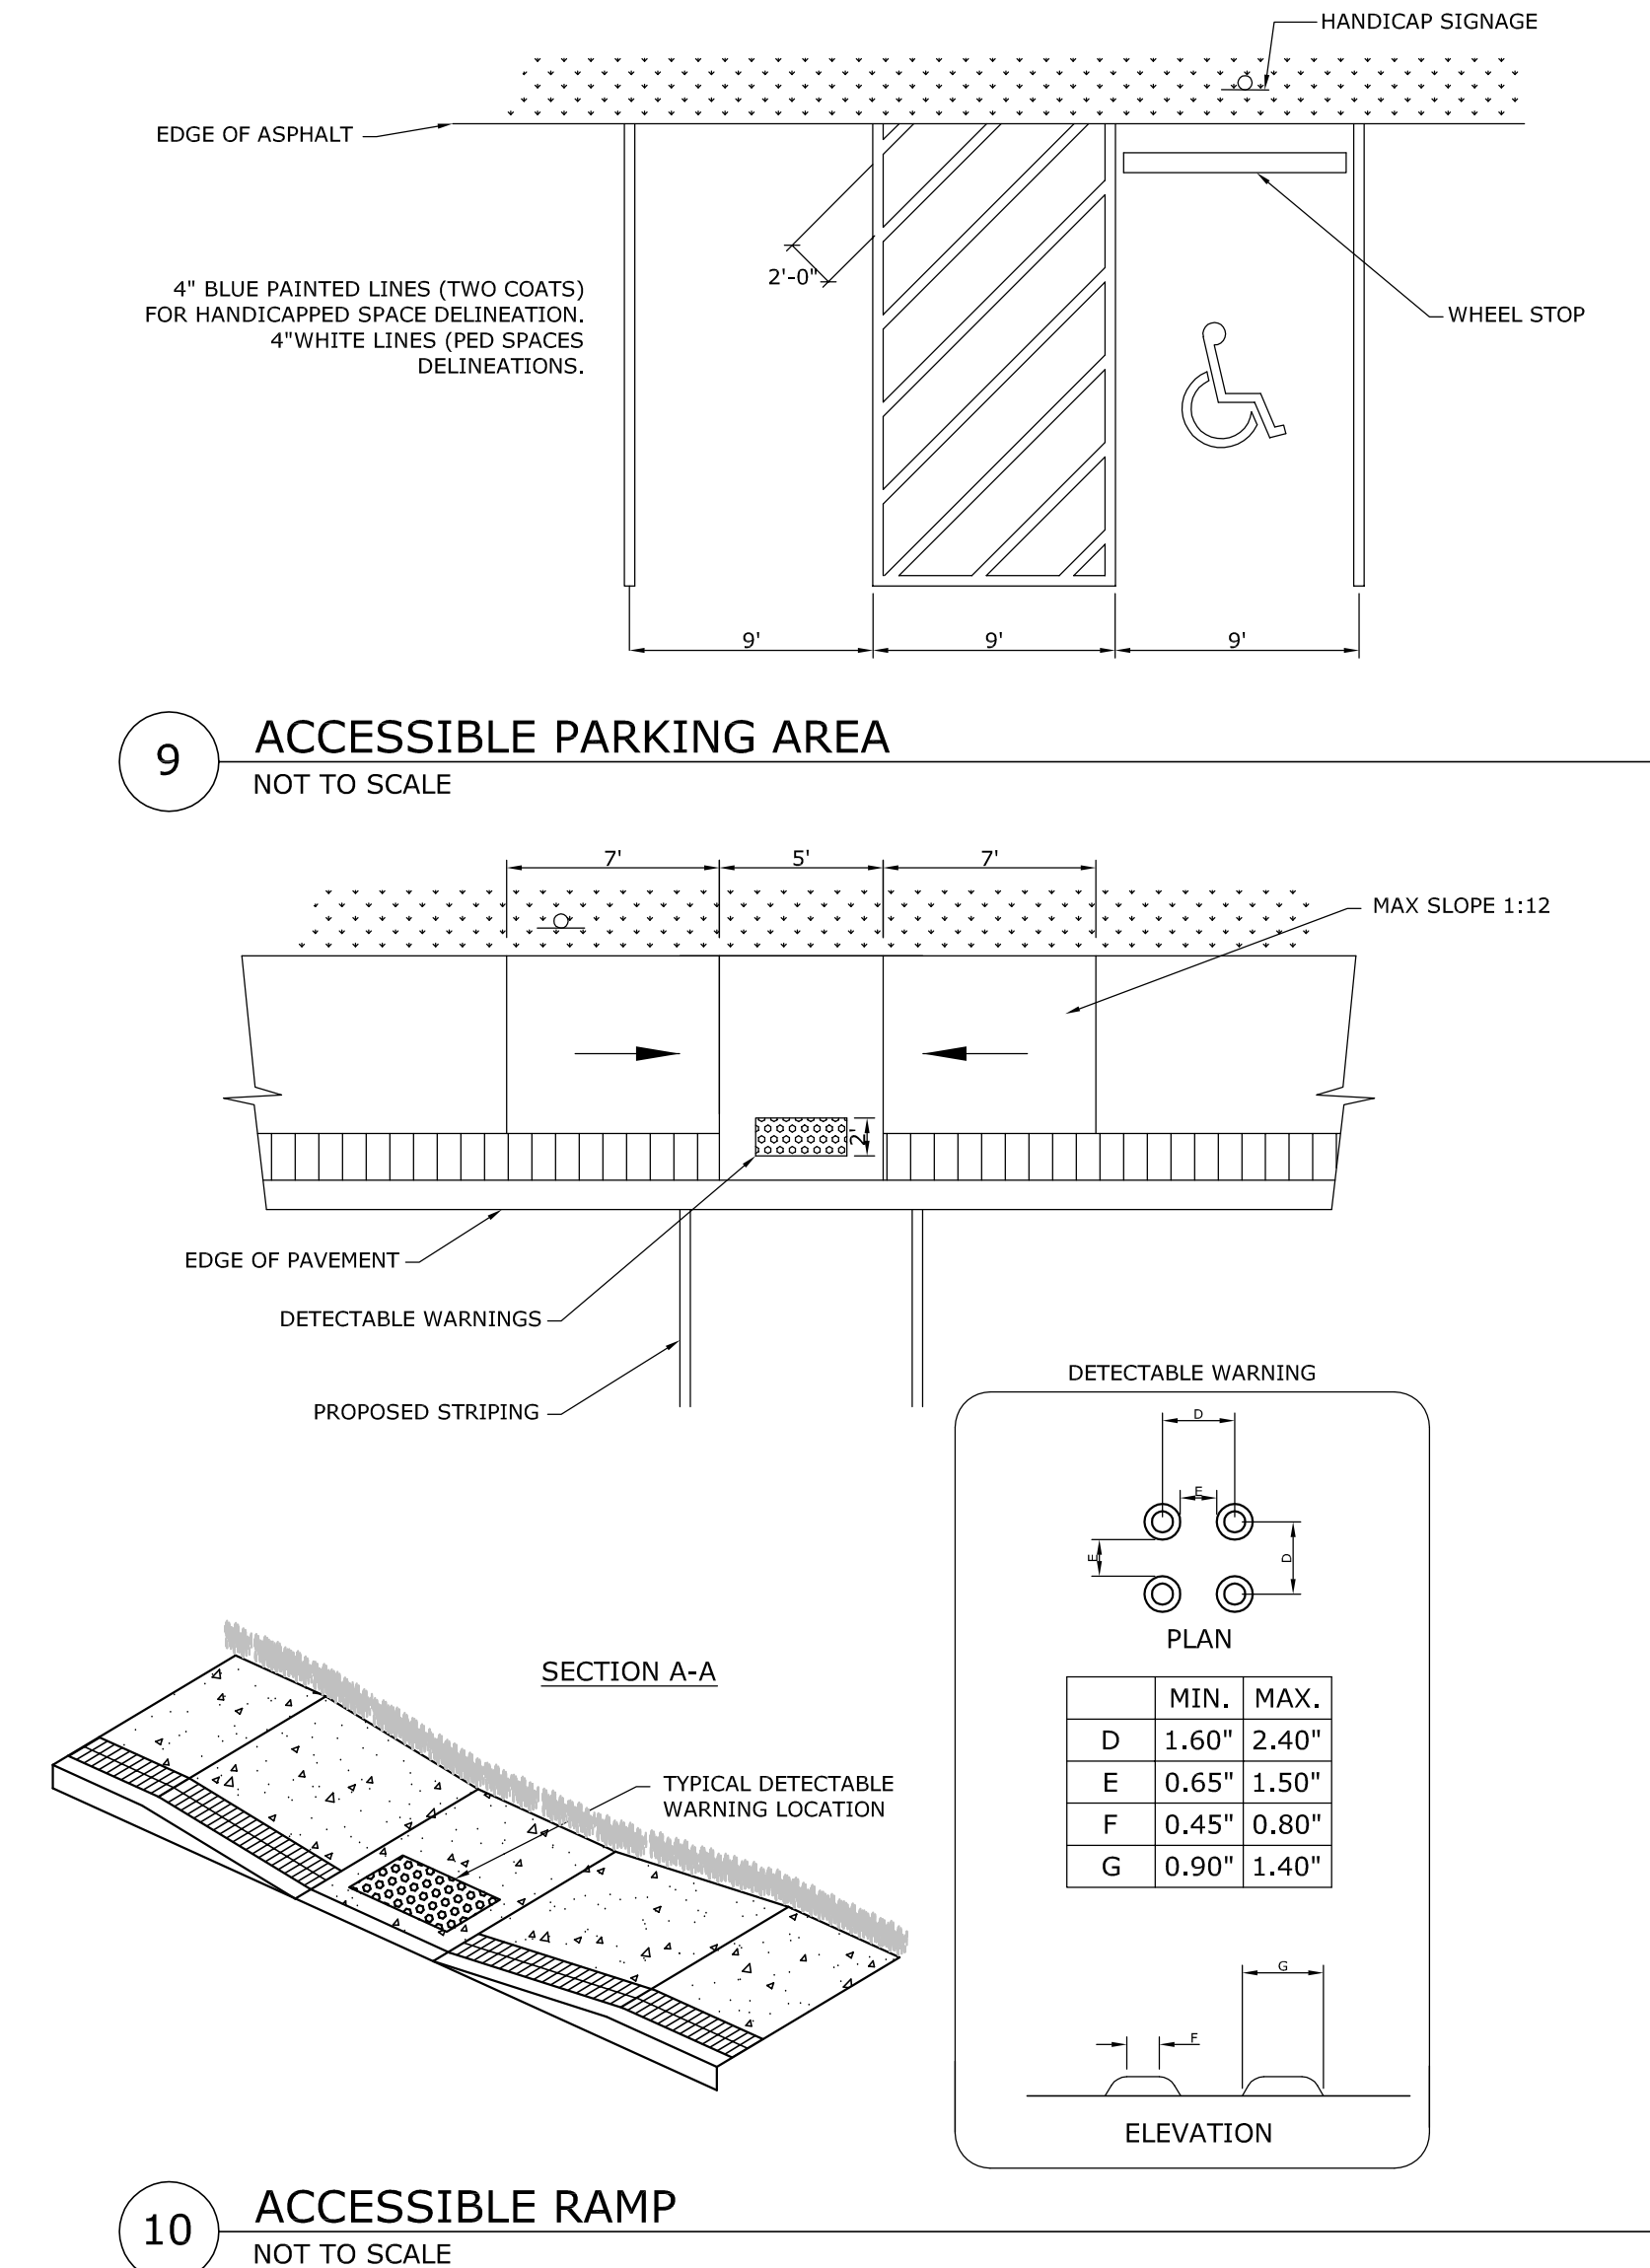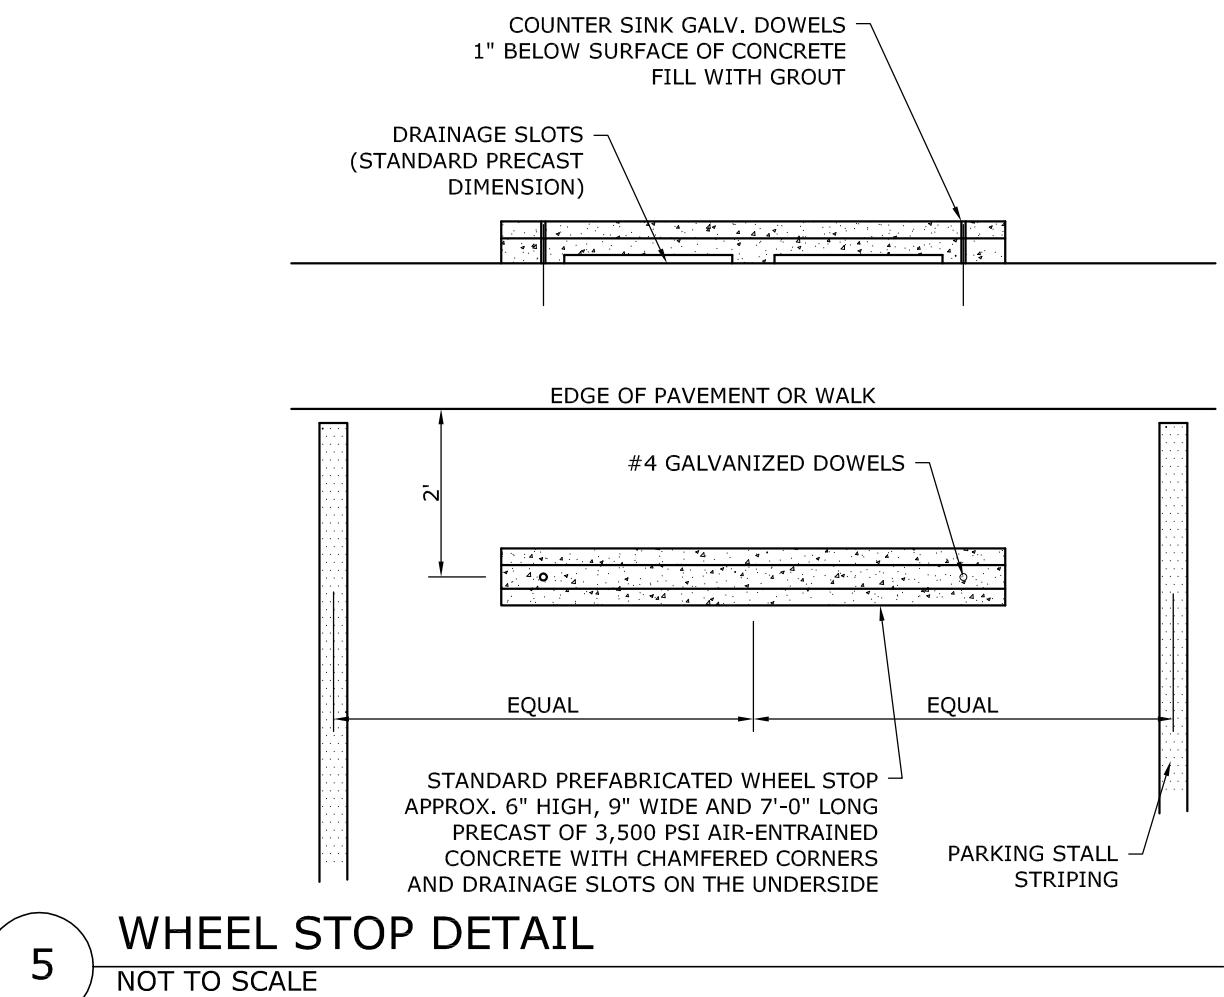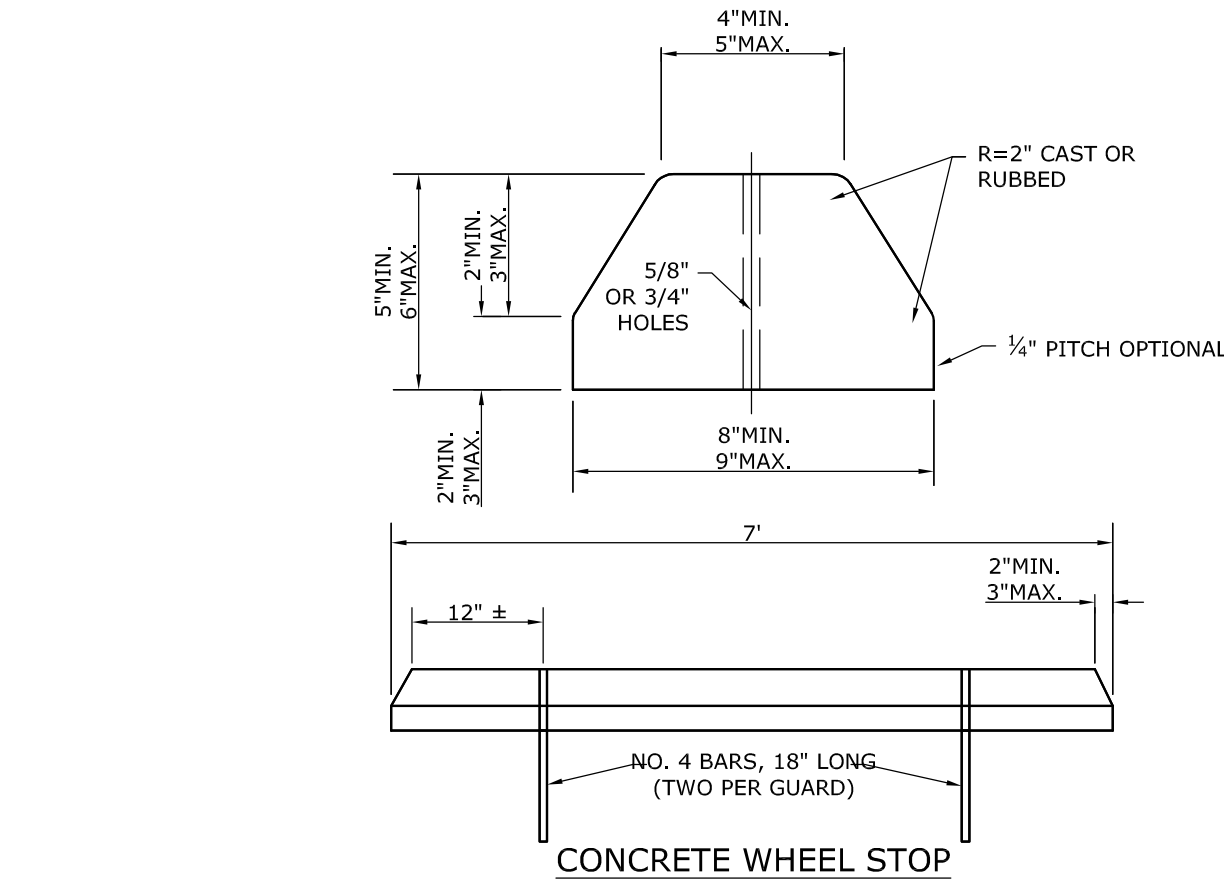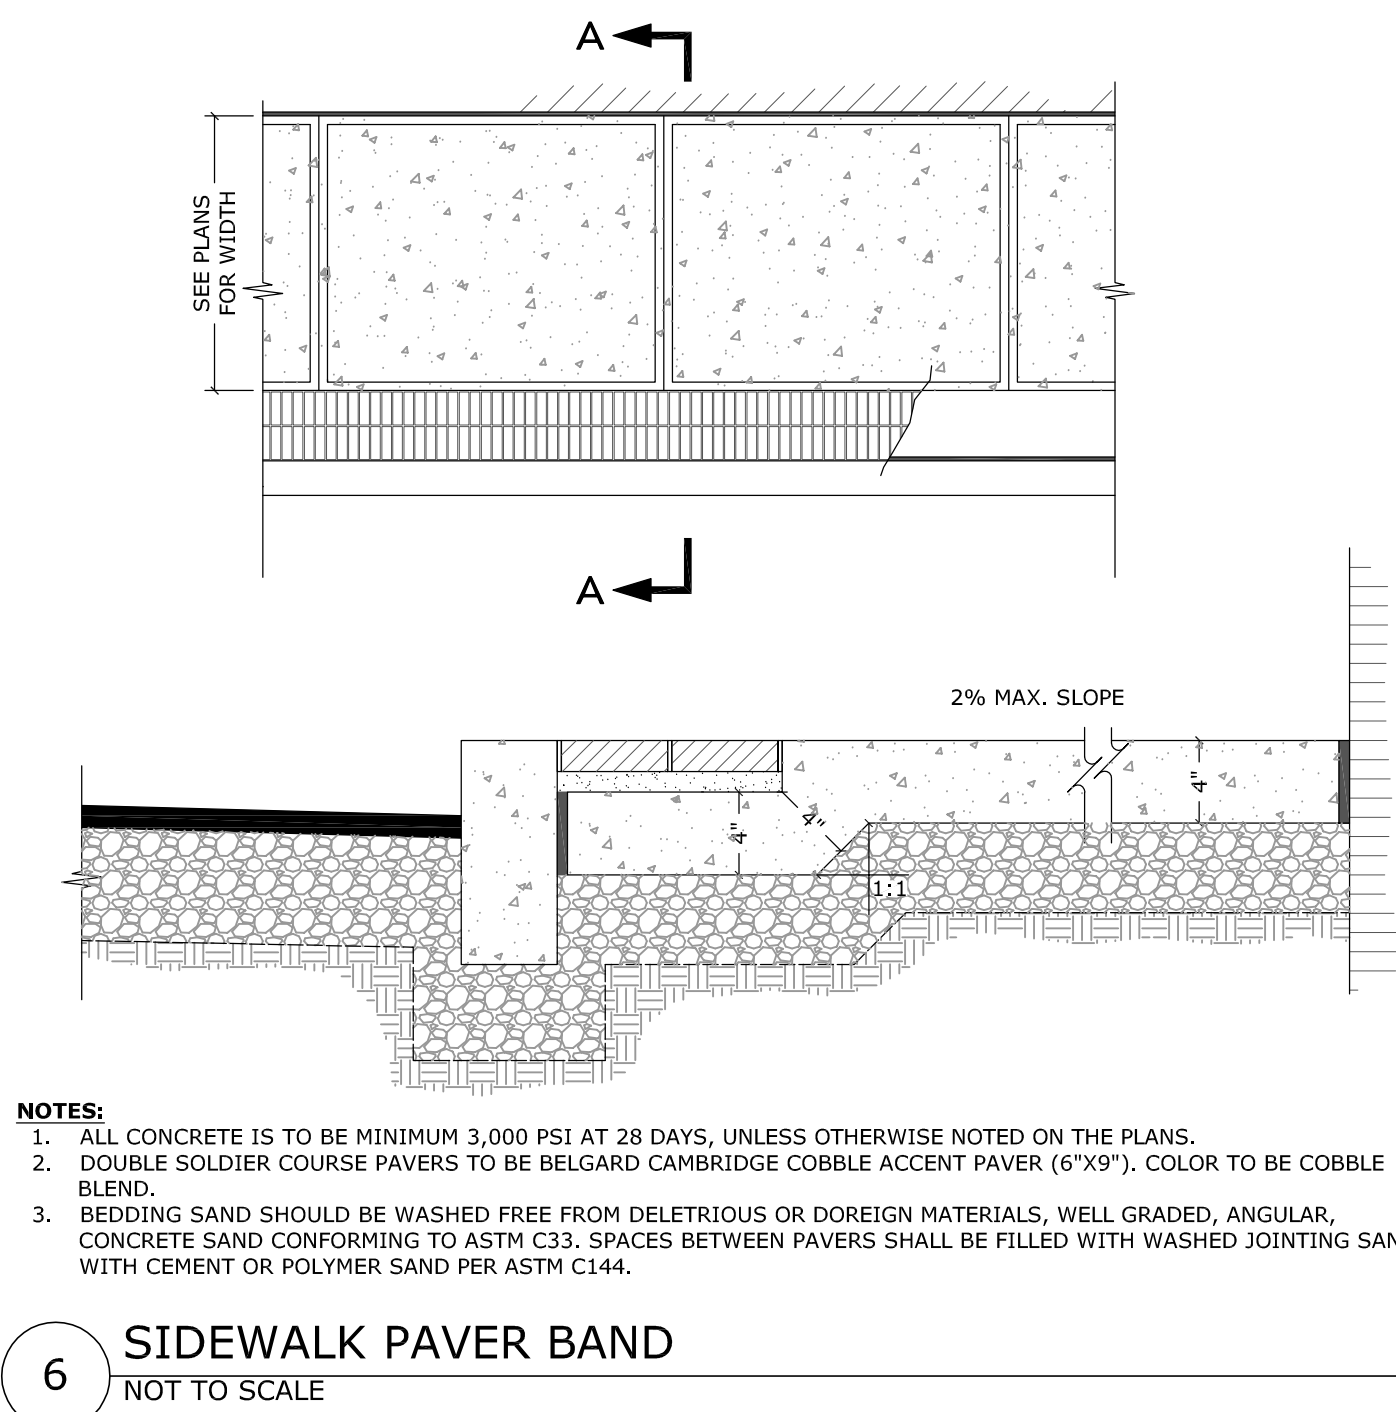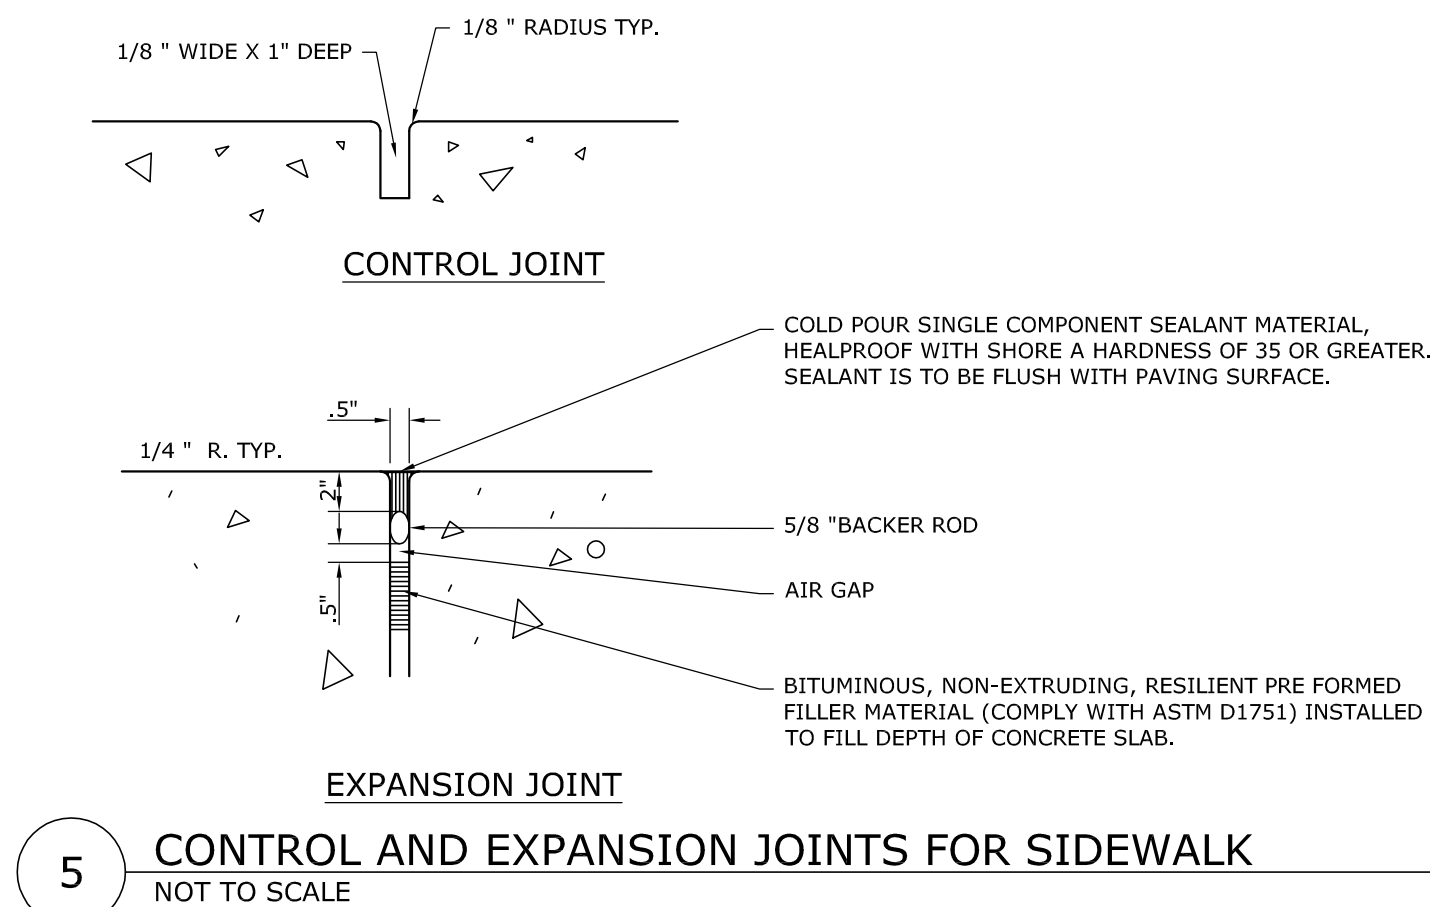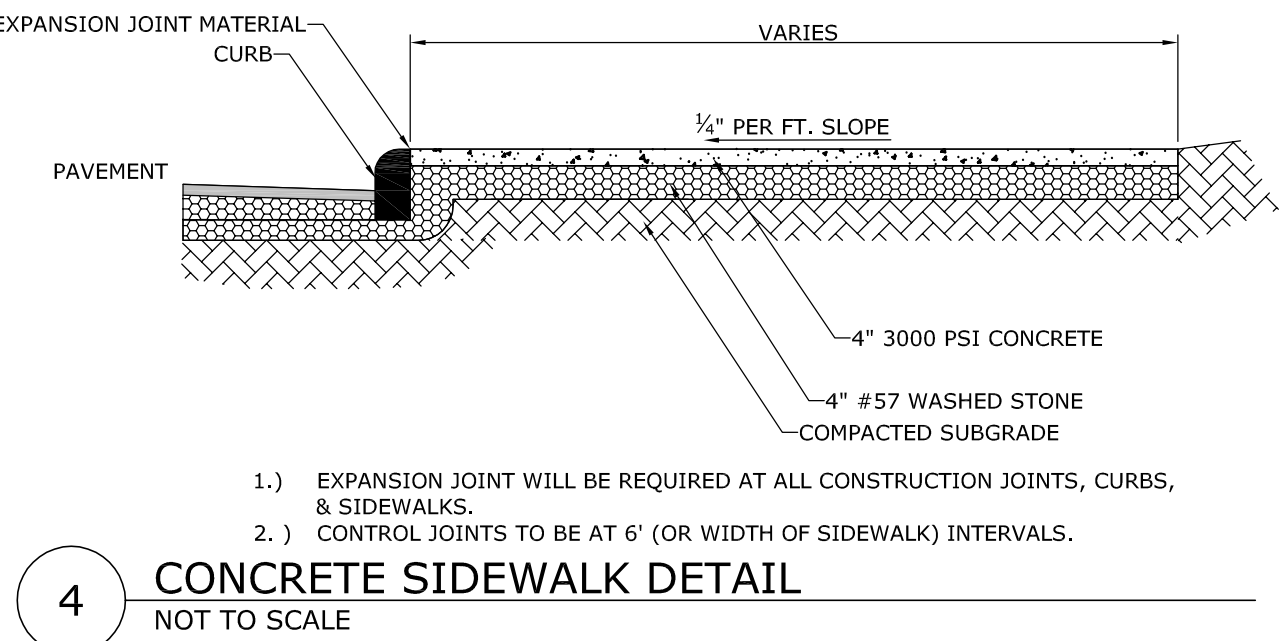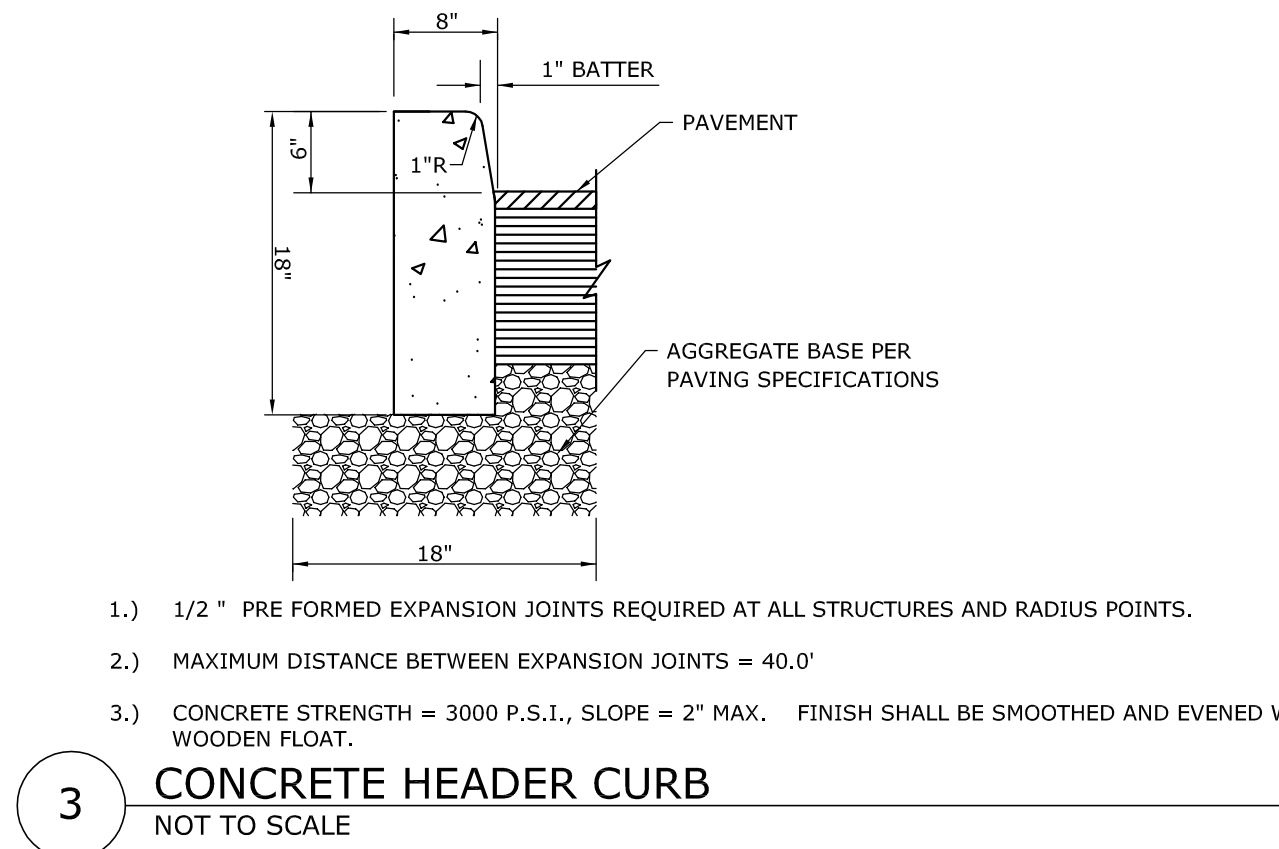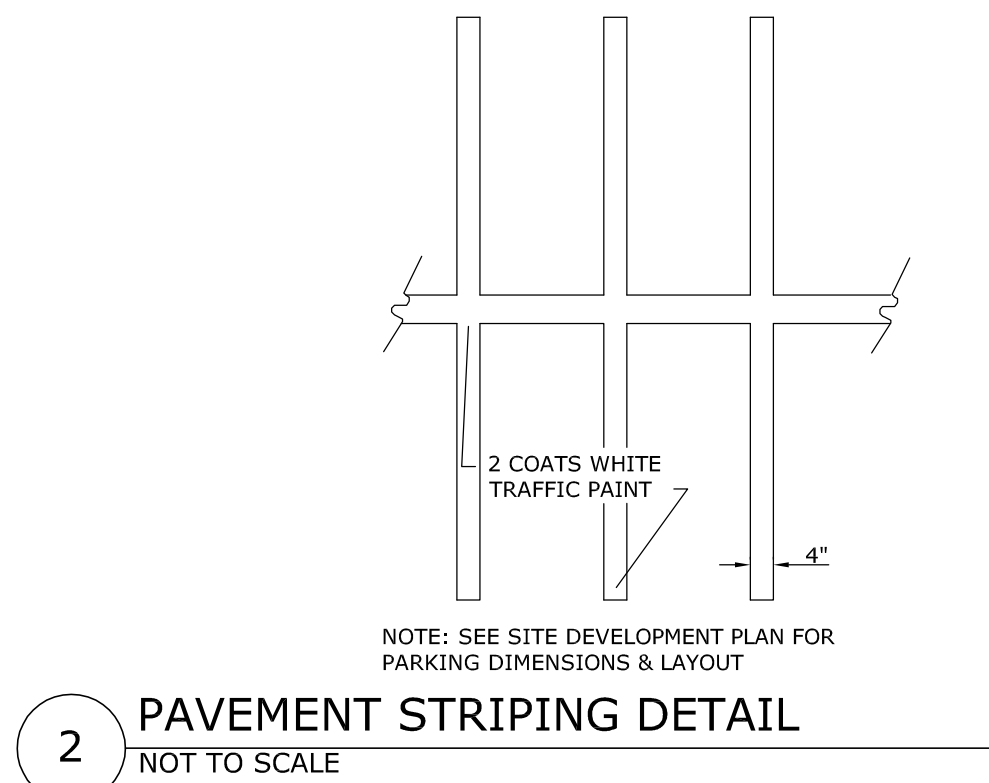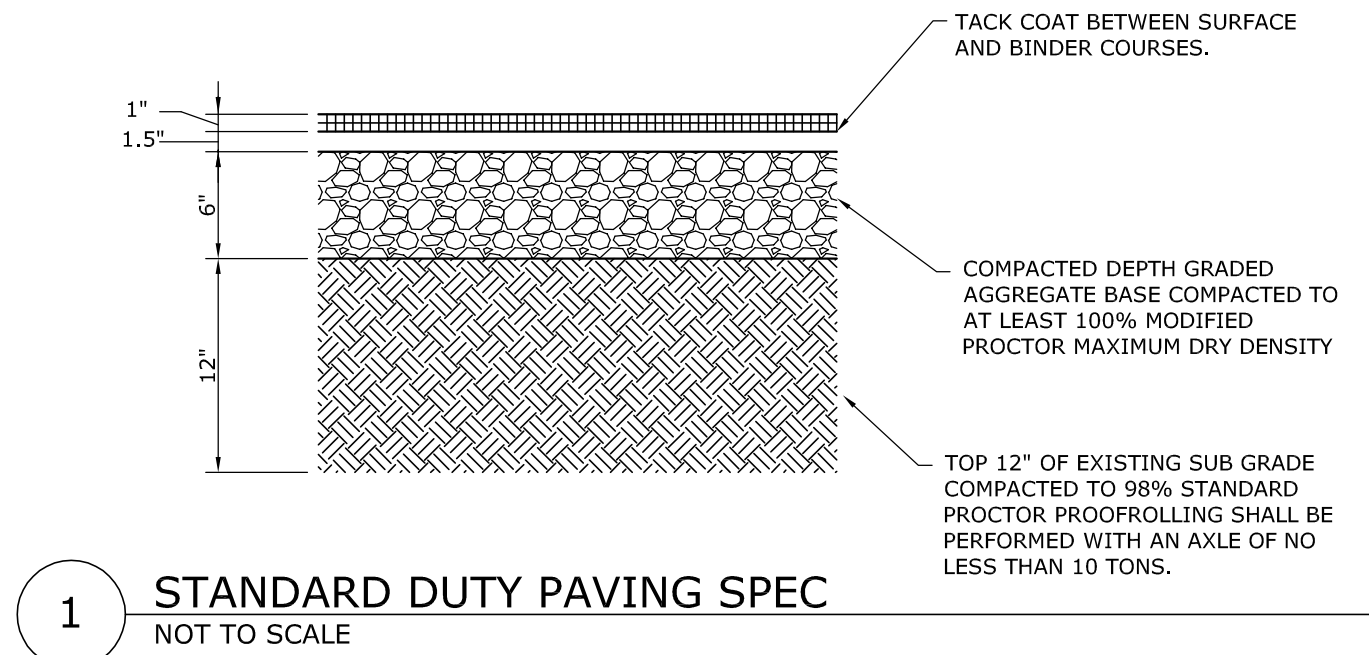


PROJECT:



ROCKY KNOB PARK  
EXPANSION

ADDRESS: 285 MOUNTAIN BIKE WAY | BOONE | WATAUGA COUNTY | NC | 28607

CLIENT:



WATAUGA CO. TDA

CONTACT: L. WRIGHT TILLEY, EXECUTIVE DIRECTOR

ADDRESS: 331 QUEEN STREET, SUITE 101 | BOONE | WATAUGA COUNTY | NC | 28607

CIVIL ENGINEER:




DESTINATION BY DESIGN

DESTINATION BY DESIGN ENGINEERING

ADDRESS: 136 FURMAN RD., STE. 6 BOONE | NC | 28607

SEAL:




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| PROJECT MANAGER: | CAG            |
| DRAWING BY:      | JEG            |
| JURISDICTION:    | WATAUGA COUNTY |
| DATE:            | 04/28/23       |
| SHEET TITLE:     |                |


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| MISC.                |     |
| CONSTRUCTION DETAILS |     |
| SHEET NUMBER:        | C-4 |
| SCALE:               | NTS |







TRAFFICGUARD, INC.  
P.O. BOX 201  
GENEVA, IL 60134-9966  
TOLL FREE: 1-877-727-7347  
FAX: (800) 814-7194  
www.trafficguard.net

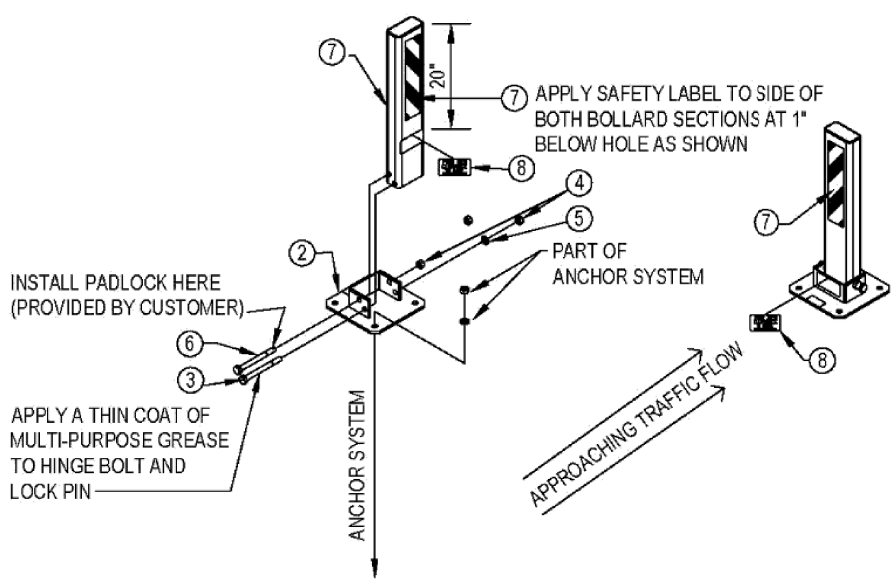

INSTALL PADLOCK HERE  
(PROVIDED BY CUSTOMER)

APPLY A THIN COAT OF  
MULTI-PURPOSE GREASE  
TO HINGE BOLT AND  
LOCK PIN

ANCHOR SYSTEM


APPROACHING TRAFFIC FLOW

APPLY SAFETY LABEL TO SIDE OF  
BOTH BOLLARD SECTIONS AT 1'  
BELOW HOLE AS SHOWN

PART OF  
ANCHOR SYSTEM

| BILL OF MATERIAL |   |     |
|------------------|---|-----|
| ITEM / PART #    | DESCRIPTION                               | QTY |
| 1 LPHDHB1        | LPHDHB POST                               | 1   |
| 2 LPHDHB2        | LPHDHB BASE                               | 1   |
| 3 0010           | 3/4" x 8" HEX HEAD HINGE BOLT-18-4 SS     | 1   |
| 4 0008           | 3/4" HEX NUT-18-8 SS                      | 2   |
| 5 1009           | 2" 3/4" FLAT WASHER TYPE A NARROW-18-8 SS | 1   |
| 6 2007           | 3/4" x 8" HEX HEAD LOCKING PIN-18-8 SS    | 1   |
| 7 0107           | SAFETY LABEL 3" x 12"                     | 2   |
| 8 0102           | FOUR INCH CLEARANCE LABEL                 | 2   |

NOTES:  
1. INSTALLATION TO BE COMPLETED IN ACCORDANCE WITH MANUFACTURER'S SPECIFICATIONS.  
2. ALL DIMENSIONS ARE CONSIDERED TRUE AND REFLECT MANUFACTURER'S SPECIFICATIONS.  
3. DO NOT SCALE DRAWING.  
4. CONTRACTOR'S NOTE: FOR PRODUCT AND COMPANY INFORMATION VISIT www.CADDetails.com/info  
REFERENCE NUMBER: 4209-001.

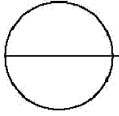

SINGLE POST


MODEL: LPHDHB - TRAFFICGUARD® SINGLE POST, ASSEMBLY DETAILS

4209-001

REVISION DATE 06/10/2021

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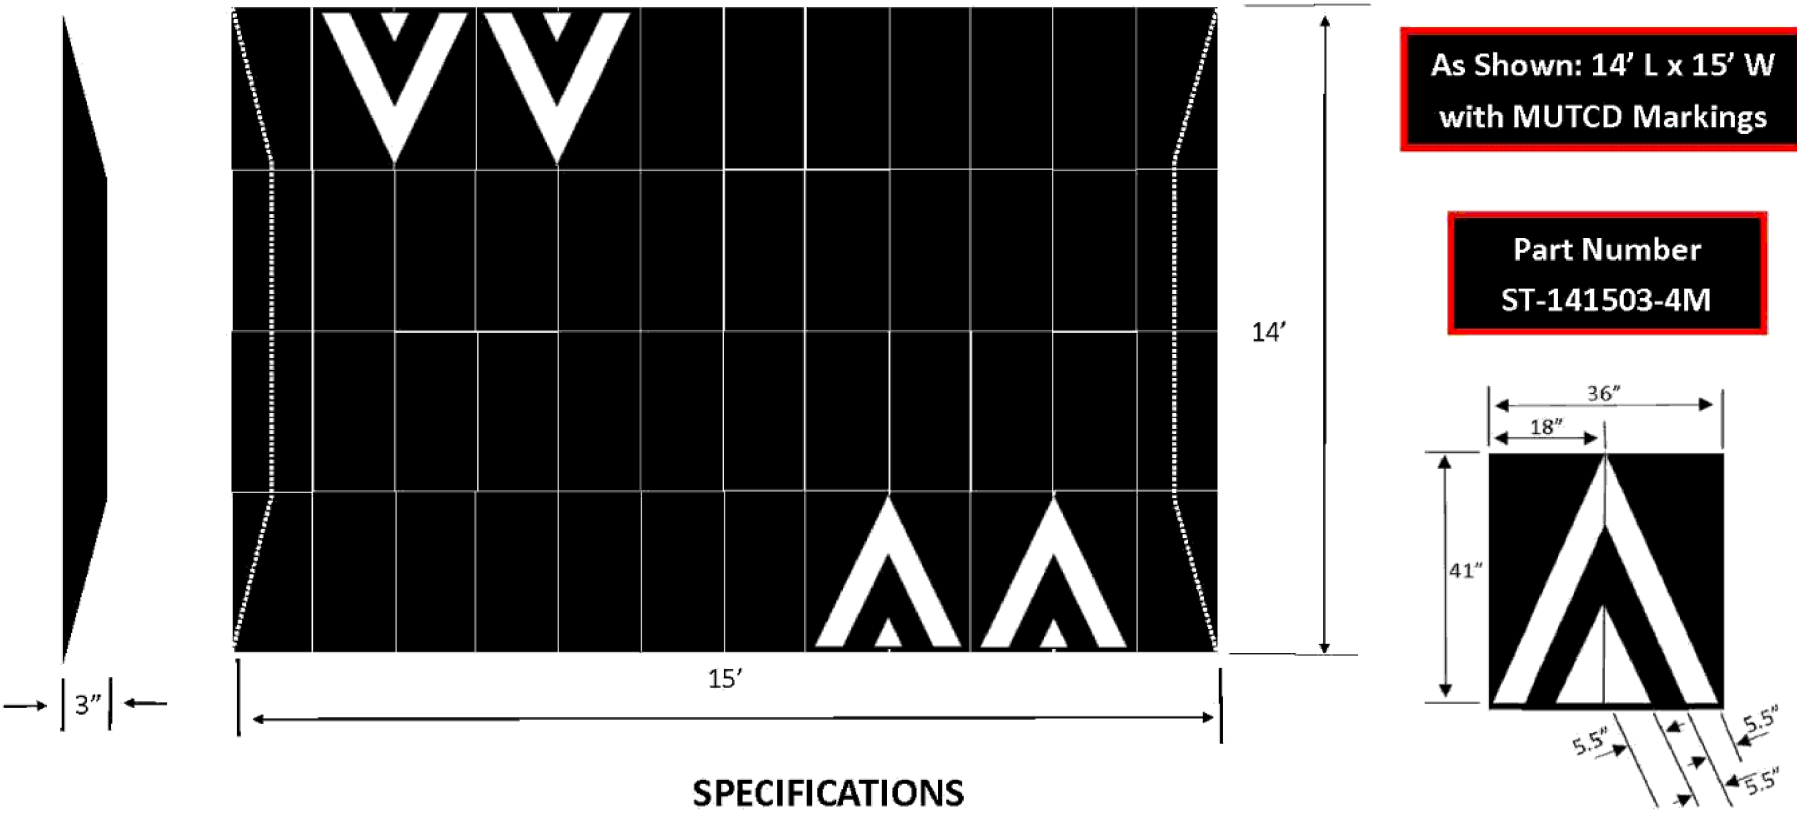
CADDetails.com



TRAFFICLOGIX

SPEED HUMPS

Speed humps are raised devices, with a flat top, placed across the road to slow traffic. The flat top design over a 14 foot length of space encourages cars to slow down without coming to a halt. Often considered the most traditional physical traffic calming solutions, speed humps calm traffic more gradually than speed bumps. They are ideal for residential roads and at 14' are designed to bring speeds to between 20-25 mph. Speed humps should ideally be installed in a series to create ongoing traffic calming.



As Shown: 14' L x 15' W  
with MUTCD Markings

Part Number  
ST-141503-4M

SPECIFICATIONS

Dimensions of the modules:  
Width: 18" (+/- 1/16")  
Length: 42" (+/- 1/8")  
Thickness: 3" (+/- 1/8")

Standard dimensions of the Speed Humps,  
Speed Cushions or Speed Tables:  
Width: according to a street width  
Length: 7', 10.5', 14'  
Height: 3"

Physical properties:  
Material: 100% recycled synthetic and natural rubber composite  
Tensile strength: minimum 500 psi  
Shore hardness: minimum 70A  
Specific gravity: 1.1  
Markings: rubber modules are available in all black, black with yellow or white reflective square markings, or with white reflective arrow chevrons. And, are embedded into the rubber.

Entrance and exit gradient: 1:15  
Side gradient: 1:3


TRAFFIC CALMING SOLUTIONS  
3 HARRIET LANE SPRING VALLEY, NY 10977  
TRAFFICLOGIX

Dimensions of the Speed Humps, Speed  
Cushions or Speed Tables: (widths and lengths  
are adjustable)  
Width: from 6' and up by 1.5' increments  
Length: from 7' and up by 3.5' increments  
Height: 3"

APPROVED EQUAL MAY ALSO BE USED.

2

SPEED HUMP  
NOT TO SCALE

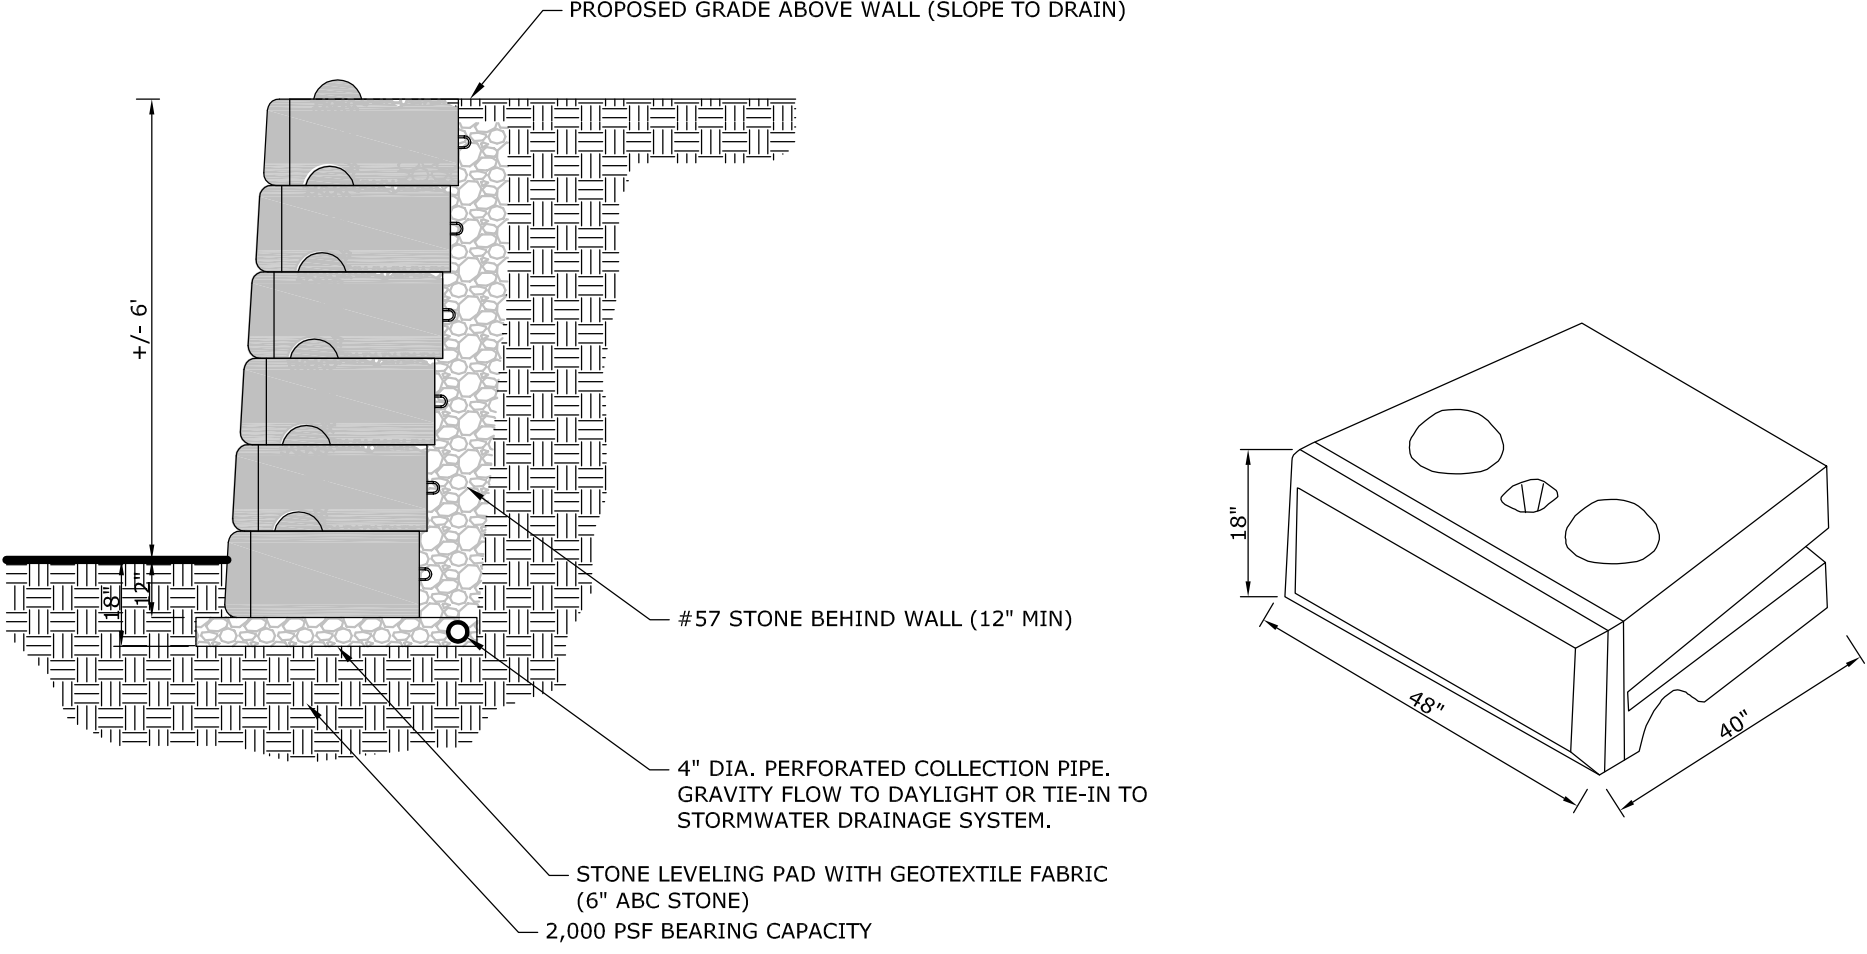

PROPOSED GRADE ABOVE WALL (SLOPE TO DRAIN)

+/- 6"


#57 STONE BEHIND WALL (12" MIN)

4" DIA. PERFORATED COLLECTION PIPE.  
GRAVITY FLOW TO DAYLIGHT OR TIE-IN TO  
STORMWATER DRAINAGE SYSTEM.


STONE LEVELING PAD WITH GEOTEXTILE FABRIC  
(6" ABC STONE)  
2,000 PSF BEARING CAPACITY

\*\* SEE RETAINING WALL REPORT FOR FURTHER DESIGN INFORMATION\*\*

PLAN SECTION "A-A"



TRAFFICGUARD, INC.  
P.O. BOX 201  
GENEVA, IL 60134-9966  
TOLL FREE: 1-877-727-7347  
FAX: (800) 814-7194  
www.trafficguard.net

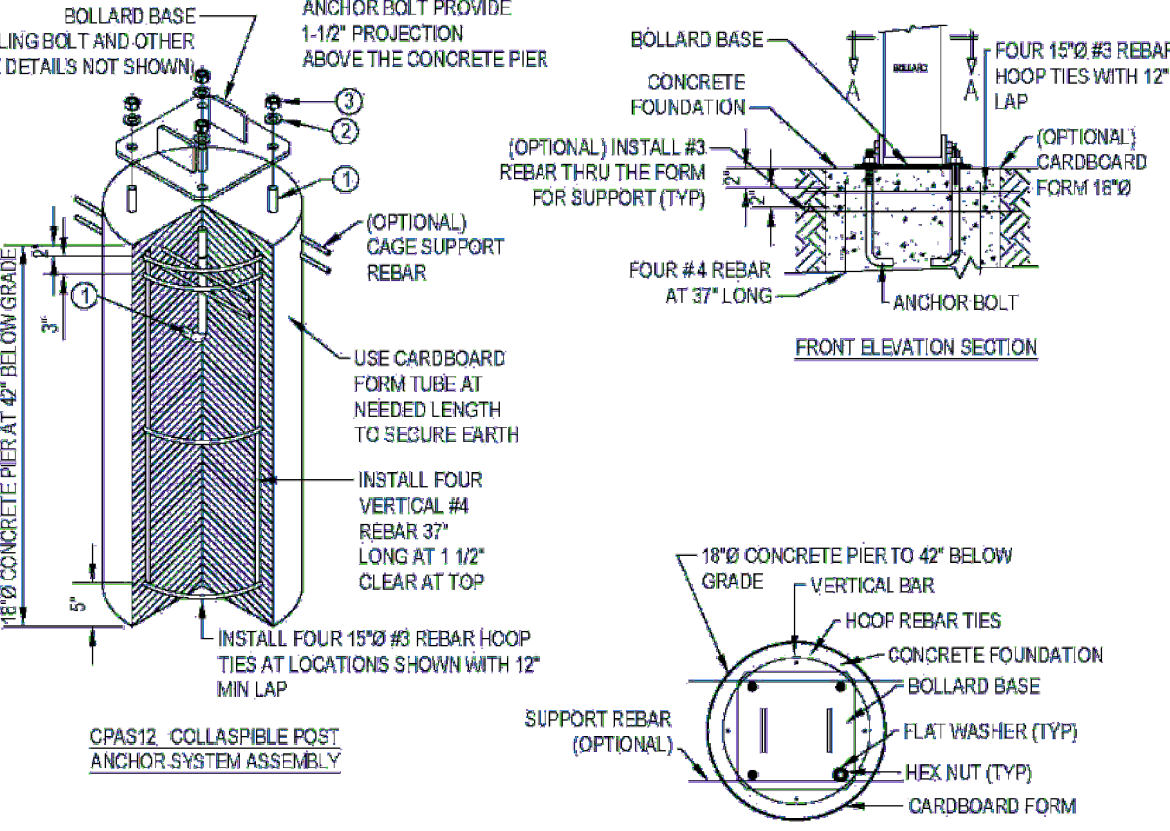

BOLLARD BASE  
(LEVELING BOLT AND OTHER  
BASE DETAILS NOT SHOWN)

ANCHOR BOLT PROVIDE:  
1-1/2" PROJECTION  
ABOVE THE CONCRETE PIER

(OPTIONAL) INSTALL #3  
REBAR THRU THE FORM  
FOR SUPPORT (TYP)

(OPTIONAL) CAGE SUPPORT  
REBAR

USE CARDBOARD  
FORM TUBE AT  
NEEDED LENGTH  
TO SECURE EARTH

INSTALL FOUR  
VERTICAL #4  
REBAR 37"  
LONG AT 1 1/2"  
CLEAR AT TOP

INSTALL FOUR 1/2" #3 REBAR HOOP  
TIES AT LOCATIONS SHOWN WITH 12"  
MIN LAP

CPAS12 COLLAPSIBLE POST  
ANCHOR SYSTEM ASSEMBLY

18" CONCRETE PIER AT 6" BELOW GRADE

18" CONCRETE PIER TO 42" BELOW  
GRADE - VERTICAL BAR

HOOP REBAR TIES

CONCRETE FOUNDATION

BOLLARD BASE

FLAT WASHER (TYP)


HEX NUT (TYP)

CARDBOARD FORM

SUPPORT REBAR  
(OPTIONAL)

LEGEND:  
① 3/4" x 12" TYPE L ANCHOR BOLT-H.D.G.  
② 3/4" TYPE A FLAT NARROW WASHER GALVANIZED STEEL  
③ 3/4" HEX NUT GALVANIZED STEEL

NOTES:  
1. THIS IS A GUIDELINE FOR ESTIMATING, SITE SPECIFIC CONDITIONS SHOULD BE VERIFIED.  
2. INSTALLATION TO BE COMPLETED IN ACCORDANCE WITH MANUFACTURER'S SPECIFICATIONS.  
3. ALL DIMENSIONS ARE CONSIDERED TRUE AND REFLECT MANUFACTURER'S SPECIFICATIONS.  
4. DO NOT SCALE DRAWING.  
5. CONTRACTOR'S NOTE: FOR PRODUCT AND COMPANY INFORMATION VISIT www.CADDetails.com/info  
REFERENCE NUMBER: 4209-001A.

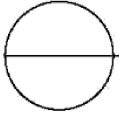

SINGLE POST

MODEL: LPHDHB - TRAFFICGUARD® SINGLE POST, FOOTING / ANCHOR SYSTEM DETAILS

4209-001A

REVISION DATE 06/10/2021


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1

COLLAPSIBLE BOLLARD  
NOT TO SCALE


PROJECT:



ROCKY KNOB PARK  
EXPANSION

ADDRESS: 285 MOUNTAIN BIKE WAY | BOONE |  
WATAUGA COUNTY | NC | 28607


CLIENT:



WATAUGA CO. TDA

CONTACT: L. WRIGHT TILLEY, EXECUTIVE  
DIRECTOR  
ADDRESS: 331 QUEEN STREET, SUITE 101 |  
BOONE | WATAUGA COUNTY | NC | 28607

CIVIL ENGINEER:




DESTINATION  
BY DESIGN

DESTINATION BY DESIGN ENGINEERING

ADDRESS: 136 FURMAN RD., STE. 6  
BOONE | NC | 28607

SEAL:

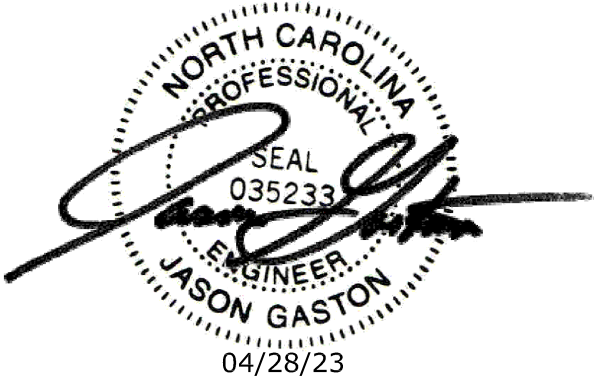

SEAL  
035233  
JASON GASTON  
04/28/23

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| PROJECT MANAGER: | CAG            |
| DRAWING BY:      | JEG            |
| JURISDICTION:    | WATAUGA COUNTY |
| DATE:            | 04/28/23       |
| SHEET TITLE:     |                |

|                               |       |
|-------------------------------|-------|
| MISC.<br>CONSTRUCTION DETAILS |       |
| SHEET NUMBER:                 | C-4.1 |
| SCALE:                        | NTS   |





Seeding mixture

Species

Rate (lb/acre)

Rye (grain)

Annual lespedeza (Kobe in Piedmont and Coastal Plain, Korean in Mountains)

120

50

Omit annual lespedeza when duration of temporary cover is not to extend beyond June.

Seeding dates

Mountains—Above 2500 feet: Feb. 15 - May 15

Below 2500 feet: Feb. 1- May 1

Piedmont—Jan. 1 - May 1

Coastal Plain—Dec. 1 - Apr. 15

Soil amendments


Follow recommendations of soil tests or apply 2,000 lb/acre ground agricultural limestone and 750 lb/acre 10-10-10 fertilizer.

Mulch

Apply 4,000 lb/acre straw. Anchor straw by tacking with asphalt, netting, or a mulch anchoring tool. A disk with blades set nearly straight can be used as a mulch anchoring tool.

Maintenance

Refertilize if growth is not fully adequate. Reseed, refertilize and mulch immediately following erosion or other damage.

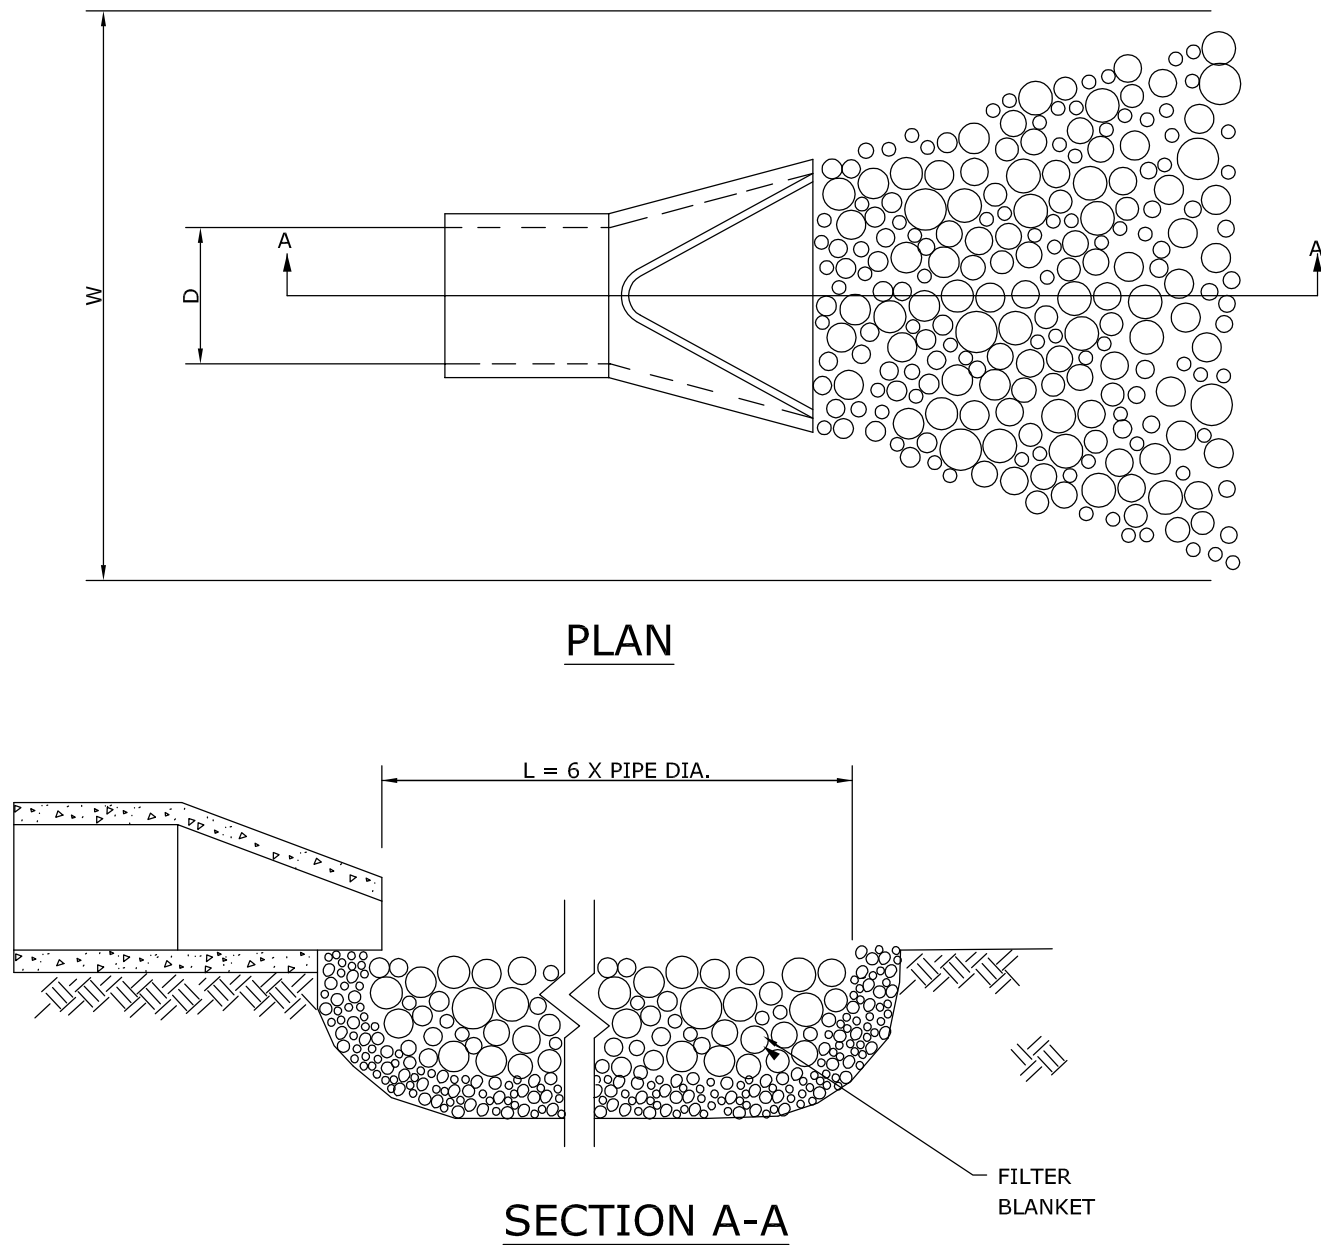


NOTES:  
1. L IS THE LENGTH OF THE RIPRAP APRON.  
2. D= 1.5 TIMES THE MAXIMUM STONE DIAMETER BUT NOT LESS THAN 6".  
3. IN A WELL-DEFINED CHANNEL EXTEND THE APRON UP THE CHANNEL BANKS TO AN ELEVATION OF 6" ABOVE THE TOP OF PIPE OR TO THE TOP OF THE BANK, WHICHEVER IS LESS.  
4. A FILTER BLANKET OR FILTER FABRIC SHALL BE INSTALLED BETWEEN THE RIPRAP AND SOIL FOUNDATION.  
5. GRADED RIPRAP STONE (MIN. 50 LB. STONE) NSA, NO. R-4 - 12" mix. 6" ave  
6. FILTER STONE NO. FS-2

| Rip-Rap Apron Summary |                         |                 |                    |                          |                       |                     |  |
|-----------------------|-------------------------|-----------------|--------------------|--------------------------|-----------------------|---------------------|--|
| Headwall ID           | Pipe Diameter, Do (in.) | 25-year Q (cfs) | Rip-Rap Size (d50) | Initial Apron Width (ft) | Apron Length, La (ft) | Apron Width, W (ft) |  |
| 100                   | 15                      | 1.98            | 0.5                | 3.75                     | 10                    | 11.25               |  |
| 200                   | 15                      | 0.32            | 0.5                | 3.75                     | 10                    | 11.25               |  |

### RR RIP RAP

NOT TO SCALE

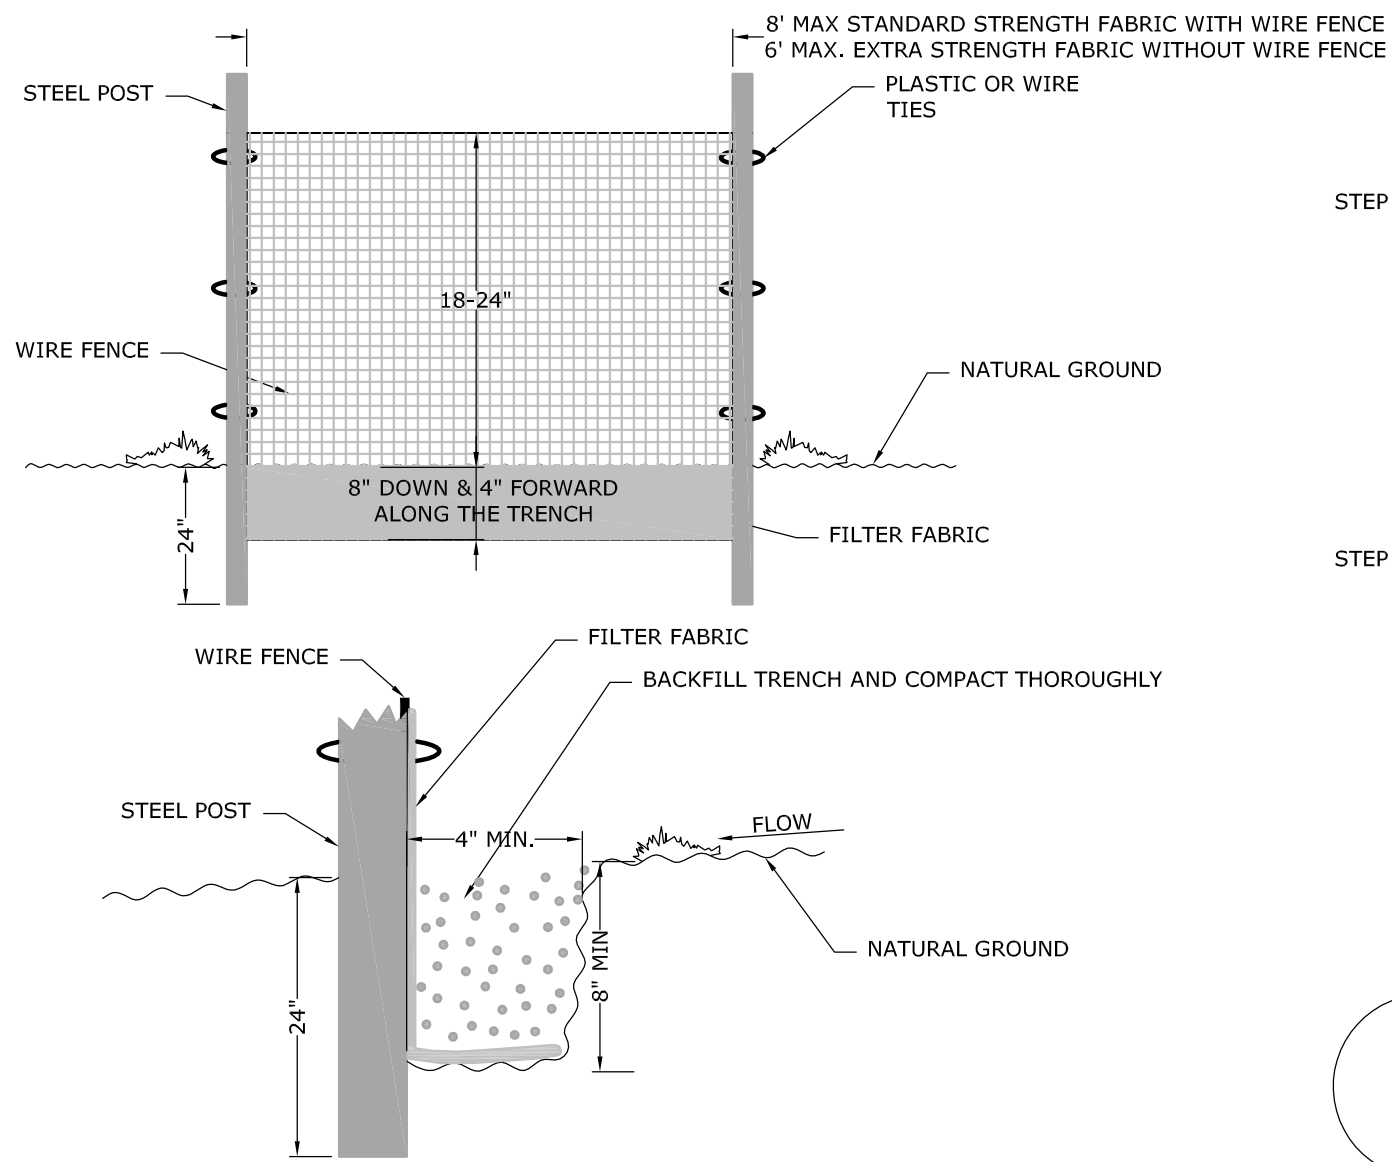

### SF SILT FENCE DETAIL


NOT TO SCALE

TABLE 1.  
SPRAY-ON ADHESIVE APPLICATION REQUIREMENTS

| ADHESIVE                 | WATER DILUTION | NOZZLE TYPE  | APPLICATION (GAL/ACRE) |
|--------------------------|----------------|--------------|------------------------|
| ANIONIC ASPHALT EMULSION | 7:1*           | COURSE SPRAY | 1,200                  |
| LATEX EMULSION           | 12.5:1*        | FINE SPRAY   | 235                    |
| RESIN-IN-WATER EMULSION  | 4:1*           | FINE SPRAY   | 300                    |


\* USE MANUFACTURER'S RECOMMENDATIONS WHEN AVAILABLE

- 1.) APPLY ACCORDING TO APPROVED PLAN, IF SHOWN.
- 2.) MULCH DISTURBED AREAS AND TACKIFY WITH RESINS SUCH AS ASPHALT, CURASOL, OR TERRATAK ACCORDING TO MANUFACTURER'S RECOMMENDATIONS.
- 3.) STABILIZE DISTURBED AREAS WITH TEMPORARY OR PERMANENT VEGETATION.
- 4.) IRRIGATE DISTURBED AREAS UNTIL SURFACE IS WET.
- 5.) COVER SURFACES WITH CRUSHED STONE OR GRAVEL.
- 6.) APPLY CALCIUM CHLORIDE AT A RATE TO KEEP SURFACES MOIST.
- 7.) APPLY SPRAY-ON ADHESIVES TO MINERAL SOILS (NOT MUCK SOILS) AS DESCRIBED IN TABLE 1.

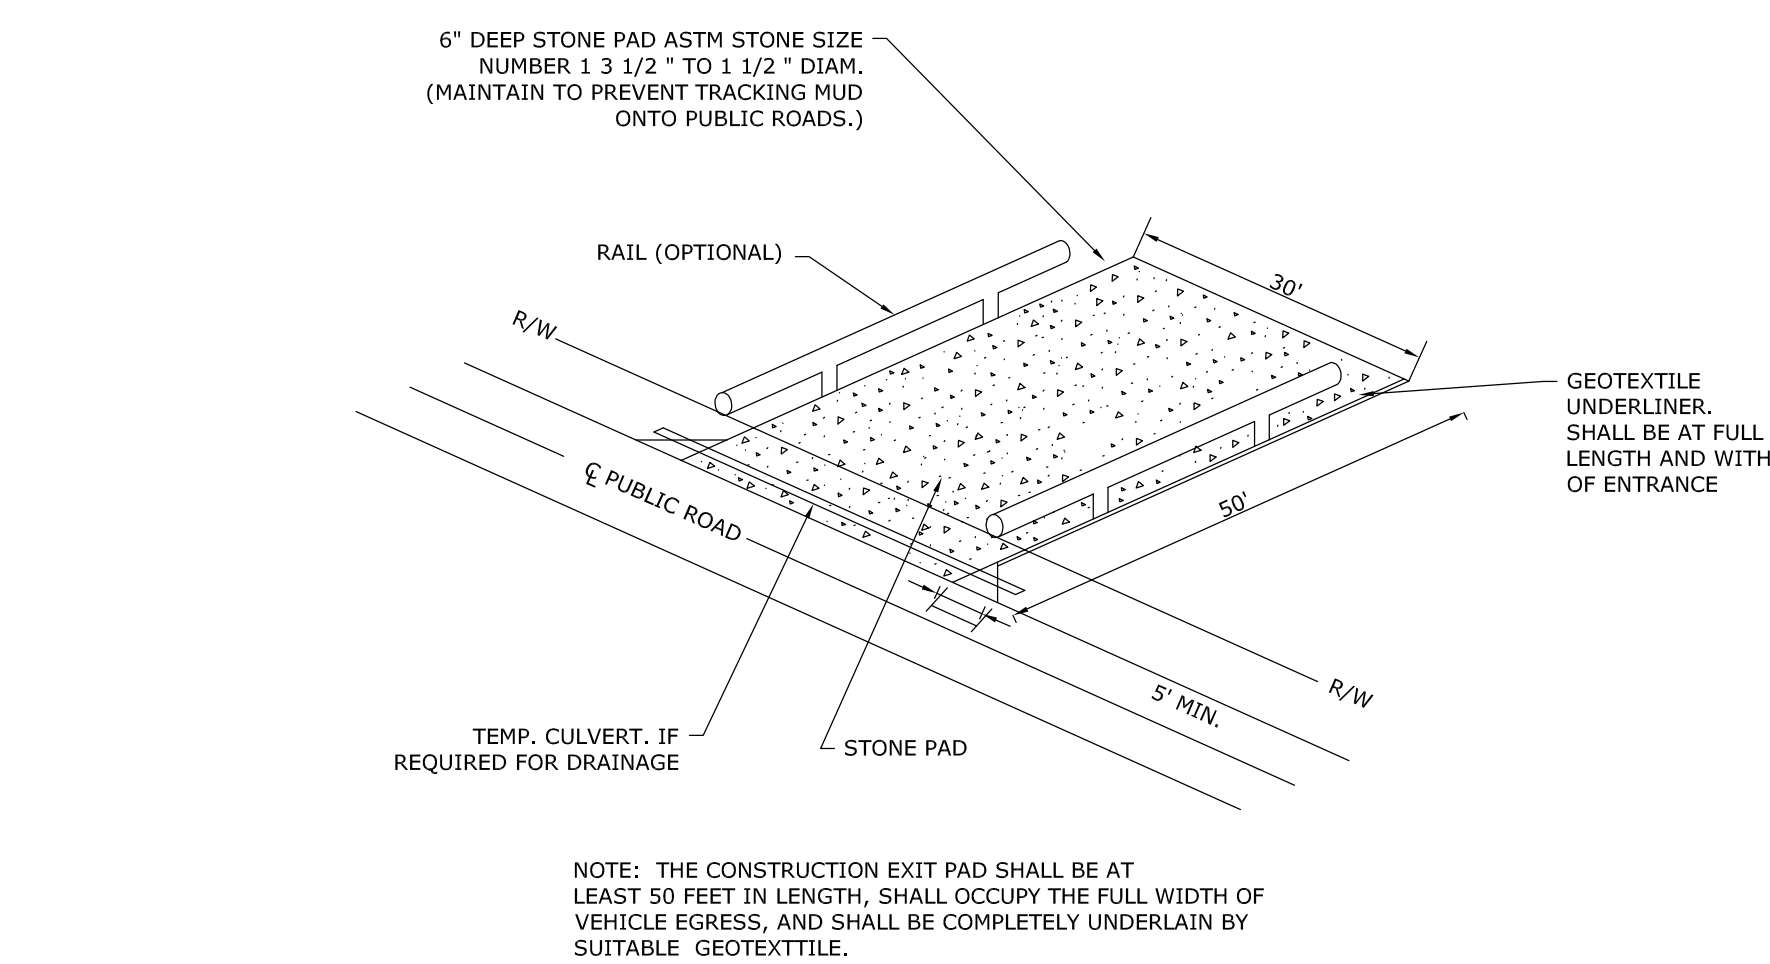



### CO TEMPORARY CONSTRUCTION ENTRANCE

NOT TO SCALE

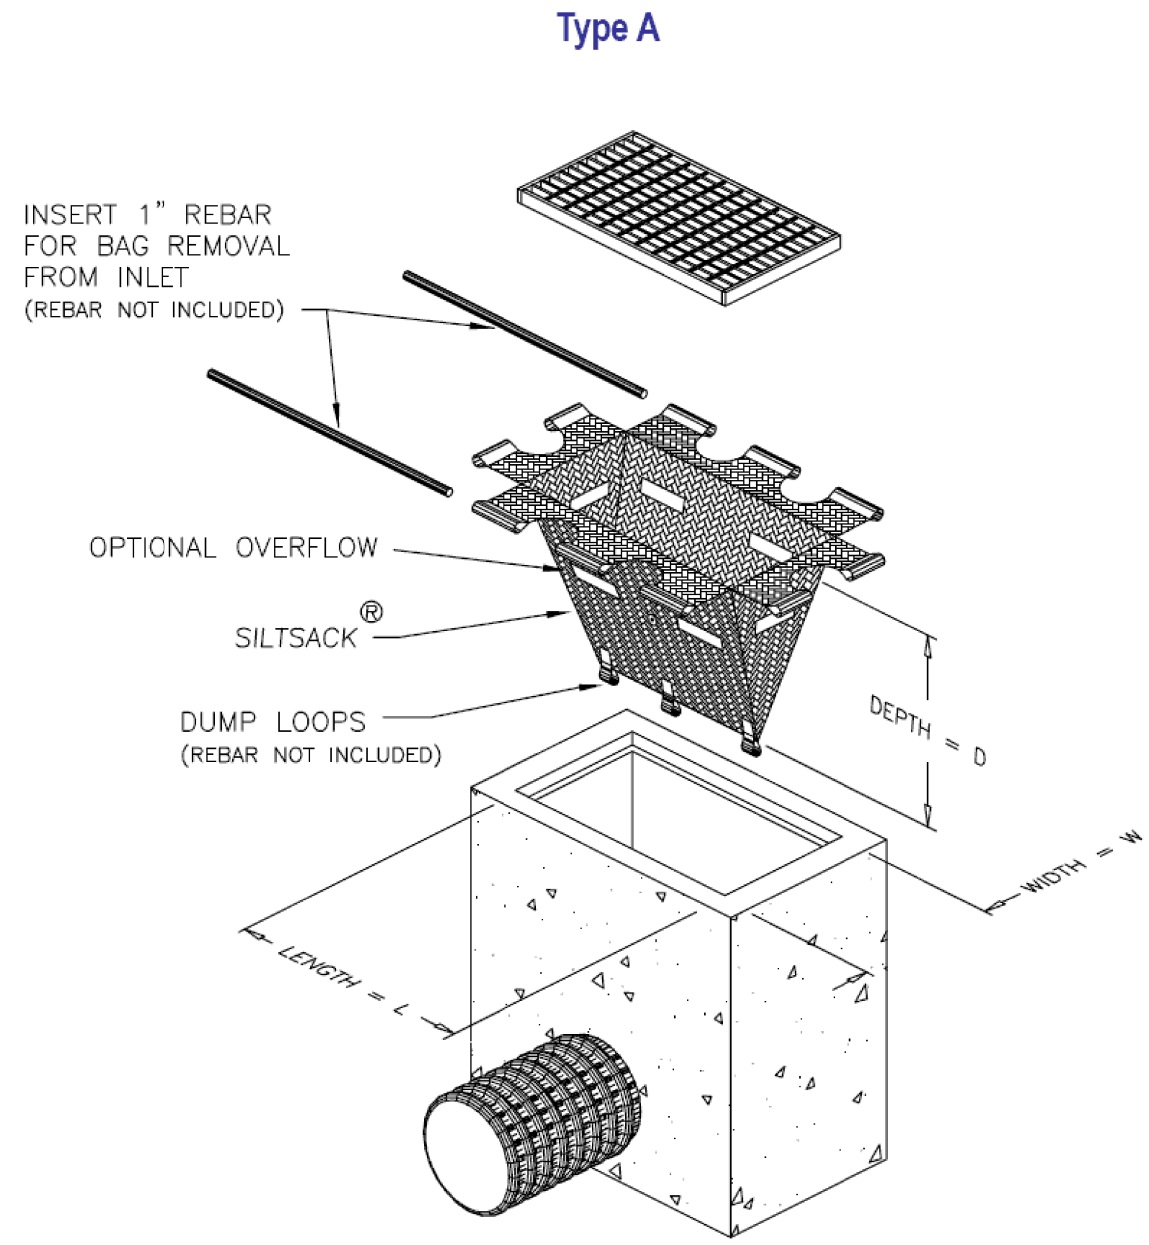

### SS SILT SACK

NOT TO SCALE

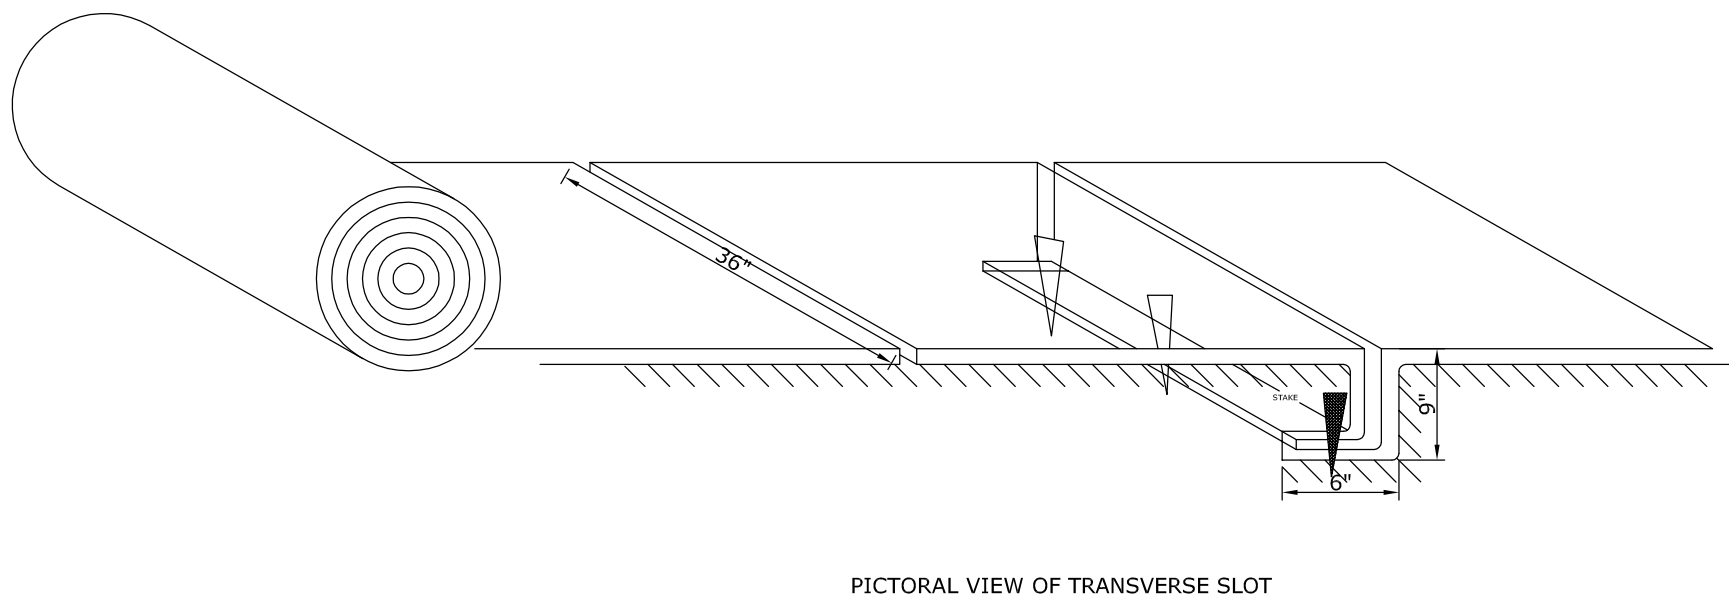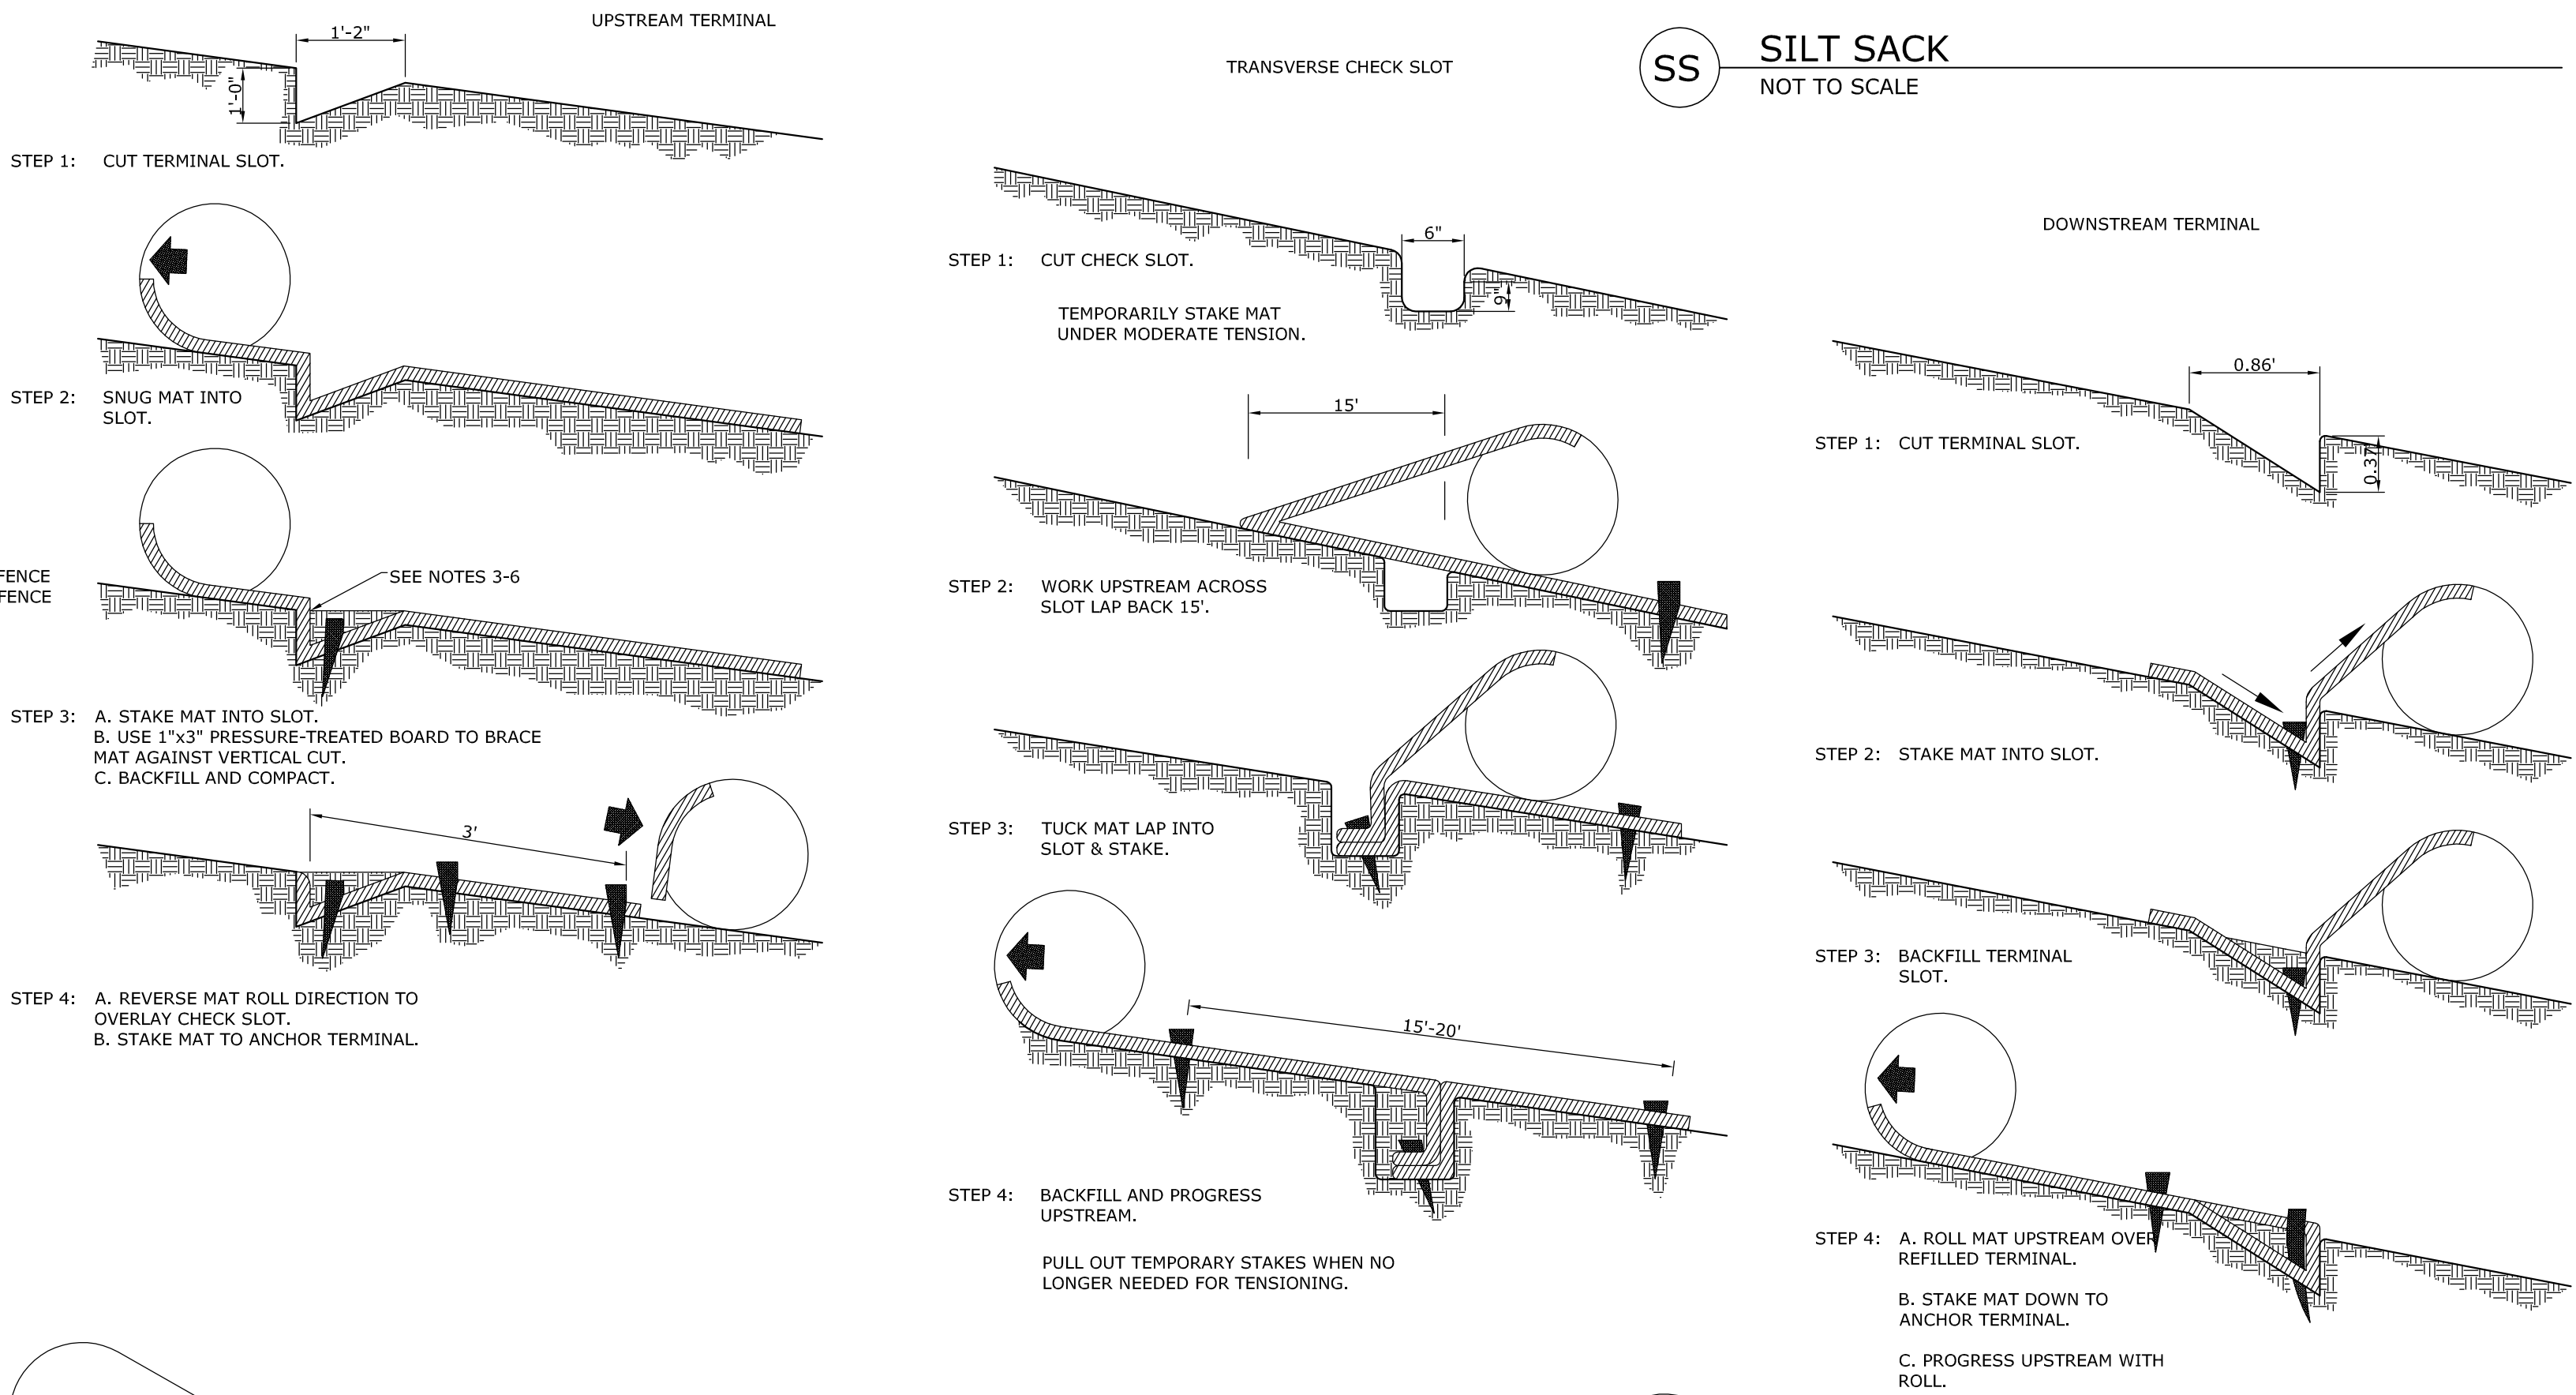

1. START AT DOWNSTREAM TERMINAL AND PROGRESS UPSTREAM.
2. FIRST ROLL IS CENTERED LONGITUDINALLY IN MID CHANNEL AND PINNED WITH TEMPORARY STAKES TO MAINTAIN ALIGNMENT.
3. SUBSEQUENT ROLLS FOLLOW IN STAGGERED SEQUENCE BEHIND FIRST ROLL. USE CENTER ROLL FOR ALIGNMENT TO CHANNEL CENTER.
4. WORK OUTWARDS FROM CHANNEL CENTER TO EDGE.
5. USE 3' OVERLAP AND STAKE AT 5' INTERVAL ALONG SEAMS.
6. USE 3' OVERLAPS AND SHINGLE DOWNSTREAM TO CONNECT LINING AT ROLL ENDS.

### RECP MATTING AND BLANKETS

NOT TO SCALE



### TS WINTER/EARLY SPRING

NOT TO SCALE

Seeding mixture

Species

Rate (lb/acre)

Rye (grain)

120

Seeding dates

Mountains—Aug. 15 - Dec. 15

Coastal Plain and Piedmont—Aug. 15 - Dec. 30

Soil amendments

Follow soil tests or apply 2,000 lb/acre ground agricultural limestone and 1,000 lb/acre 10-10-10 fertilizer.

Mulch

Apply 4,000 lb/acre straw. Anchor straw by tacking with asphalt, netting, or a mulch anchoring tool. A disk with blades set nearly straight can be used as a mulch anchoring tool.

Maintenance

Repair and refertilize damaged areas immediately. Topdress with 50 lb/acre of nitrogen in March. If it is necessary to extent temporary cover beyond June 15, overseed with 50 lb/acre Kobe (Piedmont and Coastal Plain) or Korean (Mountains) lespedeza in late February or early March.

### TS FALL

NOT TO SCALE

Seeding mixture

Species

Rate (lb/acre)

German millet

40

In the Piedmont and Mountains, a small-stemmed Sudangrass may be substituted at a rate of 50 lb/acre.

Seeding dates

Mountains—May 15 - Aug. 15

Piedmont—May 1 - Aug. 15

Coastal Plain—Apr. 15 - Aug. 15

Soil amendments

Follow recommendations of soil tests or apply 2,000 lb/acre ground agricultural limestone and 750 lb/acre 10-10-10 fertilizer.

Mulch

Apply 4,000 lb/acre straw. Anchor straw by tacking with asphalt, netting, or a mulch anchoring tool. A disk with blades set nearly straight can be used as a mulch anchoring tool.


Maintenance

Refertilize if growth is not fully adequate. Reseed, refertilize and mulch immediately following erosion or other damage.

### TS SUMMER

NOT TO SCALE


PROJECT:



ROCKY KNOB PARK  
EXPANSION

ADDRESS: 285 MOUNTAIN BIKE WAY | BOONE |  
WATAUGA COUNTY | NC | 28607

CLIENT:



WATAUGA CO. TDA

CONTACT: L. WRIGHT TILLEY, EXECUTIVE  
DIRECTOR

ADDRESS: 331 QUEEN STREET, SUITE 101 |  
BOONE | WATAUGA COUNTY | NC | 28607


CIVIL ENGINEER:



DESTINATION BY DESIGN ENGINEERING

ADDRESS: 136 FURMAN RD., STE. 6  
BOONE | NC | 28607

SEAL:

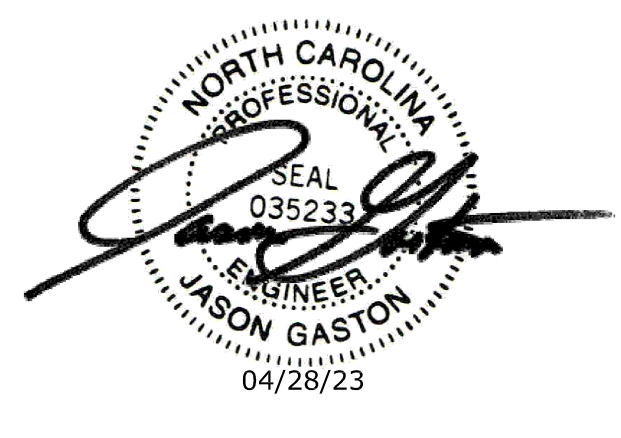

| REVISIONS | DATE |
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|------------------|----------------|
| PROJECT MANAGER: | CAG            |
| DRAWING BY:      | JEG            |
| JURISDICTION:    | WATAUGA COUNTY |
| DATE:            | 04/28/23       |
| SHEET TITLE:     |                |

### EROSION CONTROL DETAILS

|               |     |
|---------------|-----|
| SHEET NUMBER: | C-5 |
| SCALE:        | NTS |



Know what's below  
Call before you dig

### DC DUST CONTROL ON DISTURBED AREAS








\* VEHICLES IN EXCESS OF 75T MAY REQUIRE ADDITIONAL COVER

### RECOMMENDED MINIMUM TRENCH WIDTHS


NOTES:

1. ALL PIPE SYSTEMS SHALL BE INSTALLED IN ACCORDANCE WITH ASTM D2321, "STANDARD PRACTICE FOR UNDERGROUND INSTALLATION OF THERMOPLASTIC PIPE FOR SEWERS AND OTHER GRAVITY FLOW APPLICATIONS". LATEST ADDITION
2. MEASURES SHOULD BE TAKEN TO PREVENT MIGRATION OF NATIVE PINES INTO BACKFILL MATERIAL, WHEN REQUIRED. WHEN THE TRENCH IS DEEPER THAN 12" THE ENGINEER SHALL REQUIRE THE TRENCH TO BE LINED BY THE ENGINEER AND REPLACE WITH SUITABLE MATERIAL AS SPECIFIED BY THE ENGINEER, AS AN ALTERNATIVE AND AT THE DISCRETION OF THE DESIGN ENGINEER, THE TRENCH BOTTOM MAY BE STABILIZED USING A GEOTECHNICAL MATERIAL.
4. BEDDING: SUITABLE MATERIAL SHALL BE CLASS I, II OR III. THE CONTRACTOR SHALL PROVIDE DOCUMENTATION FOR MATERIAL TESTING. THE MINIMUM BEDDING THICKNESS SHALL BE 12" FOR 12" PIPE, MINIMUM BEDDING THICKNESS SHALL BE 10" FOR 14" TO 24" (100mm-600mm); 6" (150mm) FOR 30"-60" (750mm-900mm); 4" (100mm) FOR 60"-72" (1500mm-1800mm).
5. INITIAL BACKFILL: SUITABLE MATERIAL SHALL BE CLASS I, II OR III IN THE TOP 6" OF THE PIPE TRENCH EXTENDING NOT LESS THAN 6' ABOVE THE TOP OF THE PIPE. THE CONTRACTOR SHALL PROVIDE DOCUMENTATION FOR MATERIAL SPECIFICATION TO ENGINEER. MATERIAL SHALL BE INSTALLED AS REQUIRED IN ASTM D2321, LATEST EDITION.
6. MINIMUM COVER: MINIMUM COVER, H, IN NON-TRAFFIC APPLICATIONS (GRASS OR LANDSCAPE AREAS) IS 12" FROM THE TOP OF PIPE TO GROUND SURFACE. ADDITIONAL COVER MAY BE REQUIRED TO PREVENT FLOATION. FOR TRAFFIC APPLICATIONS, MINIMUM COVER SHALL BE 18" TO 48" (450mm TO 1200mm) FOR 12" TO 30" (300mm TO 750mm) DIAMETER PIPE, MEASURED FROM TOP OF PIPE TO BOTTOM OF FLEXIBLE PAVEMENT OR TO TOP OF RIGID PAVEMENT.


# 1 HDPE PIPE INSTALLATION

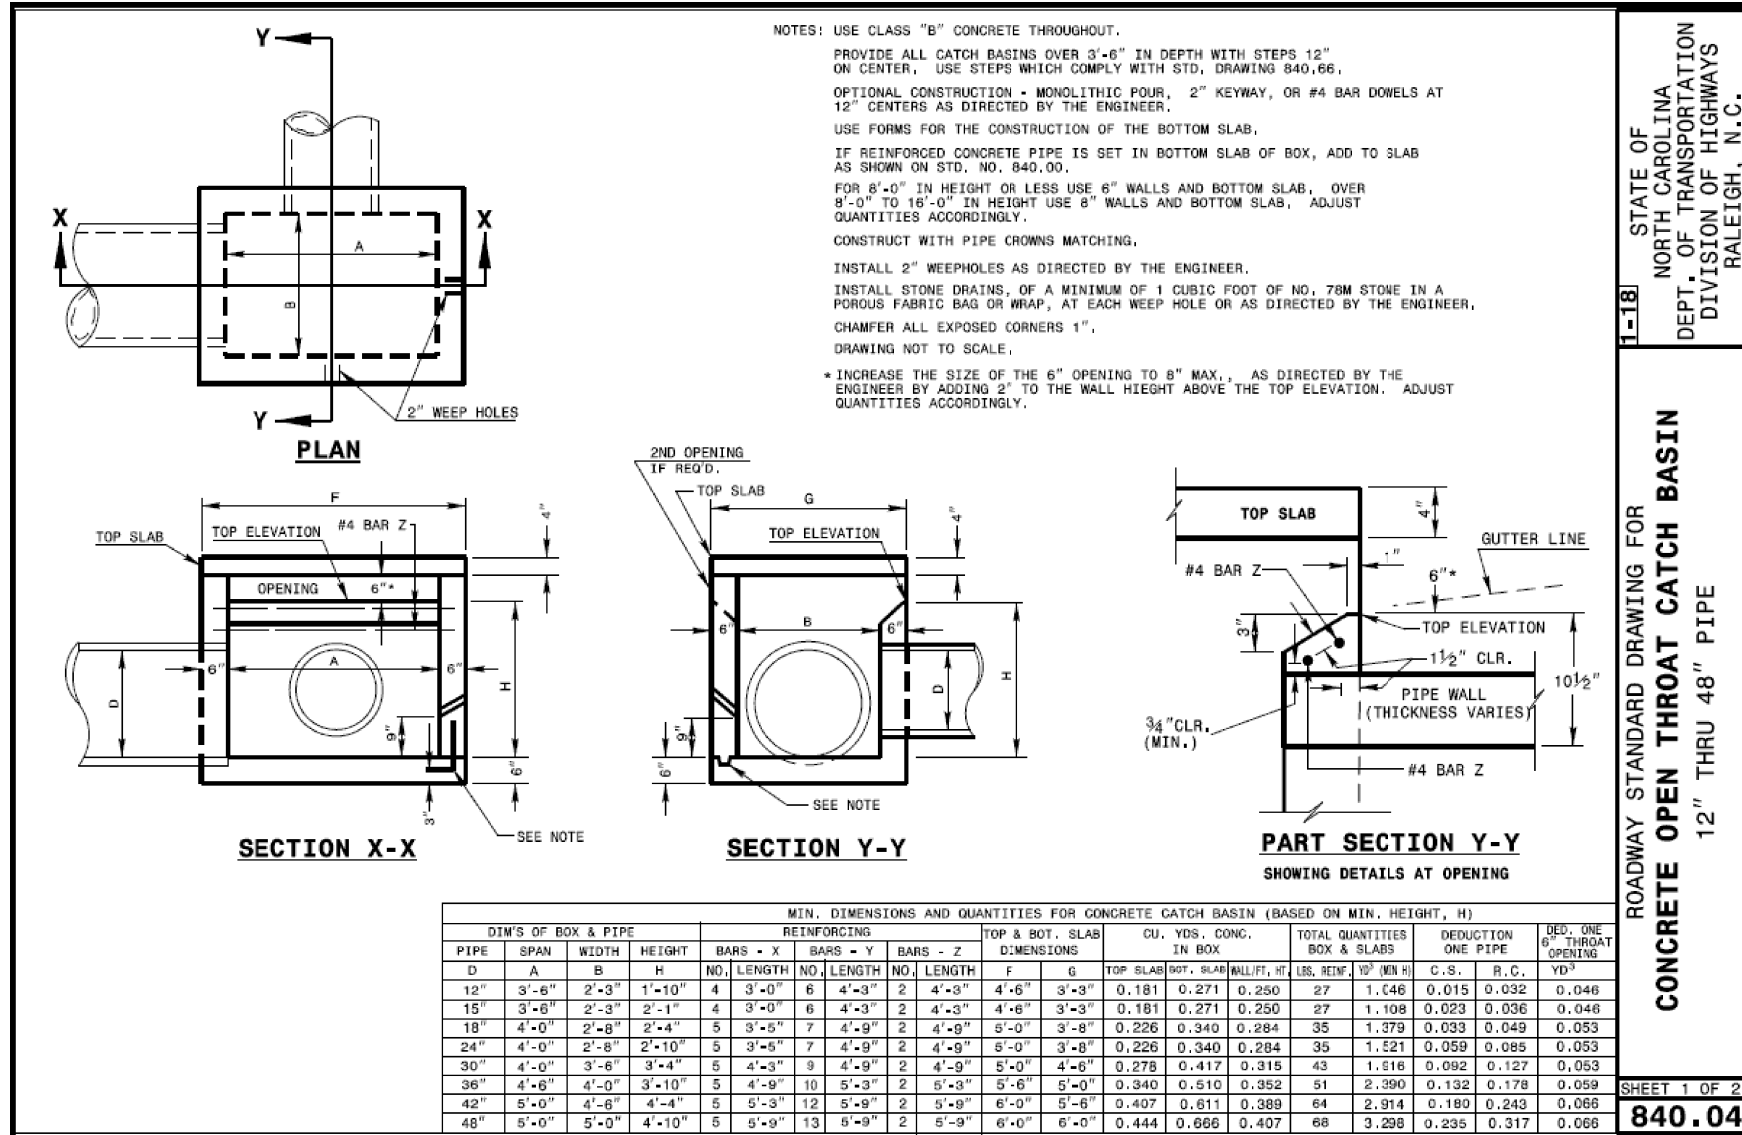


2 OPEN THROAT CATCH BASIN (NCDOT STD. 840.04)  
NOT TO SCALE

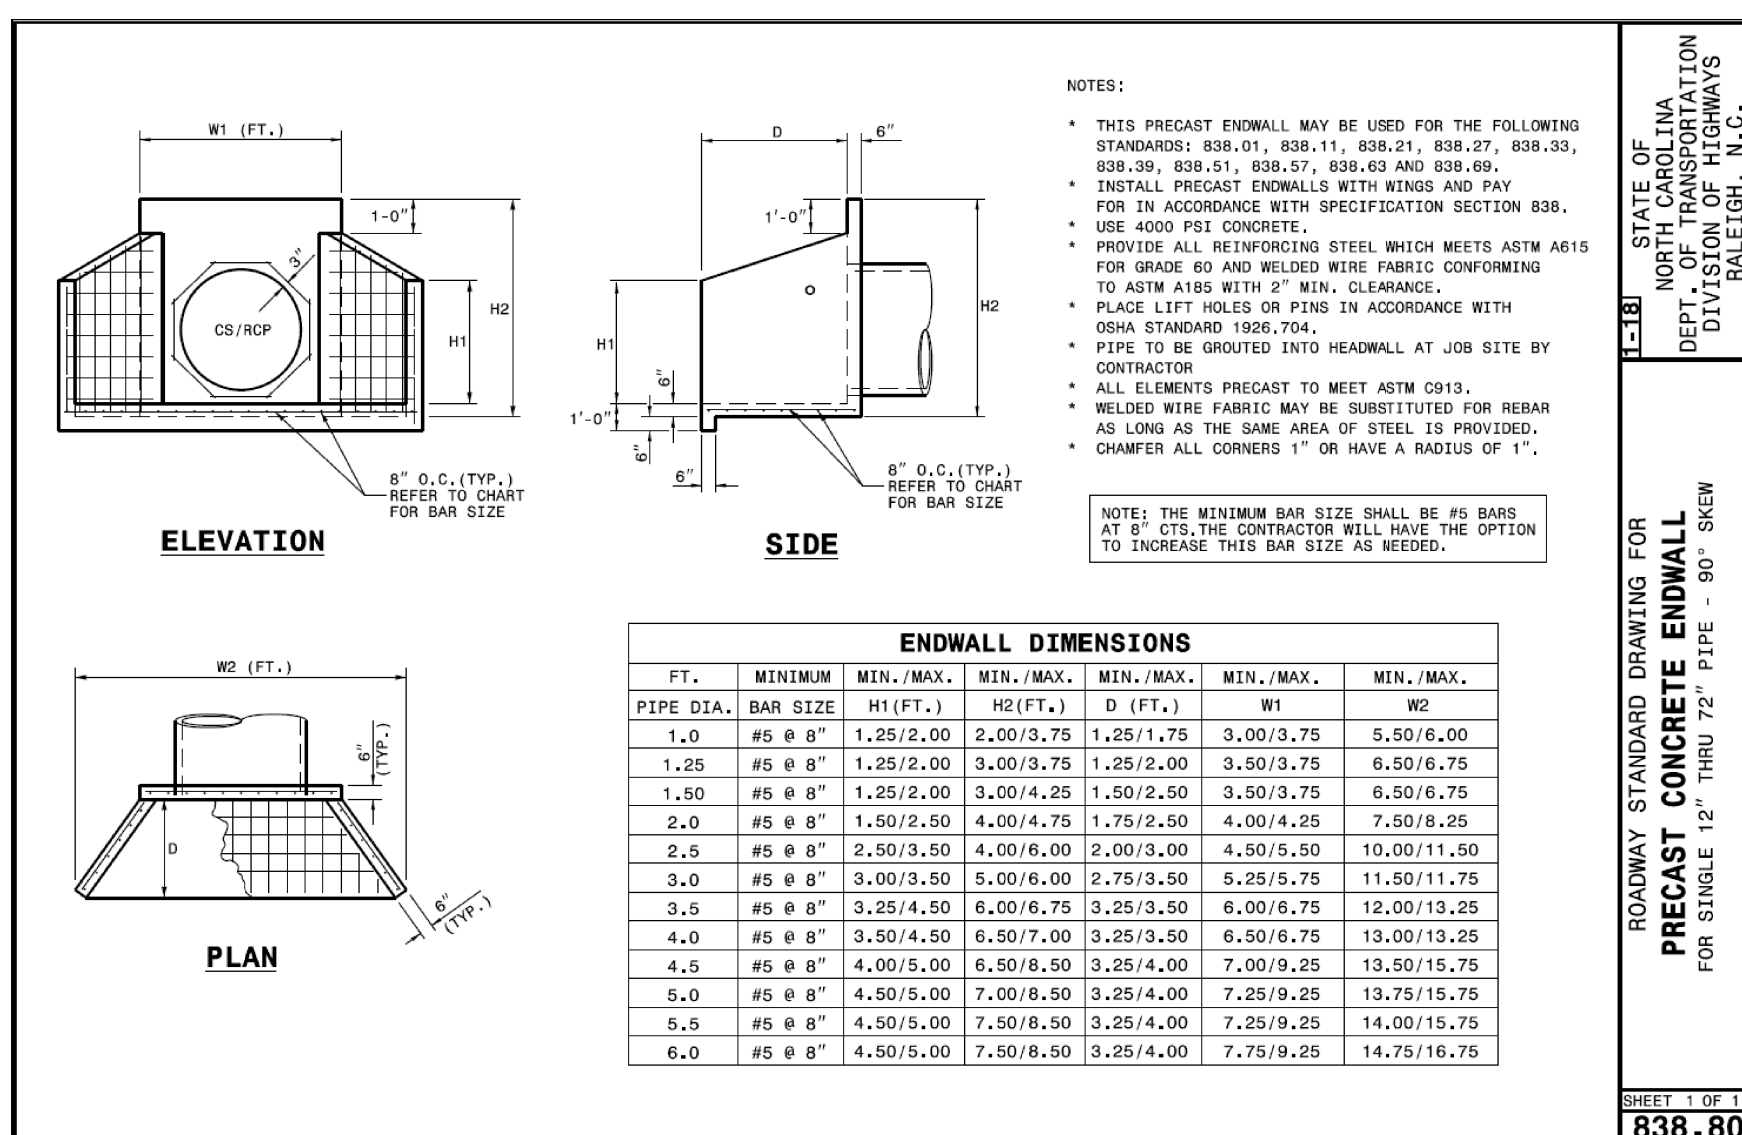

3 ENDWALL (NCDOT STD. 838.80)  
NOT TO SCALE

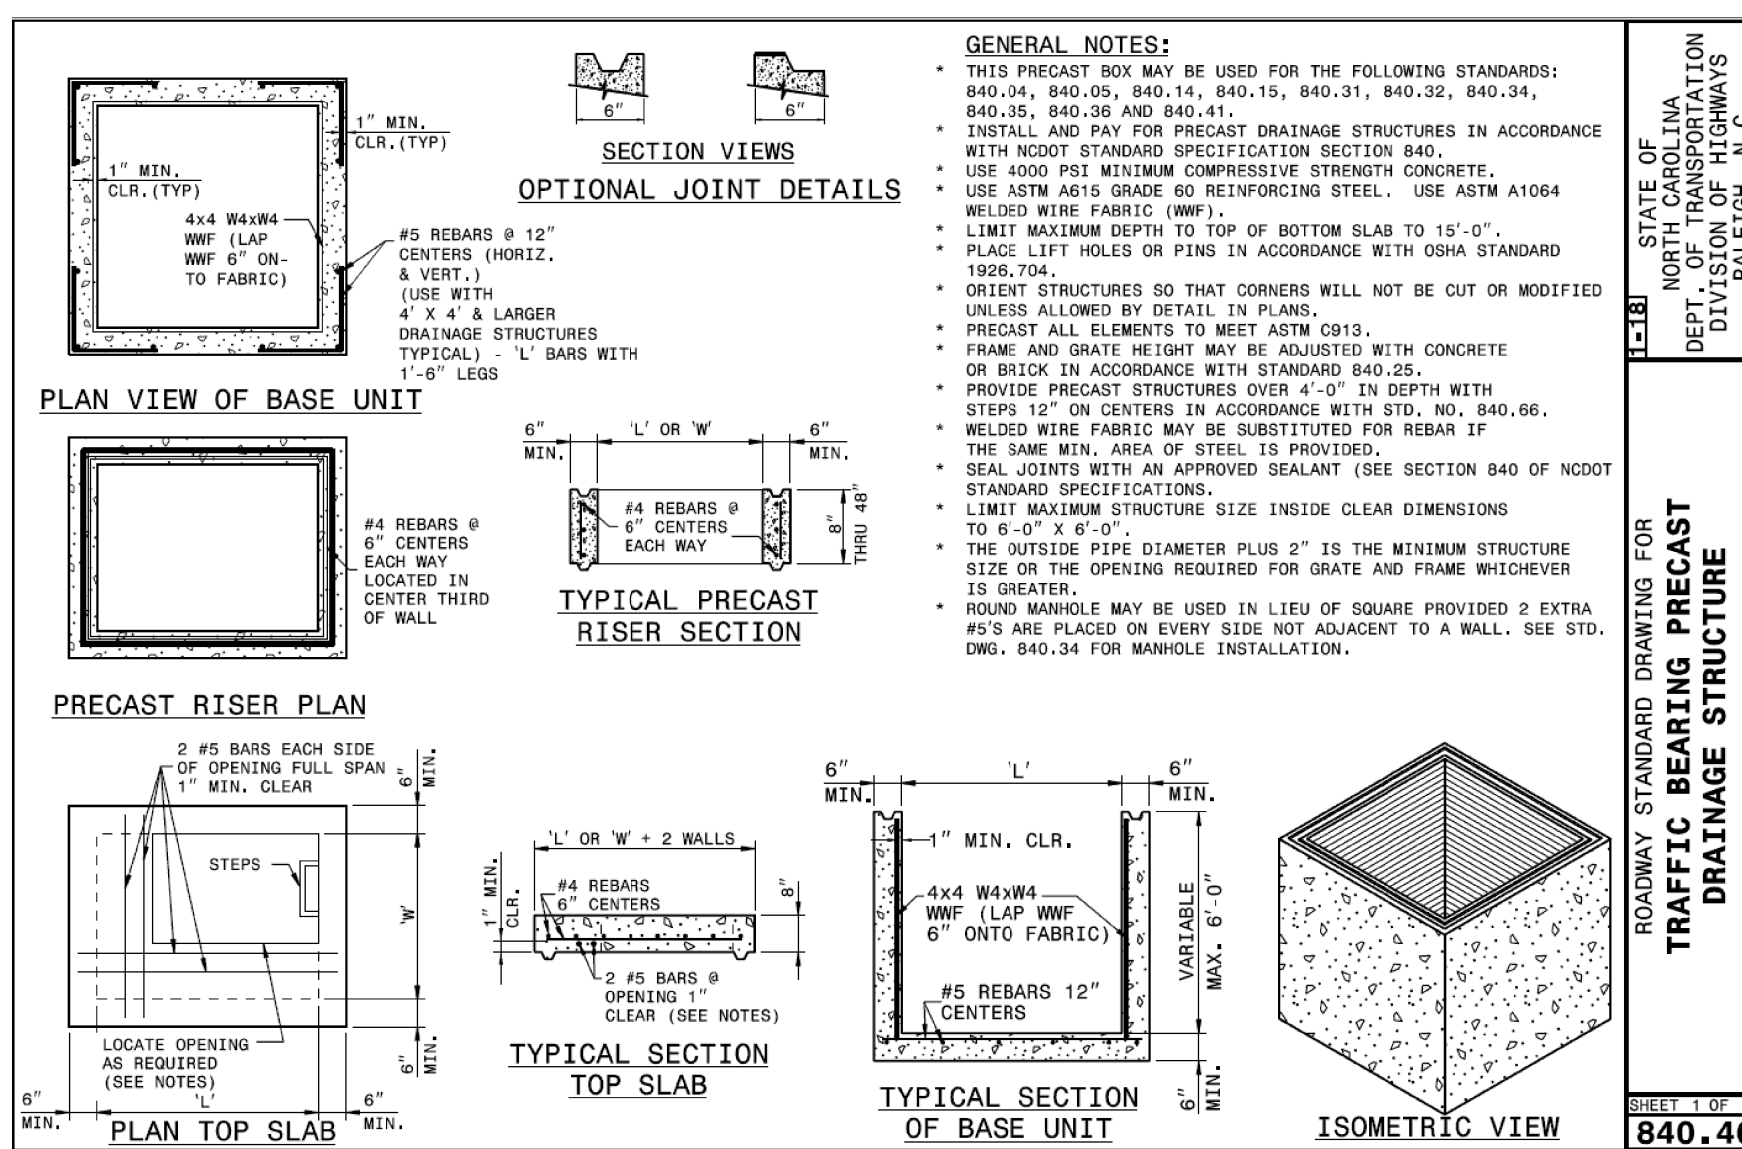

4 PRECAST DRAINAGE BOX (TRAFFIC BEARING)  
NOT TO SCALE

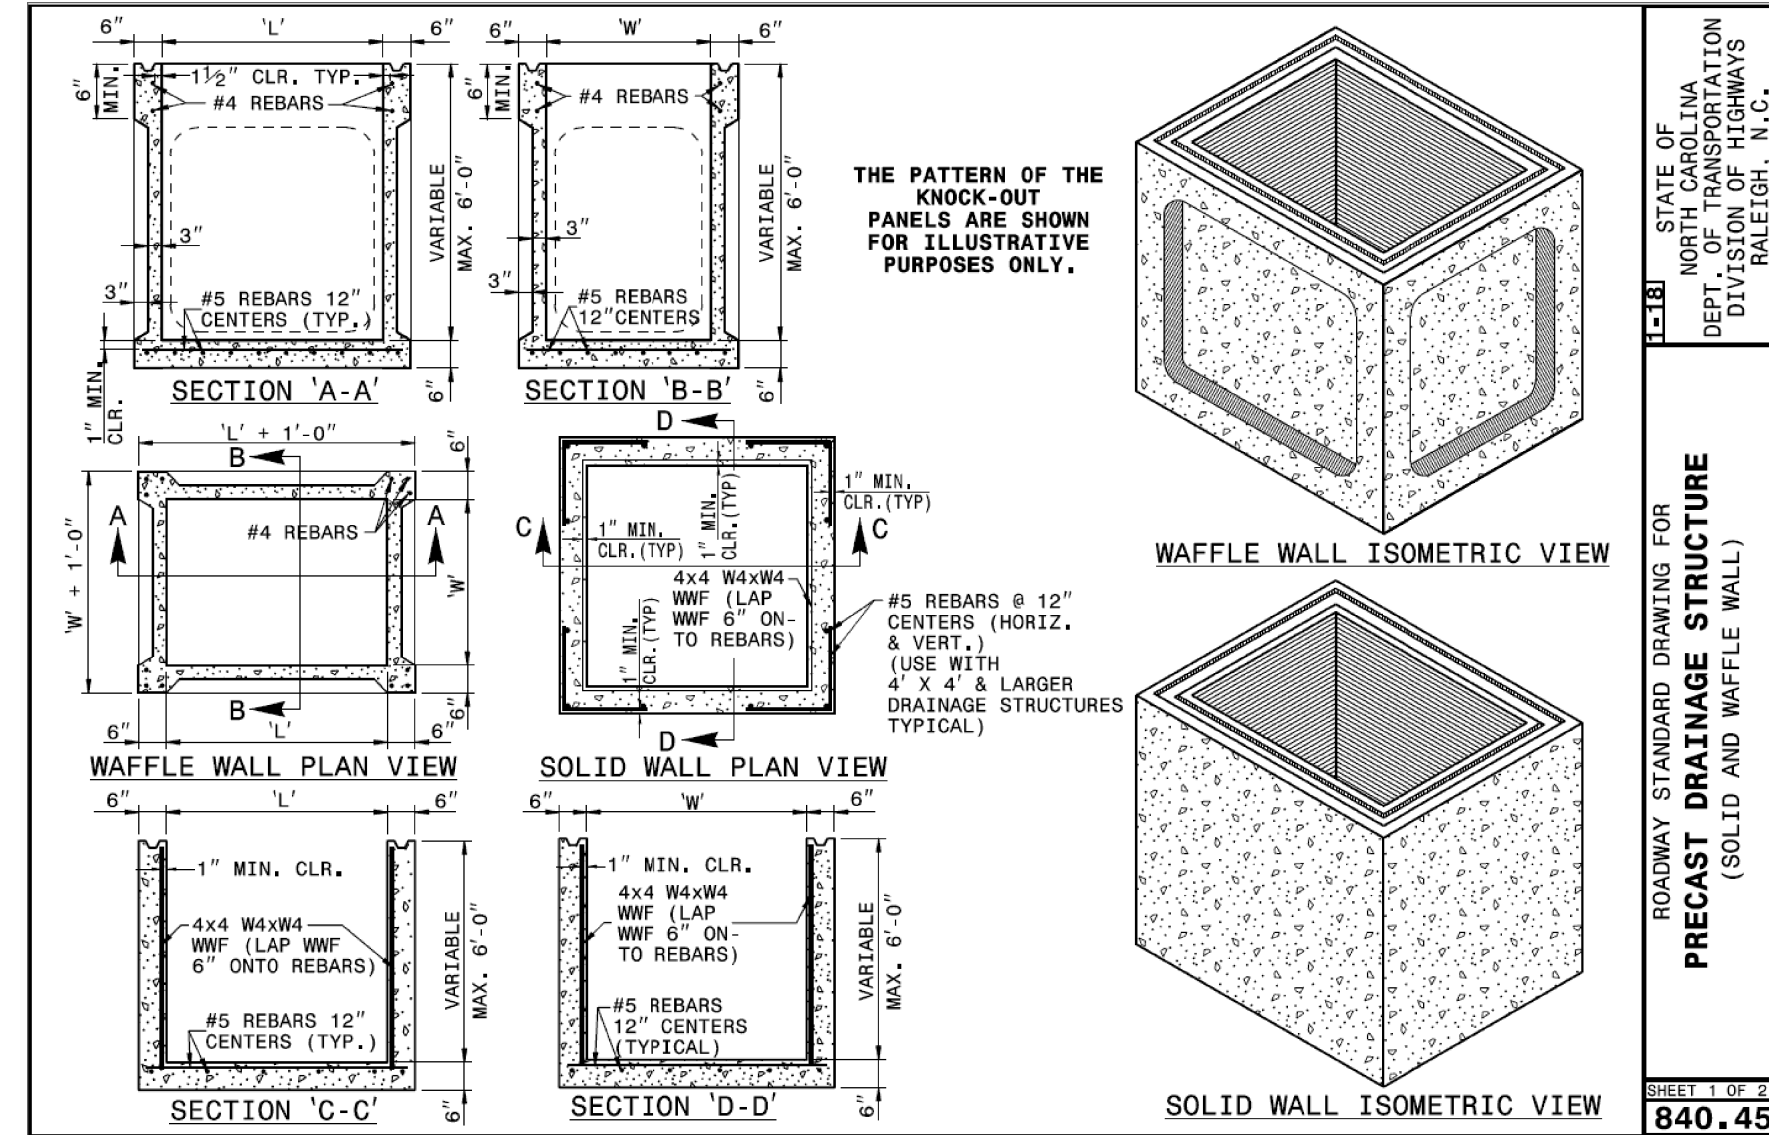

GENERAL NOTES:

- THIS PRECAST BOX MAY BE USED FOR THE FOLLOWING STANDARDS: 840.01, 840.02, 840.04, 840.05, 840.13, 840.14, 840.15, 840.17, 840.18, 840.19, 840.26, 840.27, 840.29, 840.30, 840.32 AND 840.33.
- INSTALL PRECAST DRAINAGE STRUCTURES AND PAVE FOR IN ACCORDANCE WITH SPECIFICATION SECTION 840.01, 840.02, PRECAST DRAINAGE STRUCTURES.
- UNDER TRAFFIC OR WHERE TRAFFIC WILL BE DETOURED, USE 4000 PSI CONCRETE.
- PROVIDE ALL REINFORCING STEEL WHICH MEETS ASTM A615 FOR CONCRETE AND WELDED WIRE FABRIC CONFORMING TO ASTM A104.
- LIMIT MAXIMUM DEPTH TO TOP OF BOTTOM SLAB FOR WAFFLE WALL STRUCTURE TO 10'-0". LIMIT SLOID WALL STRUCTURE TO 12'-0".
- PLACE LIFT HOLES OR PINS IN CONCRETE WITH OSHA STANDARD 1926.704.
- CUT OR FORM OPENINGS FOR PIPE TO PROVIDE UNOBSTRUCTED SIZE AND LOCATION. ORIENT WAFFLE WALL STRUCTURES SO THAT PIPES ENTER THROUGH THE KNOCKOUT/WAFFLE PANELS ONLY. PIPES MAY ENTER THROUGH THE CORNERS OF SLOID WALLS IF A MINIMUM OF 6" OF WALL IS PROVIDED ABOVE THE HOLE.
- ALL ELEMENTS PRECAST TO MEET ASTM C913.
- FINISH GRADE PRECAST HEIGHT MUST BE ADJUSTED WITH CONCRETE BRICK IN ACCORDANCE WITH SECTION 25.25.
- PROVIDE PRECAST STRUCTURES OVER 4'-0" IN DEPTH WITH STEPS AS DIRECTED BY THE ENGINEER.
- WHEN THE FABRIC IS USED FOR REINFORCED REBAR AS ALLOWED AS THE SAME AREA OF STEEL IS PROVIDED.
- SEAL JOINTS WITH A FLEXIBLE BUTYL RUBBER GASKET CONFORMING TO FEDERAL SPECIFICATION SS-S-21A, ASTM M-198, TYPE B BUTYL RUBBER.
- LIMIT MAXIMUM THICKNESS OF SLAB TO INCLUDE CLEAR DIMENSIONS OF 5'-0" X 5'-0".
- THE SIZE OF PIPE DURING CONSTRUCTION OR THE OPENING REQUIRED FOR FRAME AND GRISS IS THE MINIMUM STRUCTURE SIZE WHICHEVER IS GREATER.
- USE OF FRAME SHALL BE SHOWN AS INDICATED ON THE PLANS. REINFORCE OPENING AS SHOWN ON THIS SHEET.

5 PRECAST DRAINAGE BOX  
NOT TO SCALE


PROJECT:

BOONE NC

ROCKY KNOB PARK  
EXPANSION

ADDRESS: 285 MOUNTAIN BIKE WAY | BOONE |  
WATAUGA COUNTY | NC | 28607

CLIENT:

The seal of Watauga County, North Carolina, is circular. It features a central illustration of a river flowing through a valley with mountains in the background. The river is bordered by trees and flowers. The text "THE SEAL OF WATAUGA COUNTY" is written in a circle around the top, and "NORTH CAROLINA" is at the bottom. A small star is on the left side of the bottom arc.

**WATAUGA CO. TDA**

CONTACT: L. WRIGHT TILLEY, EXECUTIVE  
DIRECTOR

ADDRESS: 331 QUEEN STREET, SUITE 101 |  
BOONE | WATAUGA COUNTY | NC | 28607

**CIVIL ENGINEER:**

**DESTINATION  
BY DESIGN**

DESTINATION BY DESIGN ENGINEERING

**ADDRESS: 136 FURMAN RD., STE. 6  
BOONE | NC | 28607**

[illegible]

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|------------------|----------------|
| PROJECT MANAGER: | CAG            |
| DRAWING BY:      | JEG            |
| JURISDICTION:    | WATAUGA COUNTY |
| DATE:            | 04/28/23       |
| SHEET TITLE:     |                |

## DRAINAGE DETAILS

SHEET NUMBER: C-6

SCALE: NTS




LANDSCAPE NOTES:

GENERAL NOTES


- CONTRACTOR IS EXPECTED TO CARRY OUT ALL RESPONSIBILITIES SET FORTH IN THESE LANDSCAPE NOTES AND IN THE LANDSCAPE SPECIFICATIONS. THEY WILL BE STRICTLY ENFORCED BY THE OWNER/LANDSCAPE ARCHITECT.
- CONTRACTOR SHALL BE RESPONSIBLE TO RECEIVE THE LANDSCAPE ARCHITECT'S APPROVAL OF ALL PLANT BED LAYOUTS AND TREE LOCATIONS PRIOR TO INSTALLATION. IF PLANT MATERIAL IS INSTALLED PRIOR TO LANDSCAPE ARCHITECT'S APPROVAL, CONTRACTOR WILL BE SUBJECT TO RELOCATING THE MATERIAL AT THE LANDSCAPE ARCHITECT'S REQUEST AND THE CONTRACTOR'S OWN EXPENSE.
- SOIL TESTING SHALL BE PERFORMED IN AN ADEQUATE TIME FRAME TO RECEIVE RESULTS PRIOR TO SOIL AMENDMENT PROCESS BEGINNING.  
SOIL TEST SHALL:  
1) DETERMINE NUTRIENT STATUS AND PH OF SOIL.  
2) DETERMINE THE SOIL TEXTURE IN THE TOP 6" - 12" OF SOIL, AND THEN AMEND THE SOIL BASED ON THE RESULTS OF THE TESTS.
- LANDSCAPE CONTRACTOR SHALL ACCEPT FIELD CONDITIONS OF SITE AND PERFORM THE WORK SPECIFIED INCLUDING CONSTRUCTION DEBRIS REMOVAL, FINE GRADING, AND INCORPORATION OF SOIL AMENDMENTS, WITHOUT ADDITIONAL COMPENSATION FOR POSSIBLE VARIATION FROM GRADES AND CONDITIONS SHOWN, WHETHER SURFACE OR SUBSURFACE, EXCEPT AS APPROVED FOR IN CONTRACT DOCUMENTS.
- LANDSCAPE CONTRACTOR SHALL BE RESPONSIBLE FOR FINE GRADING. FINE GRADING INCLUDES THE REMOVAL OF ALL CONSTRUCTION DEBRIS, INCLUDING EXCESS GRAVEL LARGER THAN 1" DIAMETER, AND RAKING THE SURFACE SMOOTH. FINE GRADING SHALL BE SUBJECT TO THE APPROVAL OF THE LANDSCAPE ARCHITECT.
- CONTRACTOR SHALL BE RESPONSIBLE FOR THEIR OWN TAKE OFFS AND QUANTITIES. THIS INCLUDES SOO AND MULCH QUANTITIES OF WHICH THE CONTRACTOR SHALL BE HELD TO BID QUANTITIES. THE QUANTITIES ON THE PLANT LIST SERVE ONLY AS A GUIDE. LANDSCAPE PLANS DEPICTING PLANTS SHALL BE THE FINAL SOURCE FOR PLANT QUANTITIES. IF THERE IS A DISCREPANCY IN PLANT QUANTITY BETWEEN THE PLANS AND THE PLANT SCHEDULE THE LANDSCAPE ARCHITECT SHALL BE NOTIFIED.
- CONTRACTOR SHALL PROCURE ALL MATERIALS IMMEDIATELY AFTER CONTRACT ASSIGNMENT. PLANTS SHALL BE HELD DURING THE PERIOD FROM CONTRACT TO INSTALLATION TO ALLOW ADDITIONAL GROWTH. ALL PLANTS WILL BE REQUIRED TO BE FULL AND HEALTHY. CONTRACTOR SHALL ARRANGE FOR PLANT APPROVAL PRIOR TO DELIVERY, EITHER BY SAMPLES, PHOTOS, OR NURSERY VISITS.
- CONTRACTOR SHALL BE RESPONSIBLE FOR PLANT HEALTH IN ON-SITE SOILS. IF, DURING DIGGING, CONTRACTOR DISCOVERS WATER-LOGGED, CLAYEY, COMPACTED OR SIMILARLY POORLY DRAINED SOILS, OR OTHER POOR CONDITIONS, IT SHOULD BE BROUGHT TO THE ATTENTION OF OWNER/LANDSCAPE ARCHITECT FOR REMEDIAL ACTION.
- LANDSCAPE MATERIAL IS TO BE MAINTAINED BY THE LANDSCAPE CONTRACTOR (INCLUDING, BUT NOT LIMITED TO, WATERING, MOWING, PRUNING, AND WEEDING) UNTIL PROJECT HAS ENTERED SUBSTANTIAL COMPLETION.
- THE LANDSCAPE CONTRACTOR MUST PROVIDE A WARRANTY ON ALL PLANT MATERIAL FOR A PERIOD OF (1) ONE YEAR FROM PROJECT SUBSTANTIAL COMPLETION.
- CONTRACTOR SHALL LOCATE ALL UNDERGROUND UTILITIES PRIOR TO BEGINNING AND SHALL BE RESPONSIBLE FOR THE PROTECTION OF THESE UTILITIES DURING INSTALLATION, AND SHALL PROMPTLY REPAIR AND RESTORE AT NO ADDITIONAL COST TOT HE OWNER IF DAMAGE OCCURS DURING INSTALLATION. CONTRACTOR SHALL BECOME THOROUGHLY FAMILIAR WITH THE FULL SET OF CONSTRUCTION DRAWINGS AND SPECIFICATIONS FOR COORDINATION WITH UTILITIES, ARCHITECTURE, FEATURES, ETC.
- ALL UNPAVED DISTURBED SURFACES ARE TO BE COVERED IN PLANTS, MULCH, OR GRASS.

PLANTING NOTES

- CONTRACTOR SHALL BE RESPONSIBLE FOR THEIR OWN PLANT MATERIAL TAKE OFFS AND QUANTITIES. THE QUANTITIES ON THE PLANT SCHEDULE SERVE ONLY AS A GUIDE. LANDSCAPE PLANS DEPICTING PLANTS SHALL BE THE FINAL SOURCE FOR PLANT QUANTITIES. IF THERE IS A DISCREPANCY IN PLANT QUANTITY BETWEEN THE PLANS AND THE PLANT SCHEDULE THE LANDSCAPE ARCHITECT SHALL BE NOTIFIED.
- ALL PLANT MATERIAL SHALL MEET OR EXCEED THE AMERICAN STANDARD FOR NURSERY STOCK.
- ALL PLANT MATERIAL SHALL MEET OR EXCEED MINIMUM SIZE AND SPACING SPECIFICATIONS NOTES ON THE PLANT SCHEDULE. CONTAINER SIZE NOTED ON THE PLANT SCHEDULE SERVE AS A GUIDE ONLY. ANY MATERIAL NOT MEETING SPECIFICATIONS SHALL BE REMOVED AND REPLACED AT THE CONTRACTOR'S EXPENSE.
- IN THE EVENT, AFTER EXHAUSTING ALL RESOURCES, CONTRACTOR IS UNABLE TO PROCURE PLANT MATERIAL QUANTITIES SPECIFIED A SUBSTITUTION MAY BE EVALUATED. CONTRACTOR IS TO NOTIFY LANDSCAPE ARCHITECT AND PROVIDE SUBSTITUTIONS THAT ARE CURRENTLY COMMERCIALY AVAILABLE.
- PLANT BED DEFINED - AN AREA THAT PLANT MATERIAL SHALL BE INSTALLED, INCLUDING PARKING LOT ISLANDS. THE ENTIRE PARKING LOT ISLAND IS CONSIDERED A PLANT BED, NOT JUST THE AREA WHERE A SINGLE TREE MAY BE PLANTED.
- CONTRACTOR SHALL ASSUME ALL PLANT BEDS WILL BE COMPACTED FROM THE CONSTRUCTION PROCESS AND WILL NEED TO BE RIPPED, TILLED OR OTHER MEANS OF MECHANICAL CULTIVATION TO BREAK UP COMPACTED SOILS TO A DEPTH OF 18 INCHES.
- CONTRACTOR SHALL BE RESPONSIBLE FOR AMENDING SOIL PER SOIL TEST RESULTS.
- CONTRACTOR SHALL INCORPORATE 1 CUBIC YARD OF COMPOST PER 100 SQUARE FEET OF PLANT BED. COMPOST SHALL BE INCORPORATED INTO THE TOP 8 INCHES OF SOIL. COMPOST SHALL BE CERTIFIED BY THE US COMPOSTING COUNCIL'S SEAL OF TESTING ASSURANCE PROGRAM AND OMRI LISTED.
- CONTRACTOR SHALL BE RESPONSIBLE FOR FINE GRADING ALL PLANT BEDS. FINE GRADING SHALL INCLUDE REMOVING ALL CONSTRUCTION DEBRIS INCLUDING EXCESS GRAVEL 1" DIAMETER AND LARGER AND THEN RAKING THE SURFACE SMOOTH TO ALLOW FOR POSITIVE DRAINAGE AWAY FROM STRUCTURES AND DIRECTED TOWARDS ANY STORM DRAIN INLETS THAT MAY BE PRESENT.
- PLANT MATERIAL SHALL BE INSTALLED PER PROVIDED PLANTING DETAILS AND NOTES.
- PLANT MATERIAL SHALL BE INSTALLED VERTICALLY / PLUMB REGARDLESS OF GROUND SLOPE.
- 3" OF TRIPLE SHREDDED HARDWOOD MULCH SHALL BE INSTALLED ON ALL PLANT BEDS. MULCH SHALL BE NATURAL IN COLOR. PLANT BEDS SHALL BE FREE OF WEEDS PRIOR TO PLACING OF MULCH. MULCH SHALL NOT BE MOUNDED AS TO FORM A "MULCH VOLCANO" AGAINST THE STEM OF ANY PLANT MATERIAL. MULCH SHALL NOT BE IN CONTACT WITH THE STEM OF ANY PLANT MATERIAL.
- PLANT BEDS EDGES SHALL BE INSTALLED TO RETAIN MULCH AND KEEP IT FROM WASHING. BED EDGES ALONG HARDSCAPE SHALL HAVE A TURN DOWN EDGE SO MULCH SHALL NOT WASH OVER THE HARDSCAPE EDGE. WHERE PLANT BEDS ABUT LAWN AREA AN EDGE MUST BE PREPARED MECHANICALLY WITH A BED EDGING MACHINE TO ENSURE MULCH REMAINS IN PLACE AND DOES NOT WASH.
- AFTER MULCH IS PLACED ALL PLANT BEDS SHALL RECEIVE A PRE-EMERGENT HERBICIDE APPLICATION. CONTRACTOR TO ENSURE PRE-EMERGENT HERBICIDE IS SUITABLE FOR PLANT MATERIAL AND TO FOLLOW APPLICATION INSTRUCTIONS LISTED ON THE LABEL.
- TREES LOCATED IN GRASS AREAS SHALL RECEIVE A (6) SIX FEET DIAMETER MULCH RING.

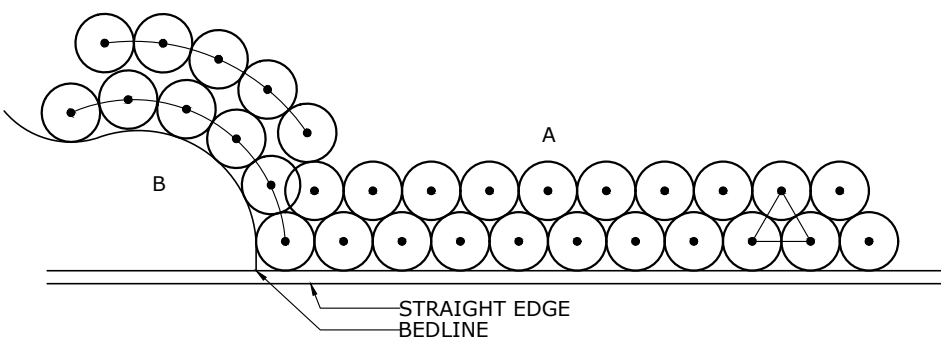

- A. SHRUBS AND GROUNDCOVER ADJACENT TO STRAIGHT EDGES SHALL BE TRIANGULAR - SPACED IN ROWS PARALLEL TO STRAIGHT EDGE.
- B. SHRUBS AND GROUNDCOVER ADJACENT TO CURVED EDGES SHALL BE PLANTED IN ROWS PARALLEL TO THE CURVED EDGE. CURVED EDGES TO BE SMOOTH RADII

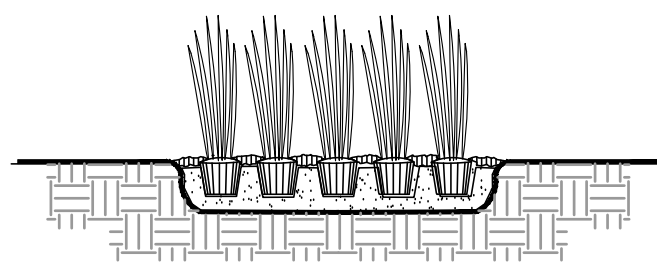


12" MINIMUM DEPTH OF AMENDED SOIL MIX TO BE INCORPORATED IN GROUNDCOVER PLANTING BEDS. PROVIDE APPROPRIATE TIME-RELEASE FERTILIZER PER MANUFACTURER'S RECOMMENDATIONS.

3 L-1 TYPICAL PLANT SPACING LAYOUT


| PLANT SCHEDULE            |                            |      |  |                              |        |         |       |                              |
|---------------------------|----------------------------|------|--|------------------------------|--------|---------|-------|------------------------------|
| SPECIES MIXING            | KEY                        | QTY. | BOTANICAL NAME                               | COMMON NAME                  | CA*    | HT*     | ROOT  | REMARKS                      |
| TOTAL NUMBER OF TREES 4   | AA                         | 2    | <i>Amelanchier arborea</i>                   | Serviceberry                 | -      | 6'-8'   | -     | Full, Match                  |
|                           | NS                         | 3    | <i>Nyssa sylvatica</i>                       | Black Tupelo                 | 2"     | 10'-12' | -     | Full, Match, Straight leader |
|                           | QS                         | 2    | <i>Quercus shumard</i>                       | Shumard Oak                  | 3"     | 12'-14' | -     | Full, Match, Straight leader |
|                           | SHRUBS / GRASSES/PERNNIALS |      |  |                              |        |         |       |                              |
| TOTAL NUMBER OF SHRUBS 78 | AT                         | 39   | <i>Andropogon ternarius</i> 'Black Mountain' | Black Mountain Bluestem      | 3 gal. | -       | Cont. | Full, Match                  |
|                           | HQ                         | 5    | <i>Hydrngea quercifolia</i> 'Snow Queen'     | Snow Queen Oakleaf Hydrangea | 3 gal. | 15"     | Cont. | Full, Match                  |
|                           | IG                         | 12   | <i>Ilex glabra</i> 'Shamrock'                | Shamrock Inkberry Holly      | 3 gal. | 15"     | Cont. | Full, Match                  |
|                           | IV                         | 16   | <i>Itea virginica</i>                        | Virginia Sweetspire          | 3 gal. | 15"     | Cont. | Full, Match                  |
|                           | RH                         | 6    | <i>Rhododendron</i> spp. 'PJM'               | PJM Rhododendron             | 3 gal. | 15"     | Cont. | Full, Match                  |
|                           |                            |      |  |                              |        |         |       |                              |

\*CA. AND HT. REFERS TO SIZE OF PLANT MATERIAL AT TIME OF INSTALLATION.

\*HT. TAKES PRECEDENT OVER CONTAINER SIZE. PLANTS MUST MEET SPECIFIED HT.

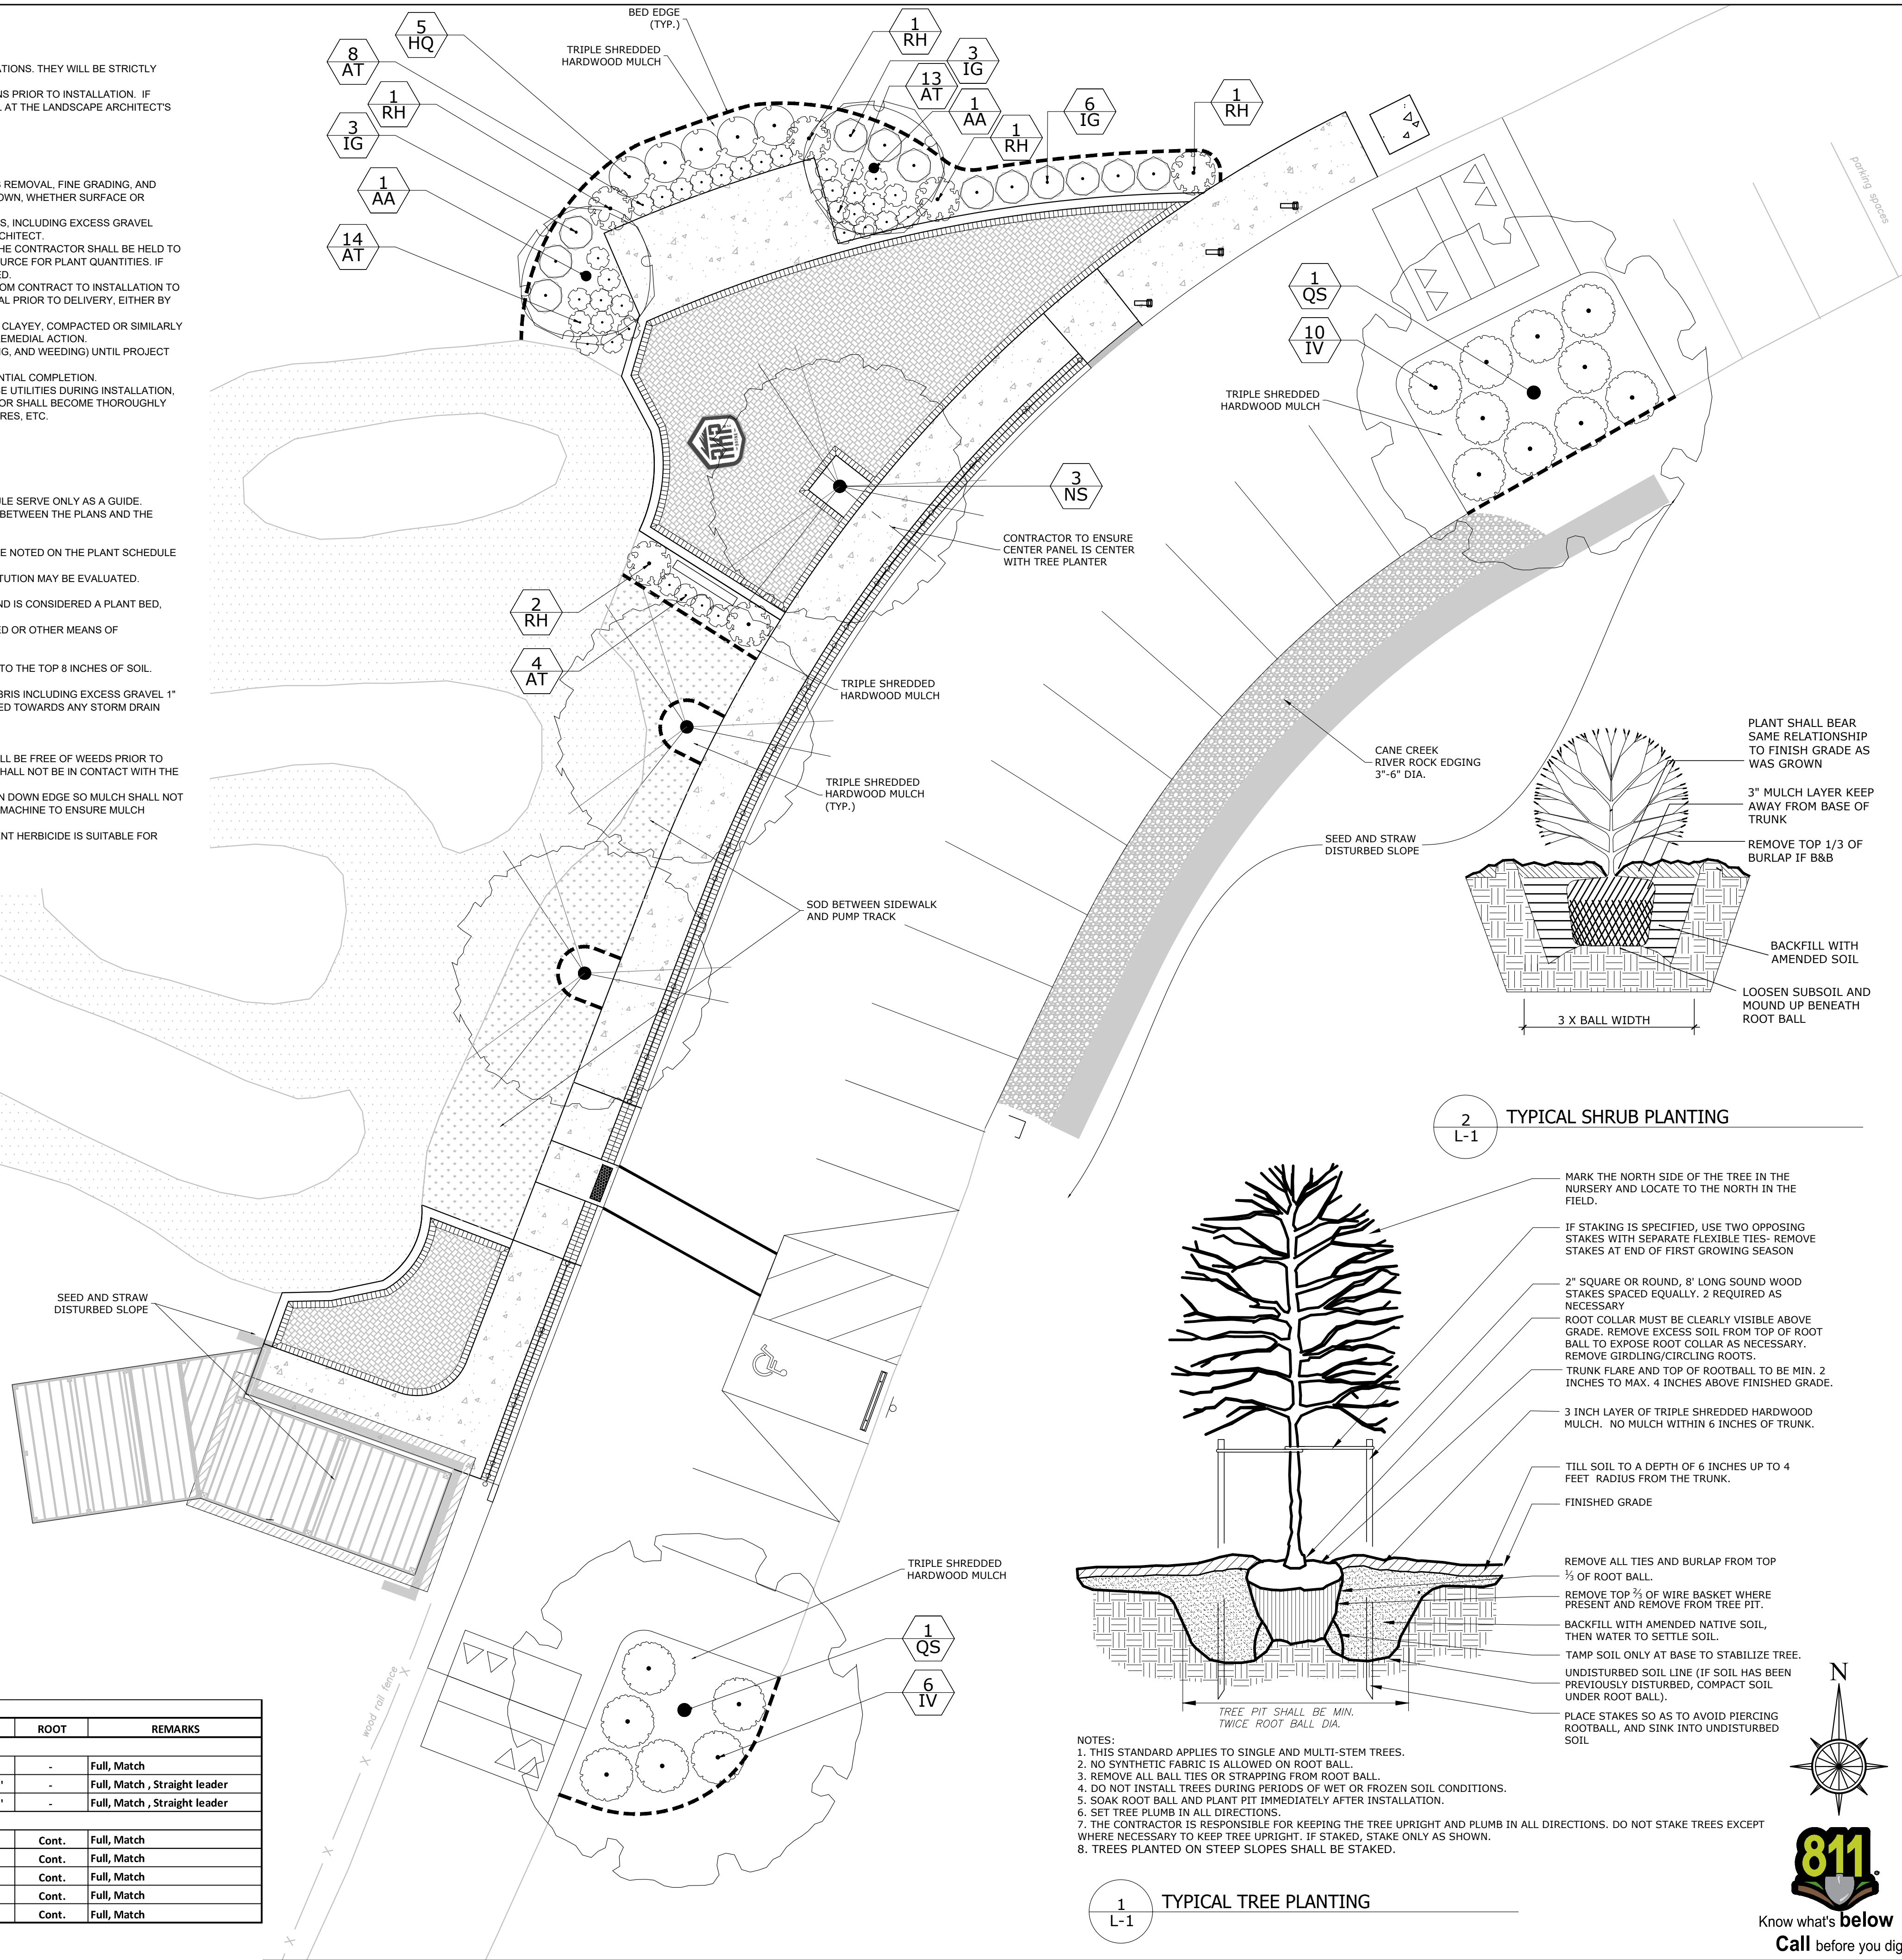

2 L-1 TYPICAL SHRUB PLANTING

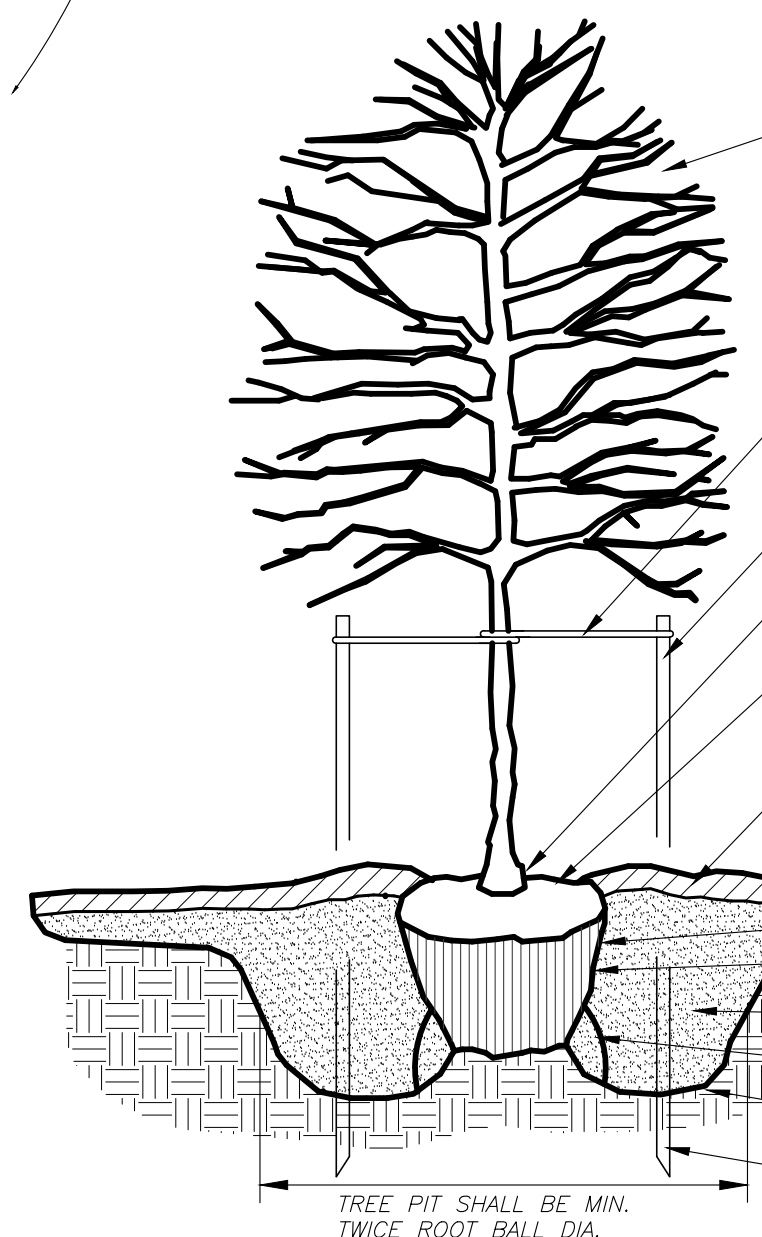

- NOTES:
- THIS STANDARD APPLIES TO SINGLE AND MULTI-STEM TREES.
  - NO SYNTHETIC FABRIC IS ALLOWED ON ROOT BALL.
  - REMOVE ALL BALL TIES OR STRAPPING FROM ROOT BALL.
  - DO NOT INSTALL TREES DURING PERIODS OF WET OR FROZEN SOIL CONDITIONS.
  - SOAK ROOT BALL AND PLANT PIT IMMEDIATELY AFTER INSTALLATION.
  - SET TREE PLUMB IN ALL DIRECTIONS.
  - THE CONTRACTOR IS RESPONSIBLE FOR KEEPING THE TREE UPRIGHT AND PLUMB IN ALL DIRECTIONS. DO NOT STAKE TREES EXCEPT WHERE NECESSARY TO KEEP TREE UPRIGHT. IF STAKED, STAKE ONLY AS SHOWN.
  - TREES PLANTED ON STEEP SLOPES SHALL BE STAKED.

1 L-1 TYPICAL TREE PLANTING

PROJECT:



ROCKY KNOB PARK  
EXPANSION

ADDRESS: 285 MOUNTAIN BIKE WAY | BOONE | WATAUGA COUNTY | NC | 28607

CLIENT:



WATAUGA CO. TDA

CONTACT: L. WRIGHT TILLEY, EXECUTIVE DIRECTOR

ADDRESS: 331 QUEEN STREET, SUITE 101 | BOONE | WATAUGA COUNTY | NC | 28607

LANDSCAPE ARCHITECT:



ADDRESS: 136 FURMAN ROAD, SUITE 6 | BOONE | WATAUGA COUNTY | NC | 28607

SEAL:



09/01/23

REVISIONS

DATE

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PROJECT MANAGER:

CAG

DRAWING BY:

ED

JURISDICTION:

WATAUGA COUNTY

DATE:

09.01.2023

SHEET TITLE:

LANDSCAPE PLAN

SHEET NUMBER:


L-1

SCALE:

1" = 10'





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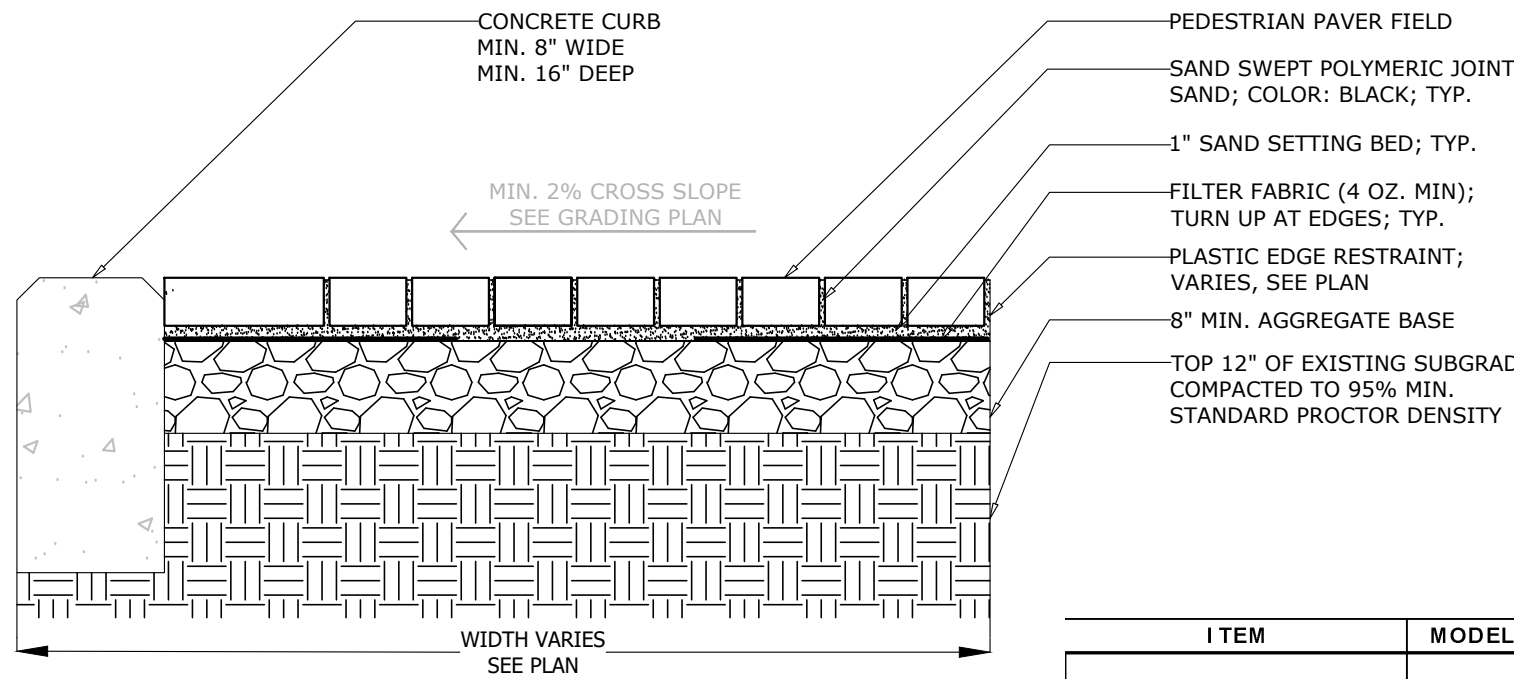
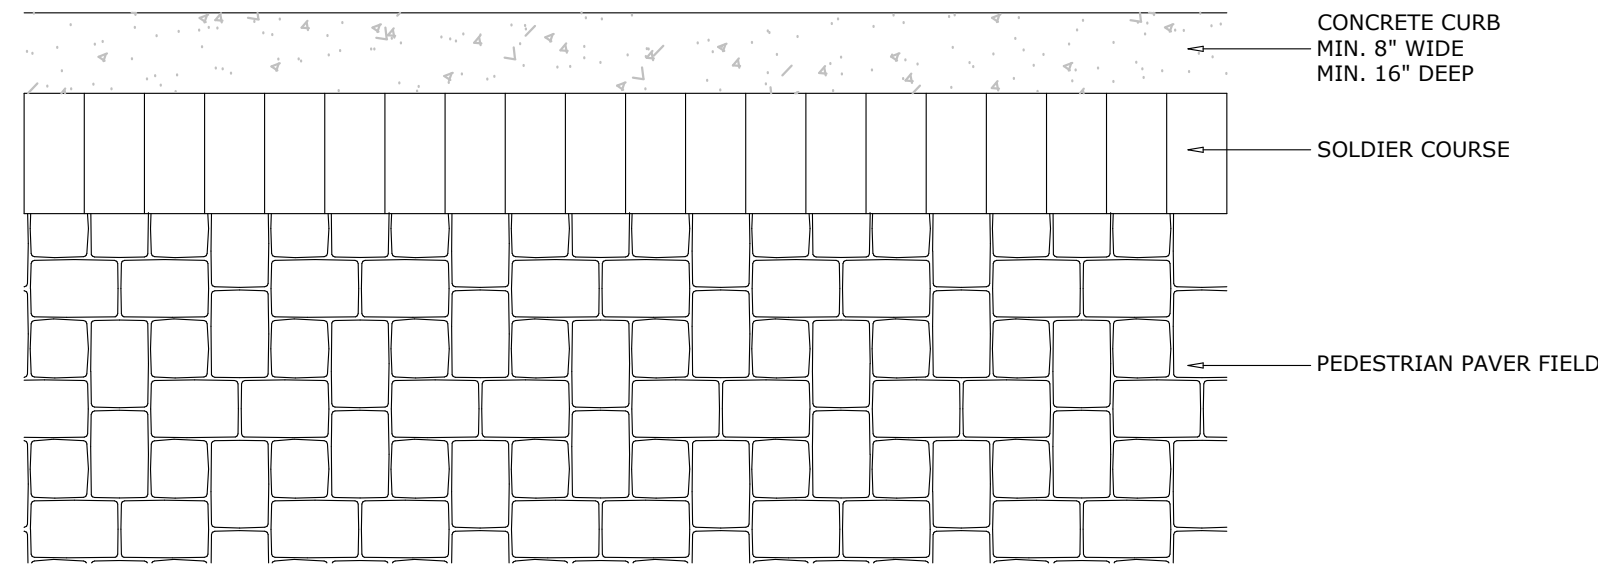


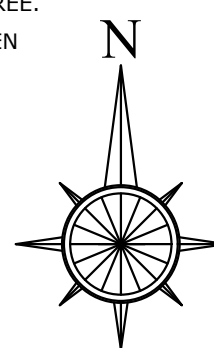Know what's below  
Call before you dig



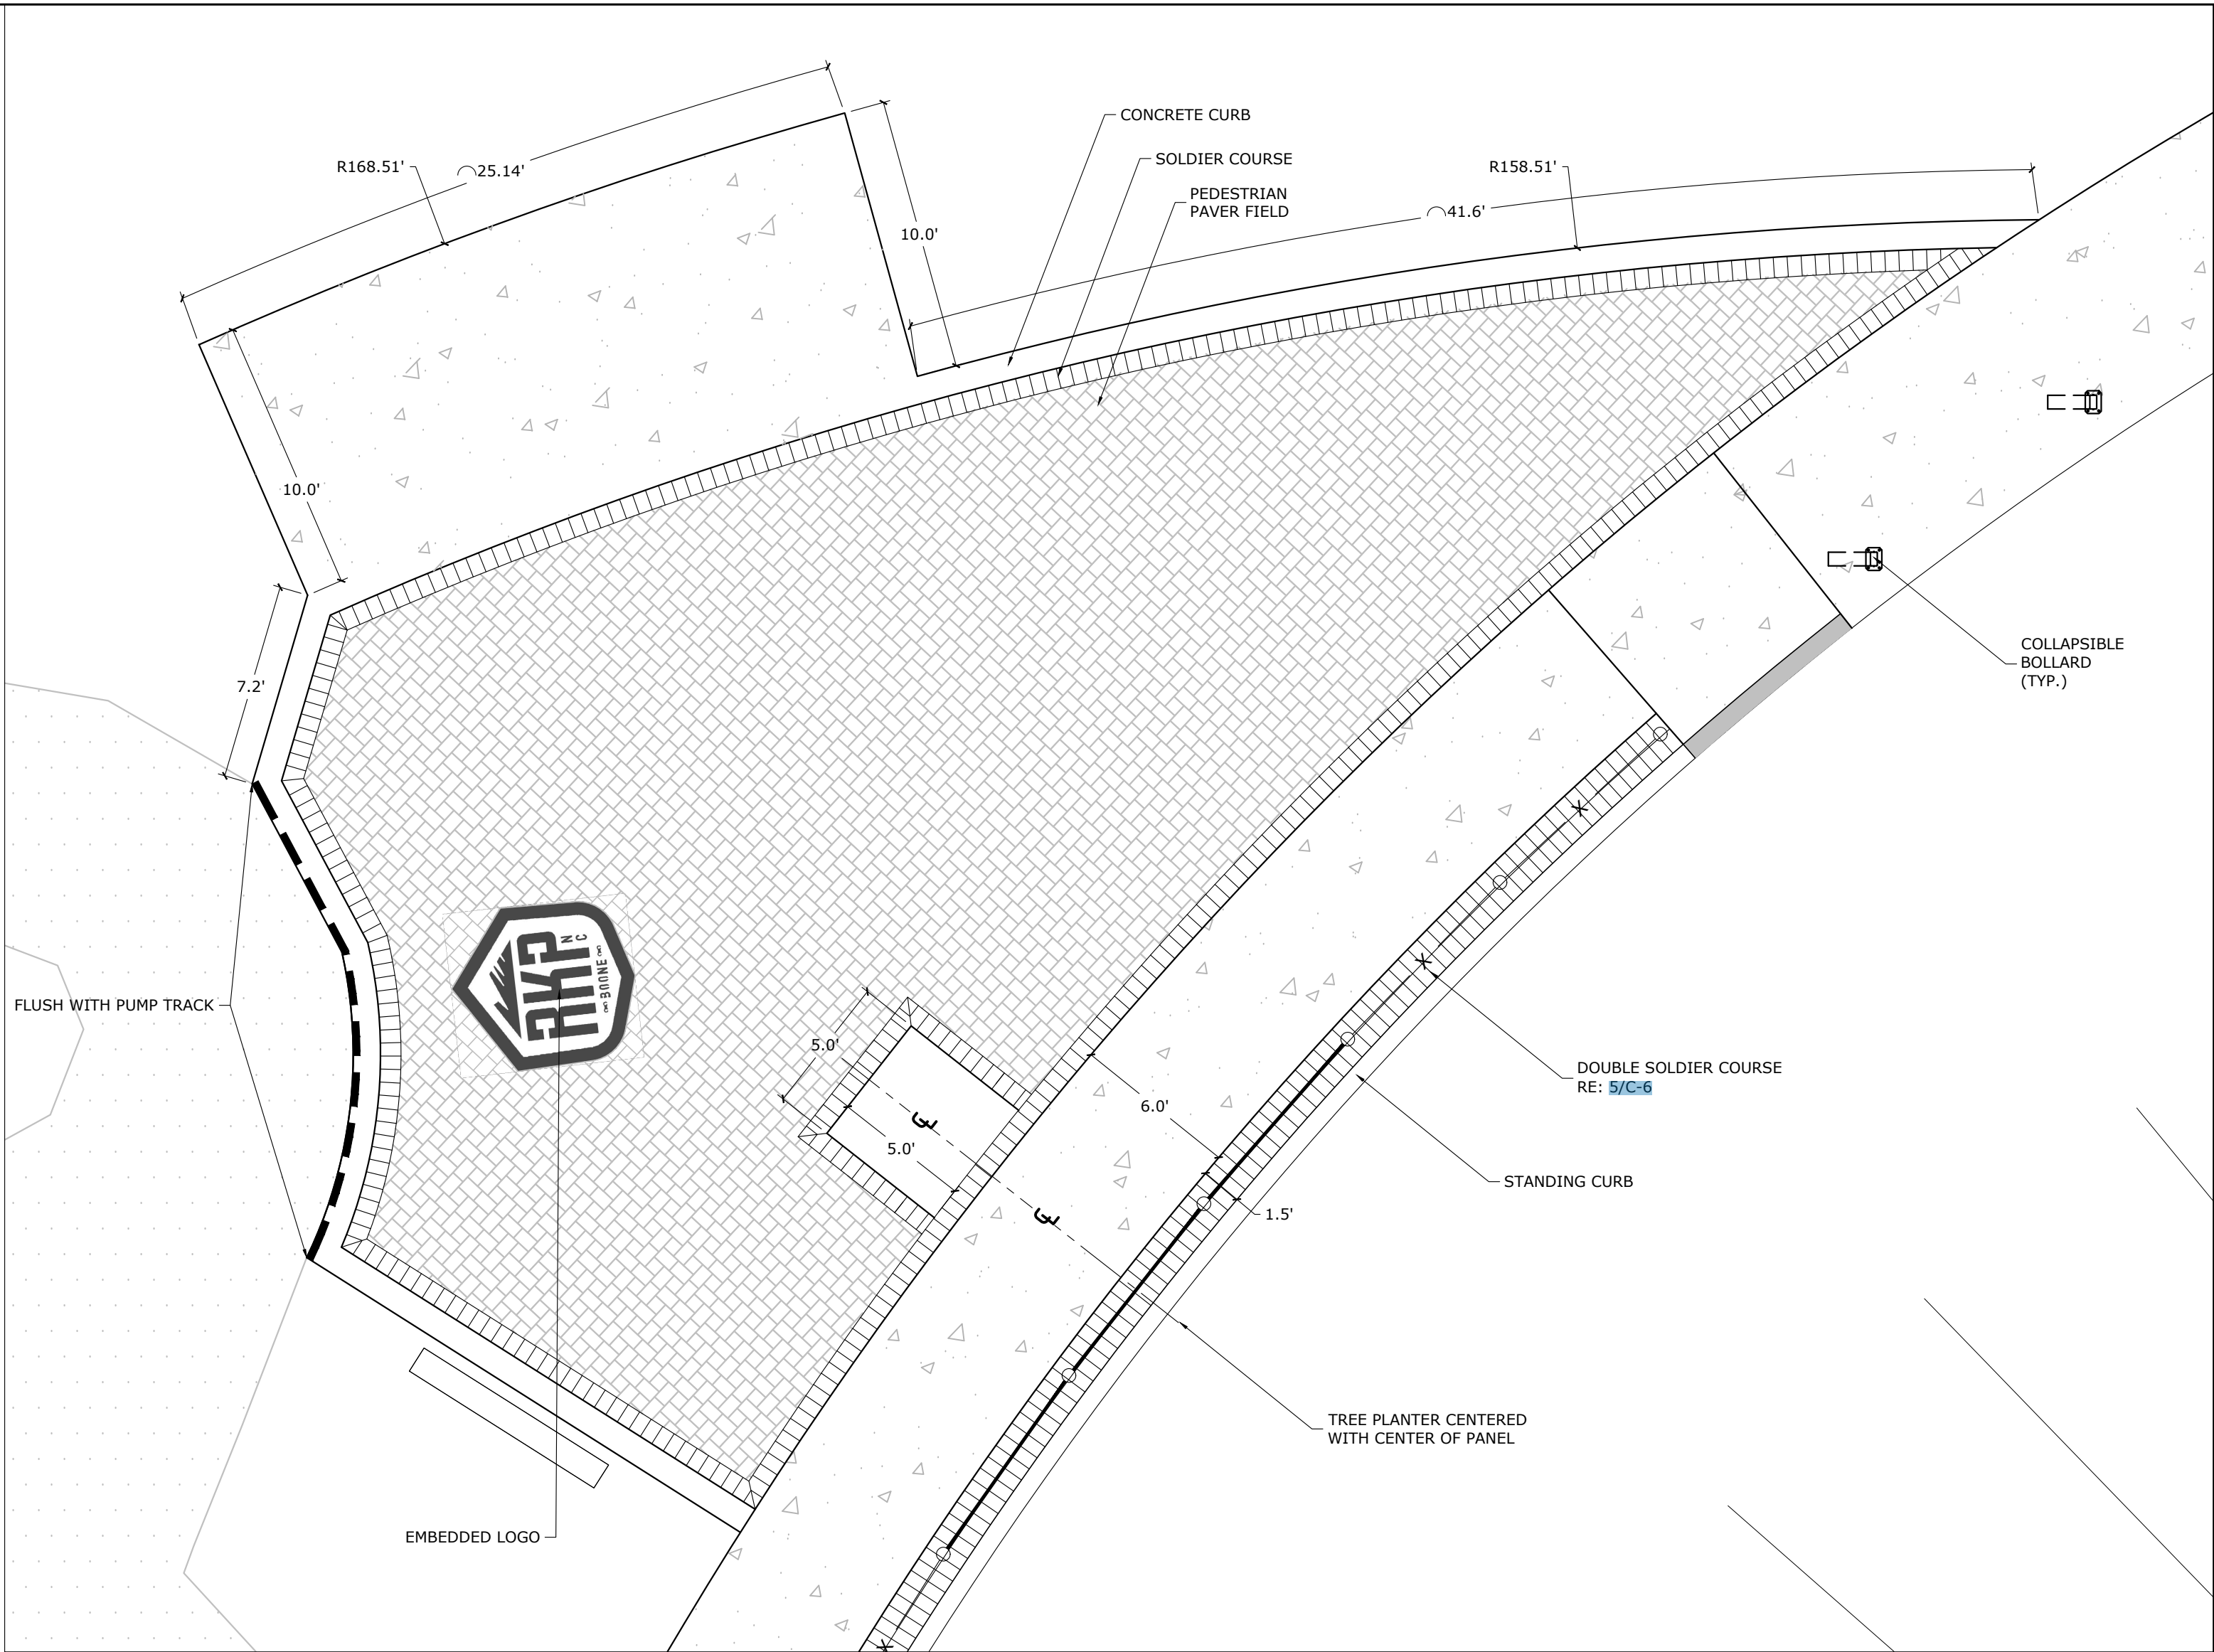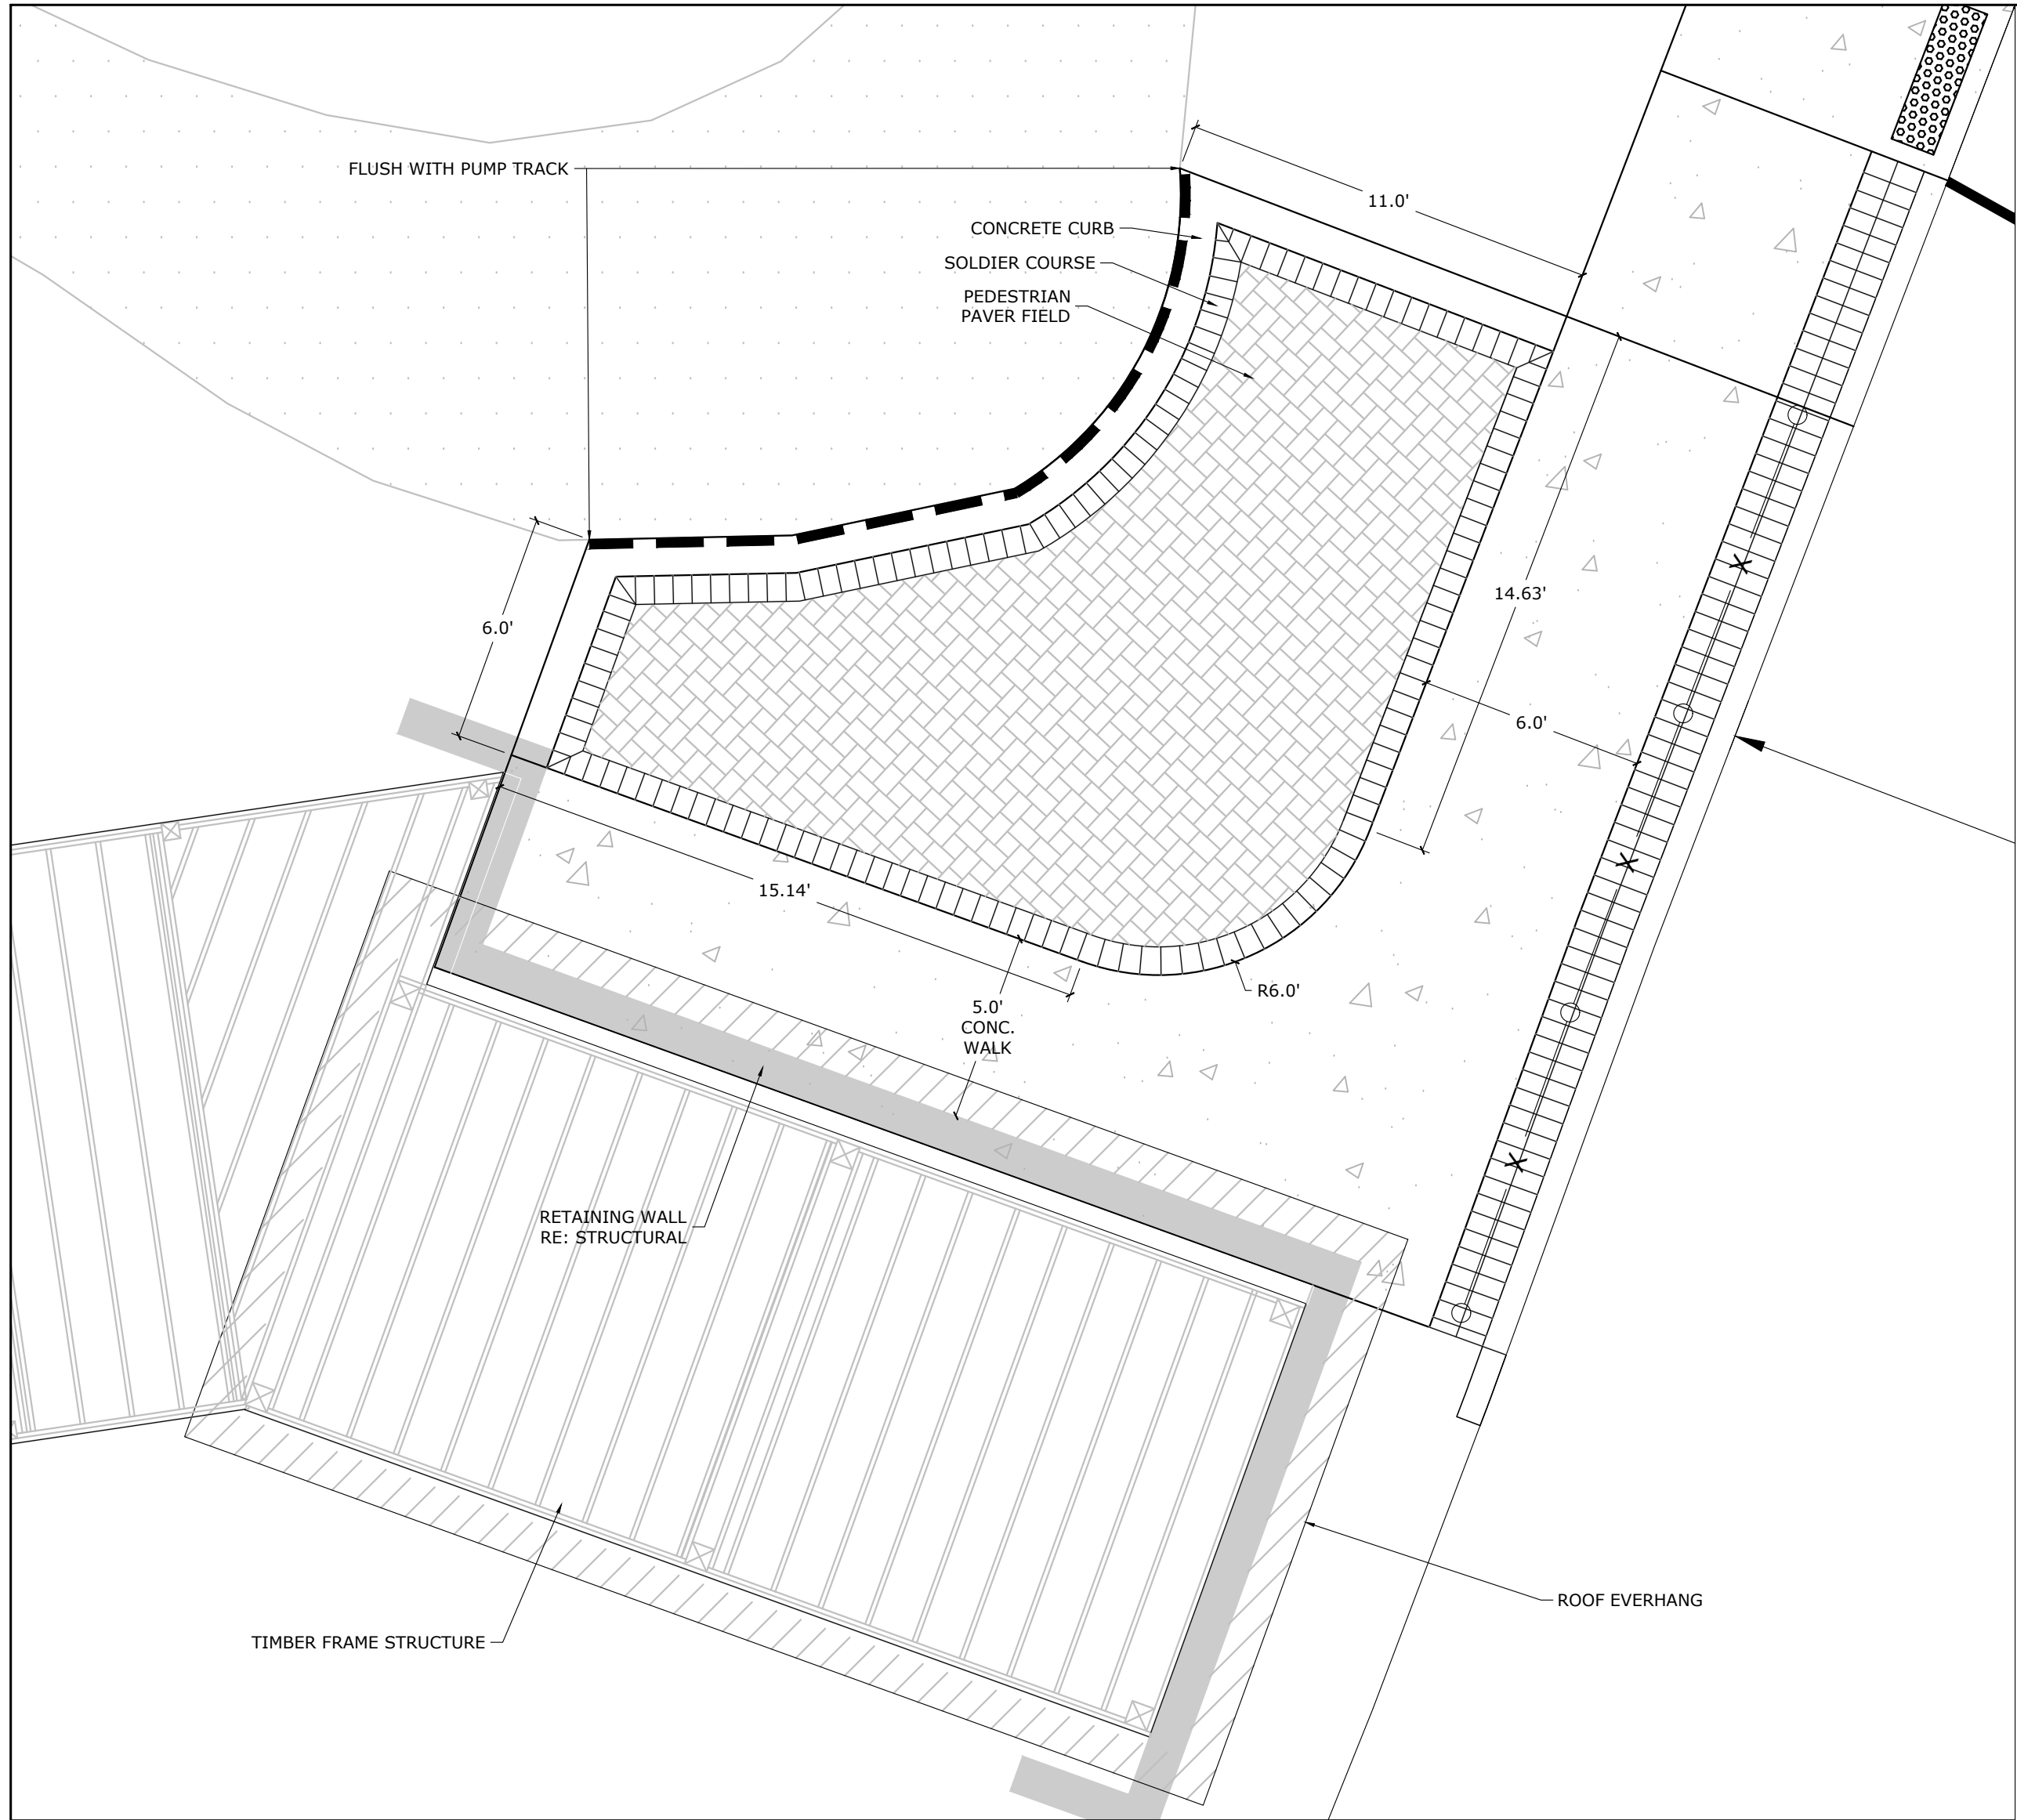

1  
L-2  
PAVER PATIO 1




NOTES:  
1.) USE PLASTIC WITH SPIKE EDGE RESTRAINT WHERE JOINING LANDSCAPE

3  
L-2  
PAVER DETAIL


| ITEM                   | MODEL NO. OR DESCRIPTION | MANUFACTURER                             | COLOR(S)     | COMMENTS                   |
|------------------------|--------------------------|--|--------------|----------------------------|
| PEDESTRIAN PAVER FIELD | CAMBRIDGE COBBLE         | BELGARD<br>BELAGRD.COM<br>(877) 235-4273 | ARCTIC       | PATTERN E                  |
|                        |                          | ** OR APPROVED EQUAL **                  |              |                            |
| SOLDIER COURSE         | CAMBRIDGE COBBLE         | BELGARD<br>BELAGRD.COM<br>(877) 235-4273 | COBBLE BLEND | SOLDIER & SAILOR<br>COURSE |
|                        |                          | ** OR APPROVED EQUAL **                  |              |                            |

2  
L-2  
PAVER PATIO 2

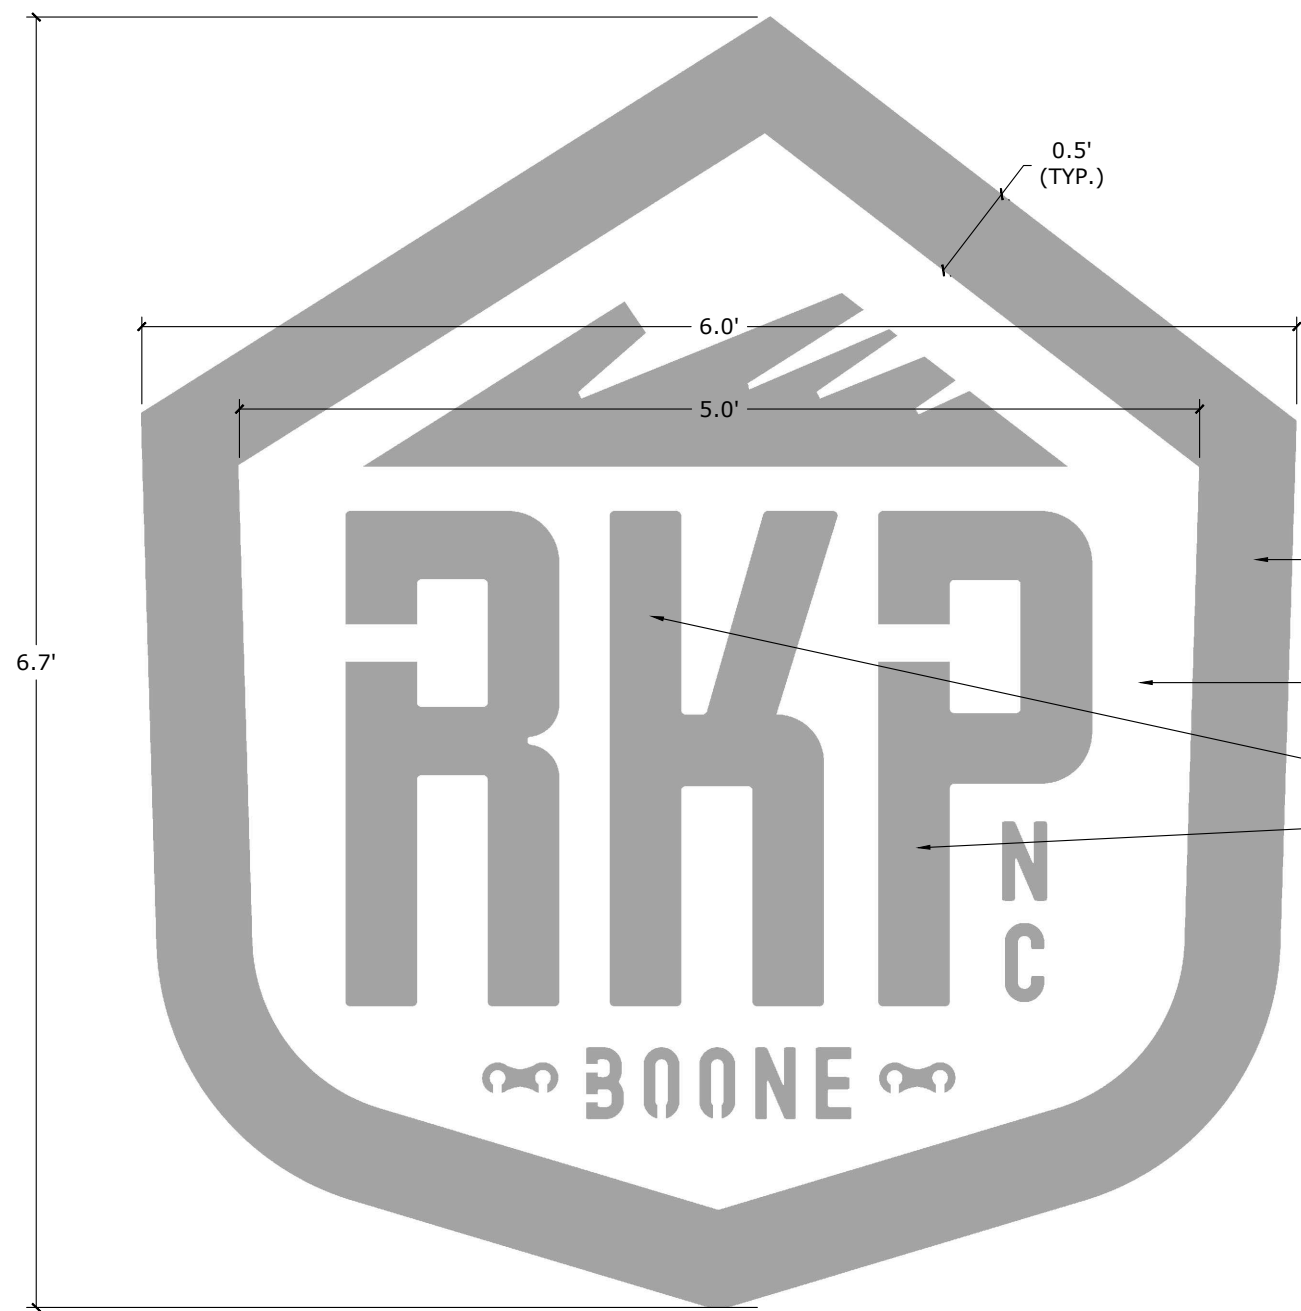

4  
L-2  
EMBEDDED LOGO

- NOTES:
- COLOR TO BE BLACK. CONTRACTOR TO PROVIDE COLOR SAMPLES TO LANDSCAPE ARCHITECT.
  - COLOR TO BE INTEGRATED WITHIN CONCRETE.
  - NON-SLIP SEALANT TO BE APPLIED TO BOTH CONCRETE AND STAINLESS STEEL EMBLEM.
  - PROJECT LANDSCAPE ARCHITECT TO PROVIDE DESIGN FILE FOR USE TO MANUFACTURE STAINLESS STEEL EMBLEM.
  - CONTRACTOR TO PROVIDE SHOP DRAWINGS FOR APPROVAL BY LANDSCAPE ARCHITECT.

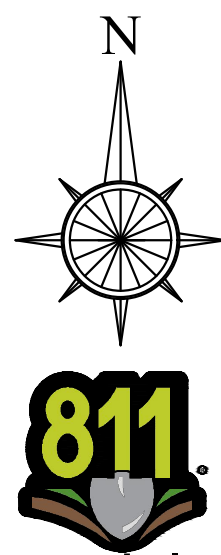

Know what's below  
Call before you dig

PROJECT:



## ROCKY KNOB PARK EXPANSION

ADDRESS: 285 MOUNTAIN BIKE WAY | BOONE |  
WATAUGA COUNTY | NC | 28607

CLIENT:



## WATAUGA CO. TDA

CONTACT: L. WRIGHT TILLEY, EXECUTIVE  
DIRECTOR

ADDRESS: 331 QUEEN STREET, SUITE 101 |  
BOONE | WATAUGA COUNTY | NC | 28607

LANDSCAPE ARCHITECT:

## DESTINATION BY DESIGN

ADDRESS: 136 FURMAN ROAD, SUITE 6 |  
BOONE | WATAUGA COUNTY | NC | 28607

SEAL:



09/01/23

REVISIONS DATE

PROJECT MANAGER: CAG

DRAWING BY: ED

JURISDICTION: WATAUGA COUNTY

DATE: 09.01.2023

SHEET TITLE:


## PAVER ENLARGEMENT

SHEET NUMBER: L-2


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FILE NUMBER:




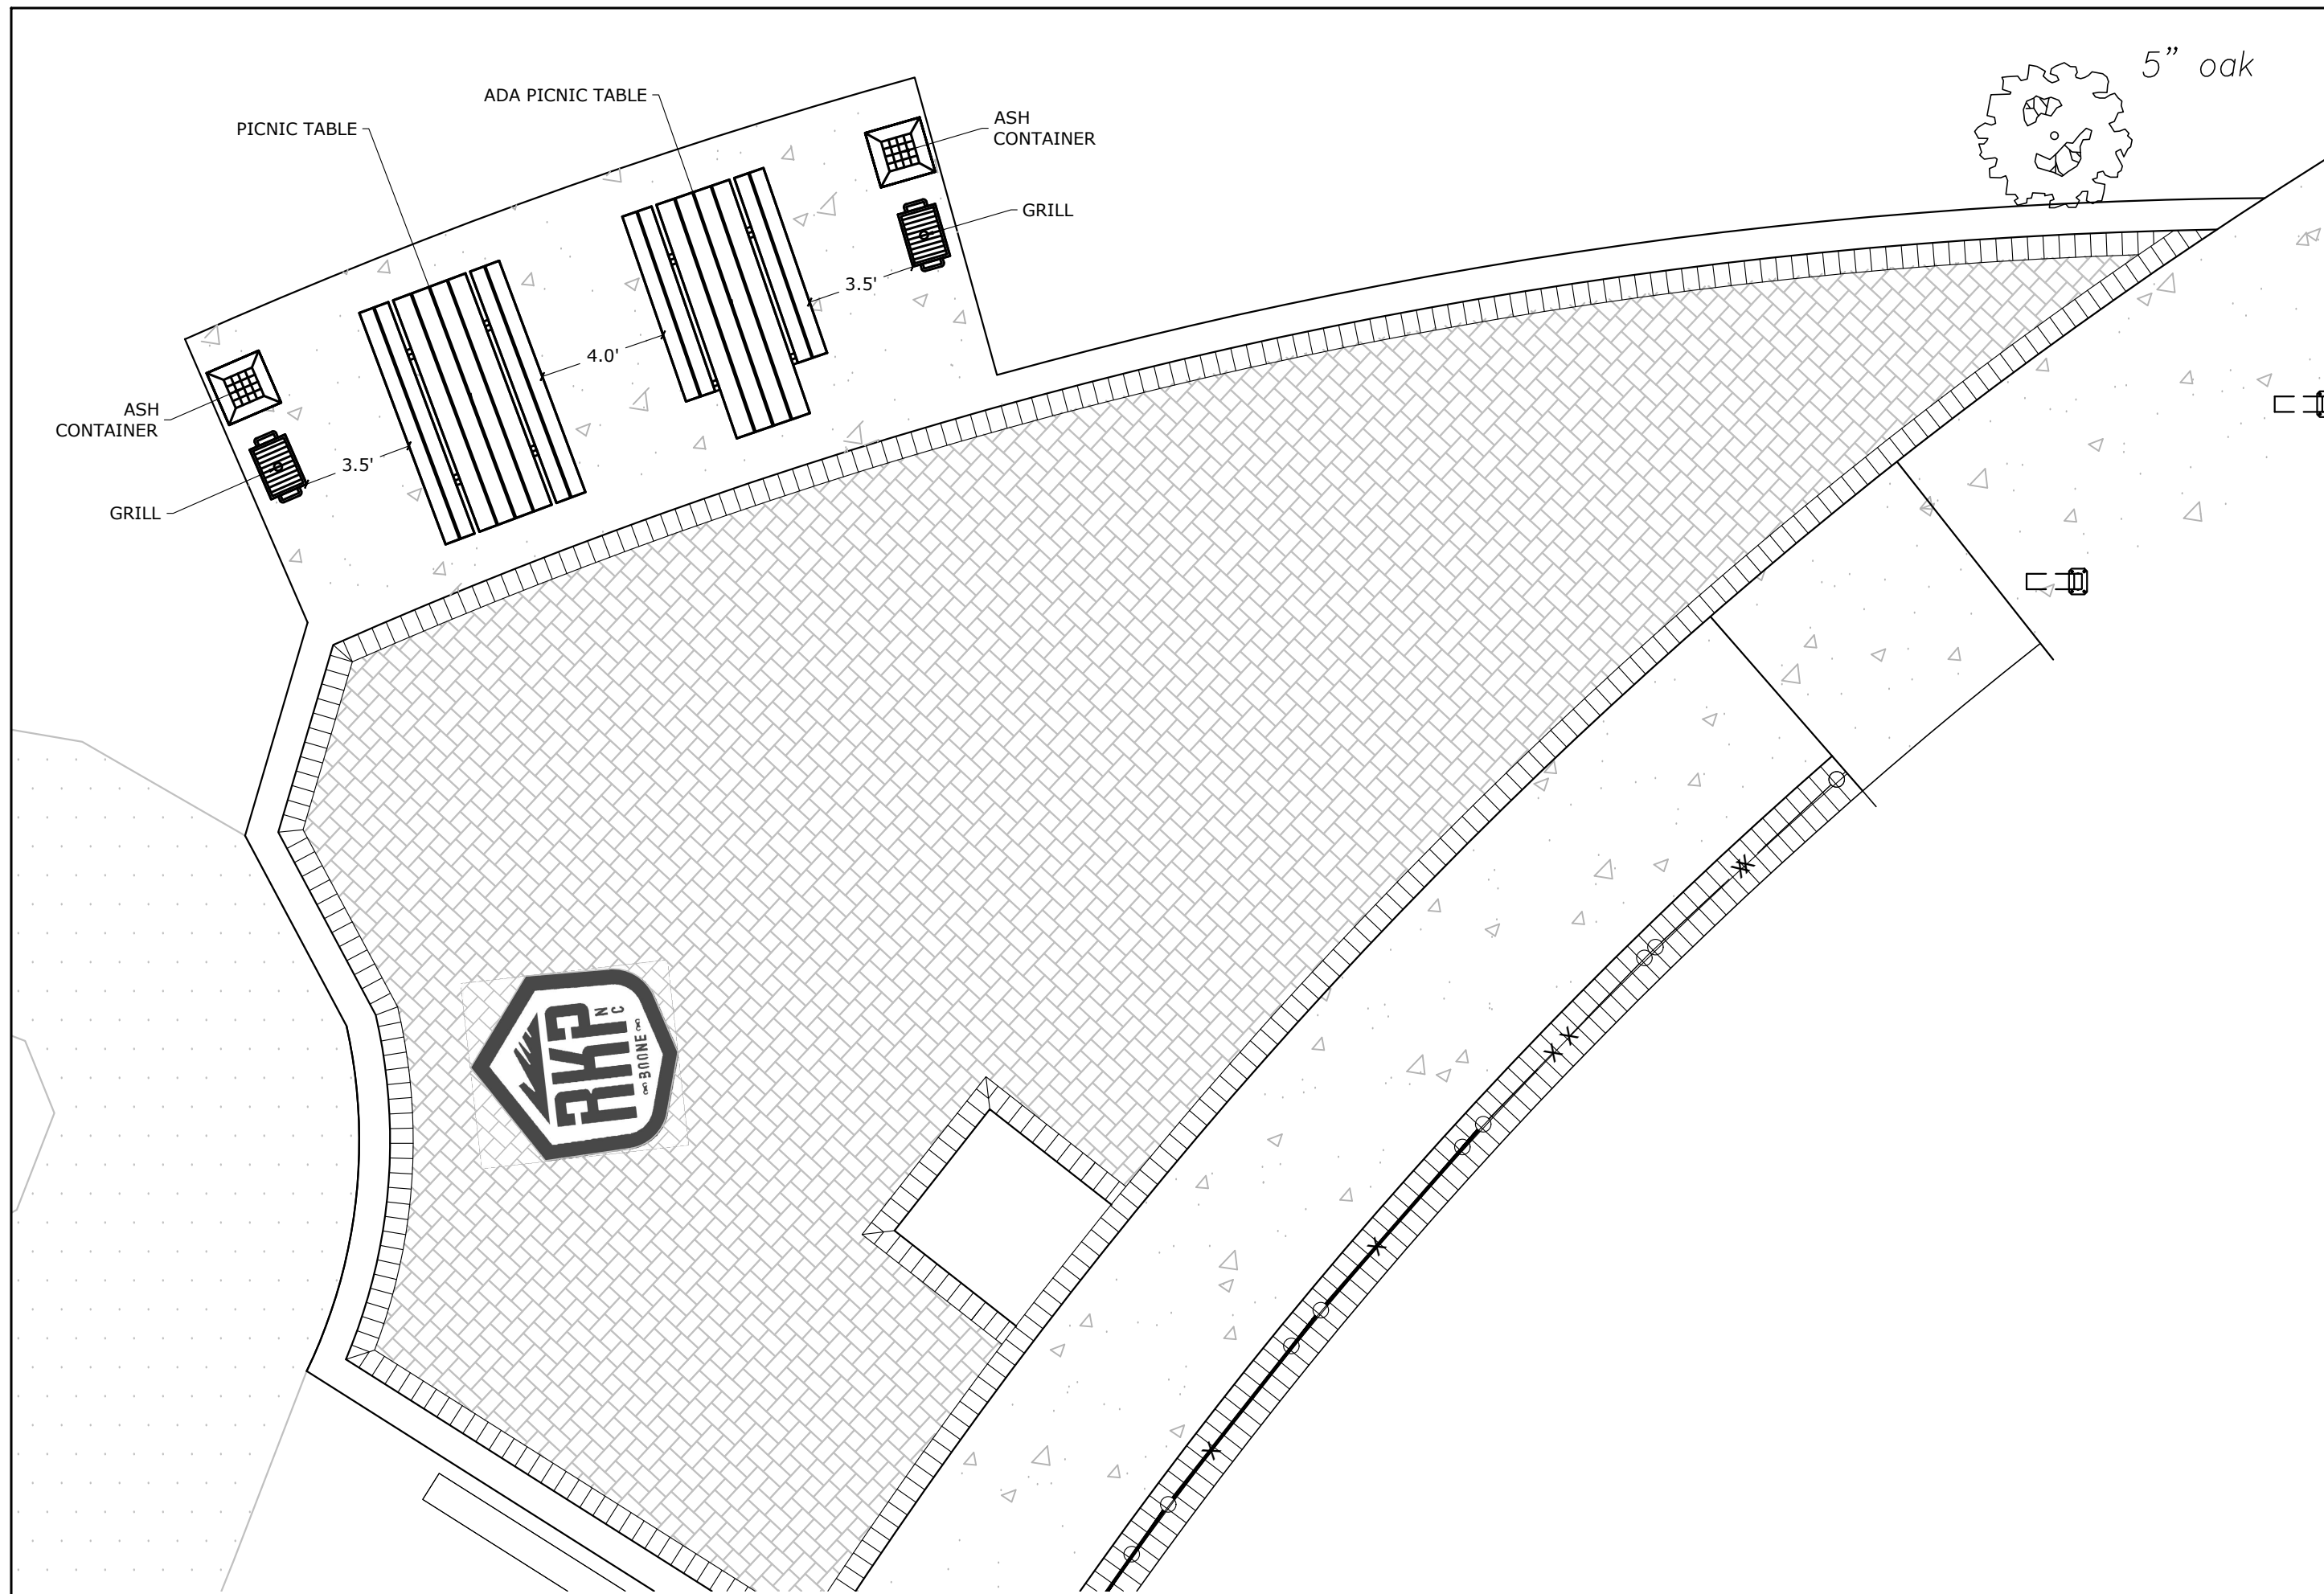


1 PLAZA FURNISHINGS  
1"=5'

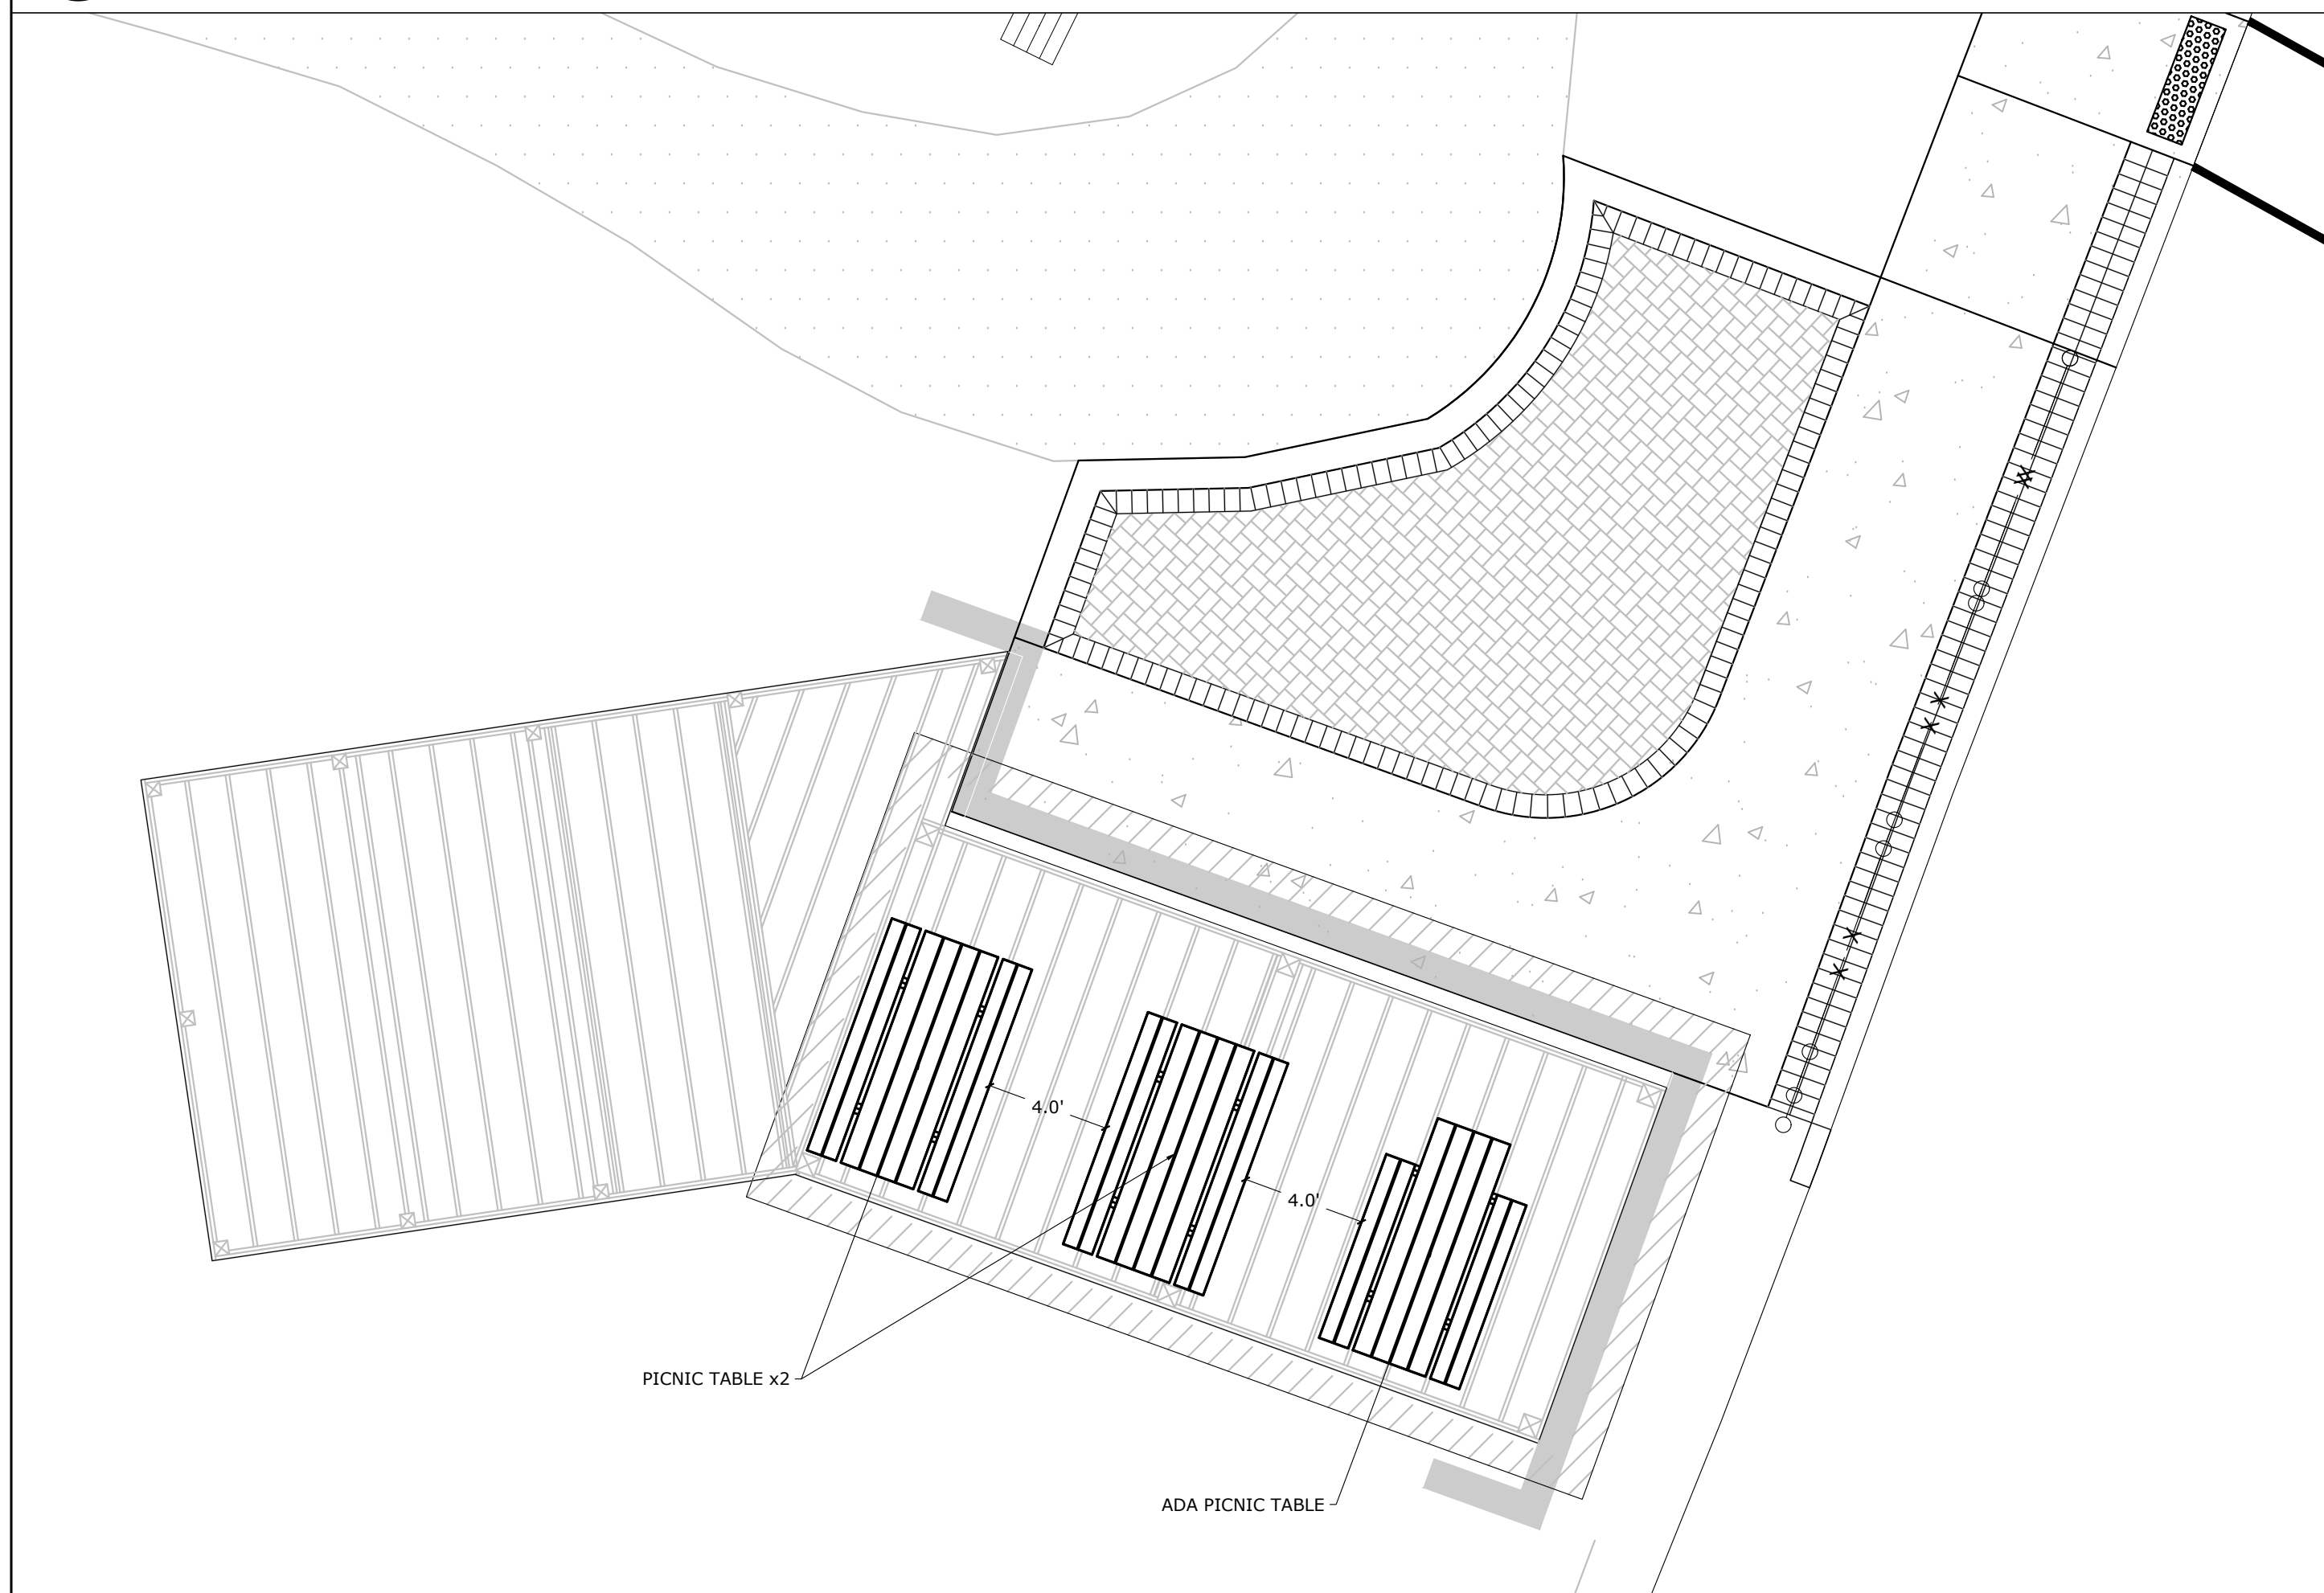


2 SHELTER FURNISHINGS  
1"=5'

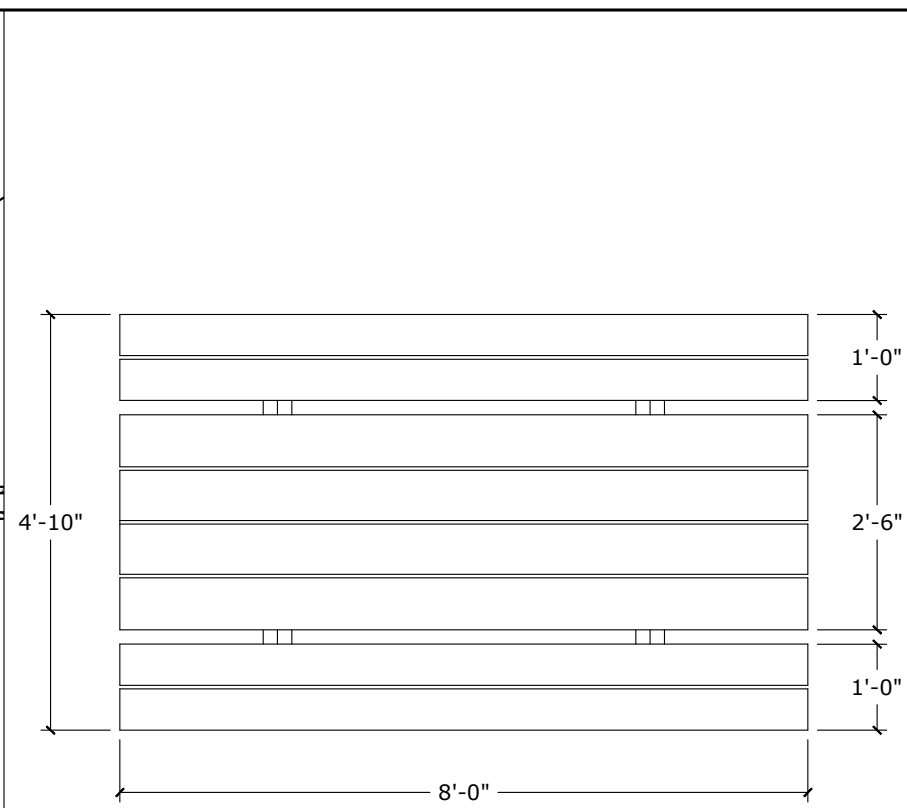

3 PICNIC TABLE  
N.T.S.

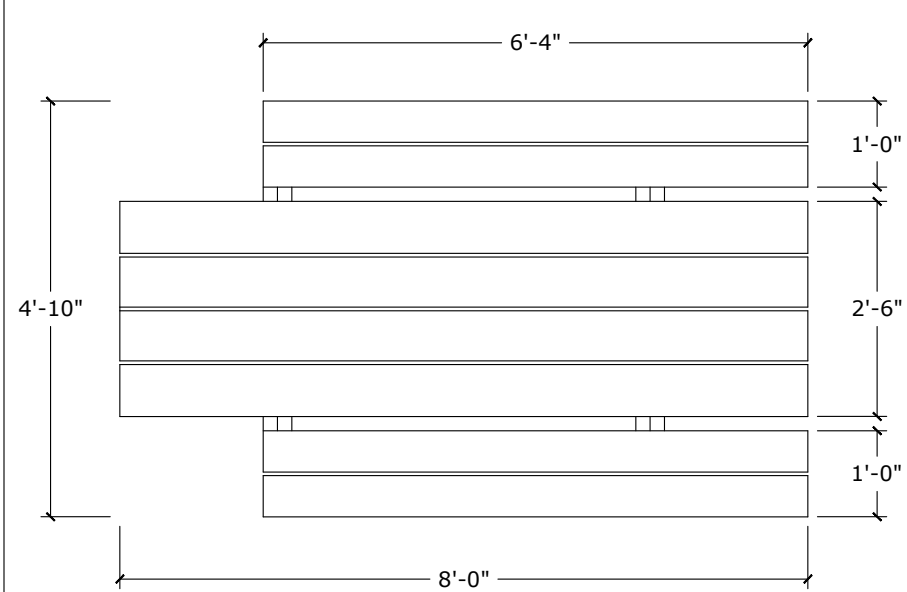

4 ADA PICNIC TABLE  
N.T.S.

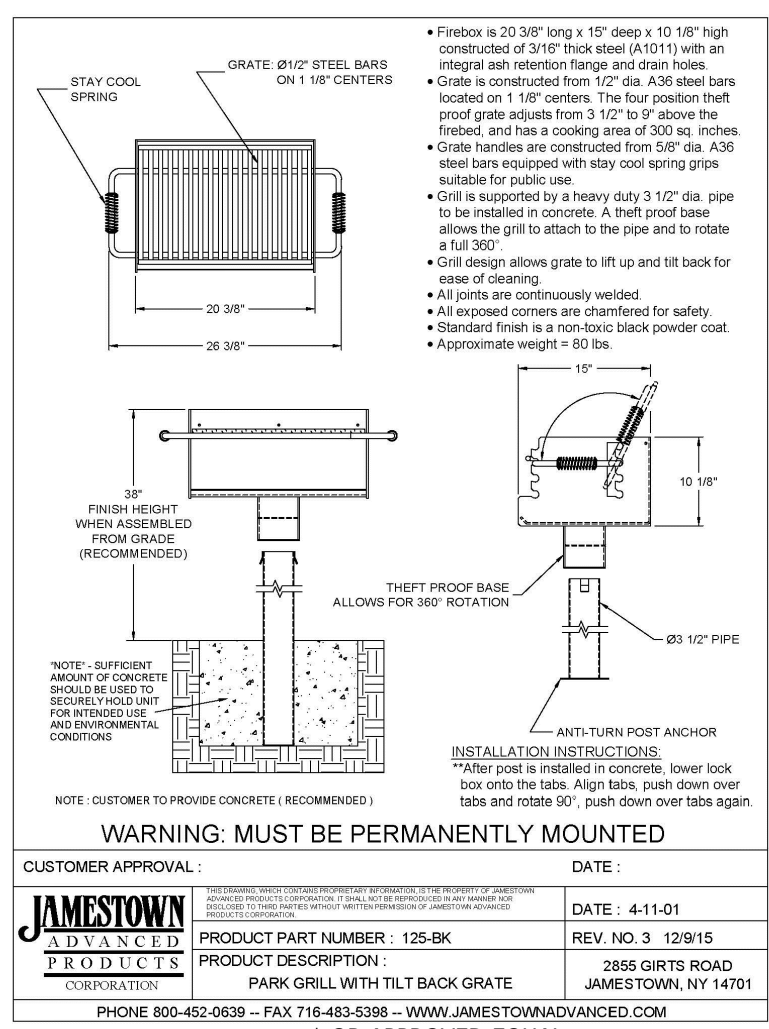


4 GRILL  
N.T.S.

NOTES:  
1. GRILL TO BE DIRECT BURY MOUNTED.




5 ASH CONTAINER  
N.T.S.

NOTES:  
1. ALL LUMBER TO BE WHITE OAK FINISHED WITH MIN. 2 COATS BOILED LINSEED OIL.  
2. ALL FASTENERS TO BE STAINLESS STEEL.  
3. FASTENERS USED TO ATTACH SEAT AND TABLE TOP TO BE HIDDEN. DO NOT FACE SCREW.  
4. 6" C-CHANNEL TO BE POWDER COATED BLACK.

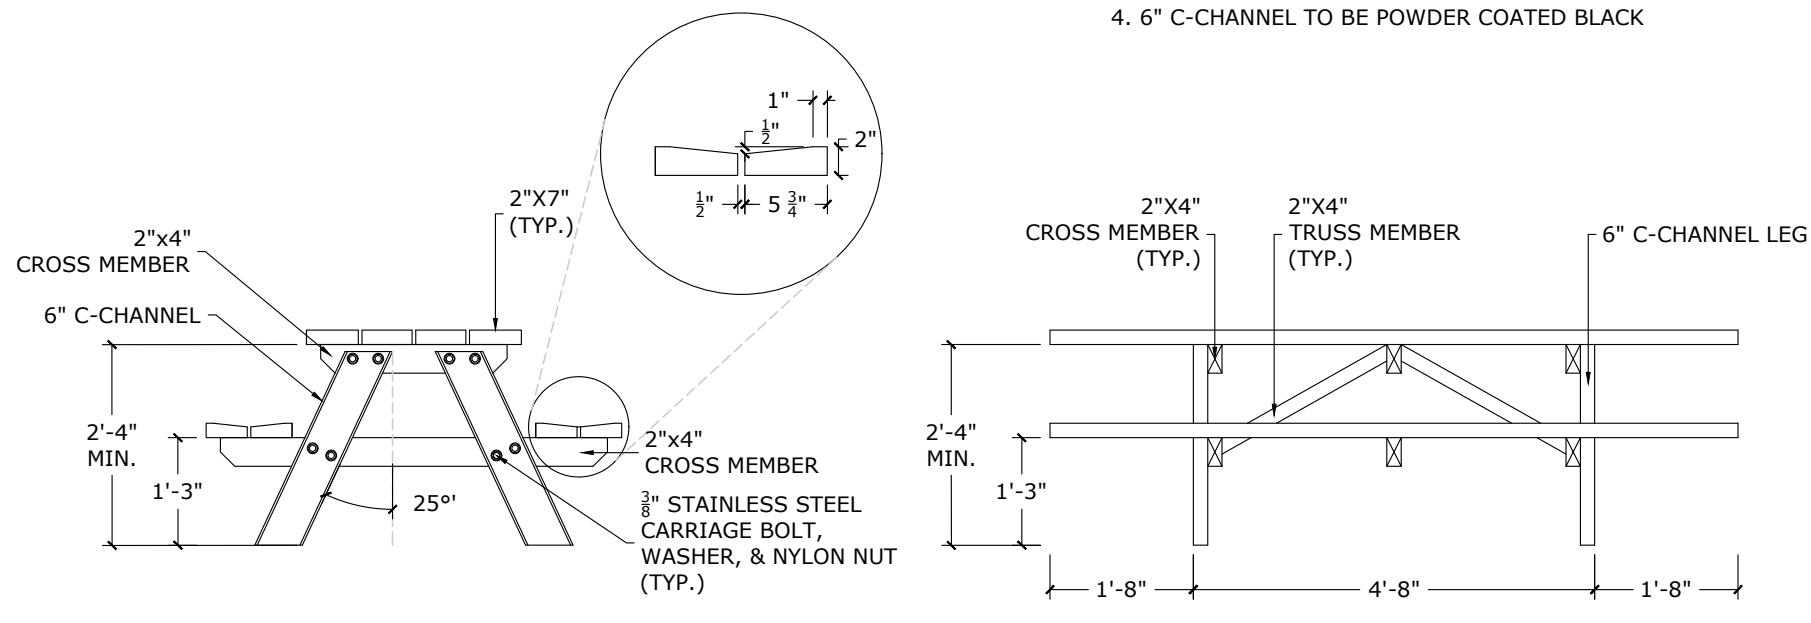

NOTES:  
1. ALL LUMBER TO BE WHITE OAK FINISHED WITH MIN. 2 COATS BOILED LINSEED OIL.  
2. ALL FASTENERS TO BE STAINLESS STEEL.  
3. FASTENERS USED TO ATTACH SEAT AND TABLE TOP TO BE HIDDEN. DO NOT FACE SCREW.  
4. 6" C-CHANNEL TO BE GALVANIZED.

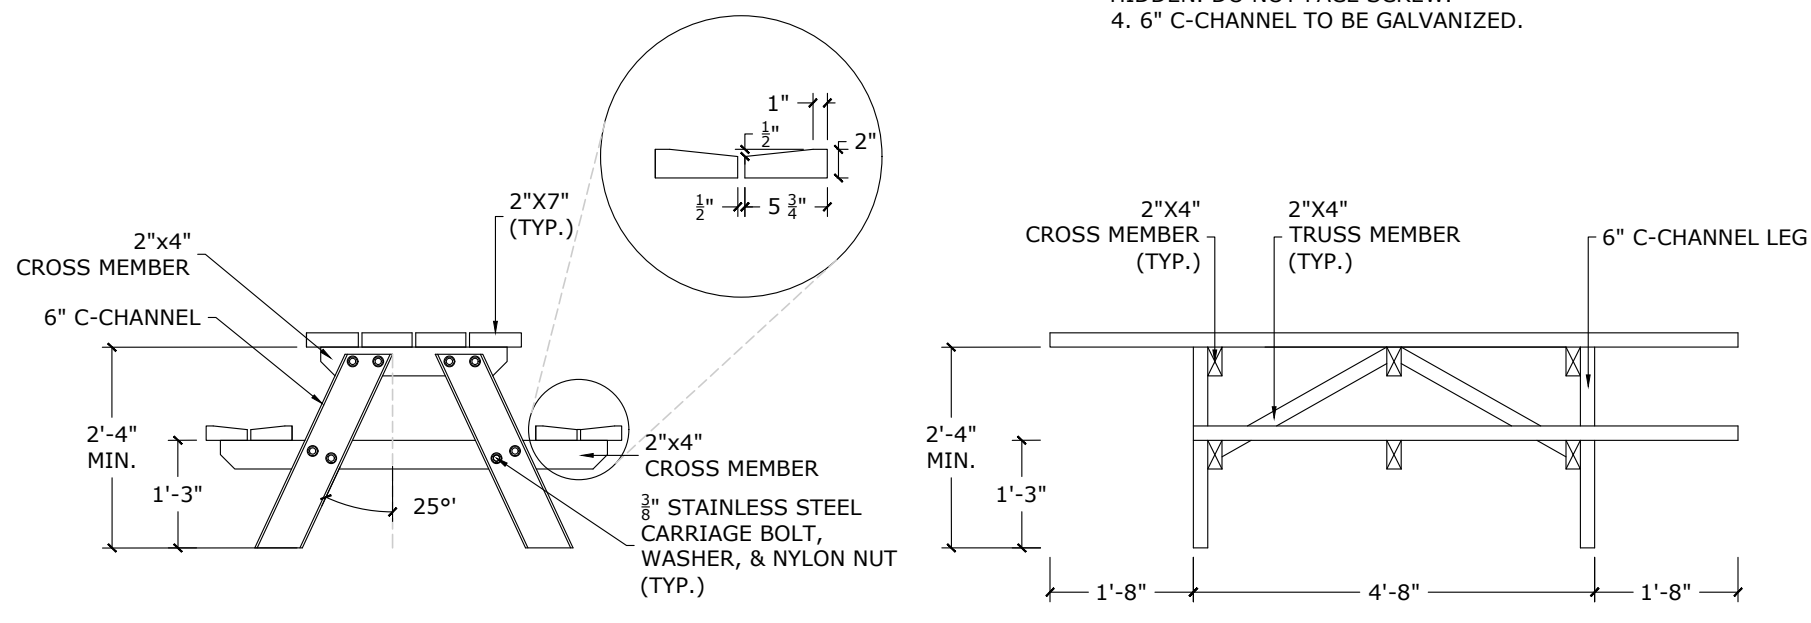


PROJECT:



ROCKY KNOB PARK  
EXPANSION

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CLIENT:



WATAUGA CO. TDA

CONTACT: L. WRIGHT TILLEY, EXECUTIVE DIRECTOR

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LANDSCAPE ARCHITECT:



DESTINATION  
BY DESIGN

ADDRESS: 136 FURMAN ROAD, SUITE 6 | BOONE | WATAUGA COUNTY | NC | 28607

SEAL:



09/01/23

| REVISIONS | DATE |
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PROJECT MANAGER: CAG

DRAWING BY: ED

JURISDICTION: WATAUGA COUNTY

DATE: 09.01.2023

SHEET TITLE:


FURNISHINGS PLAN

SHEET NUMBER: L-3


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FILE NUMBER:




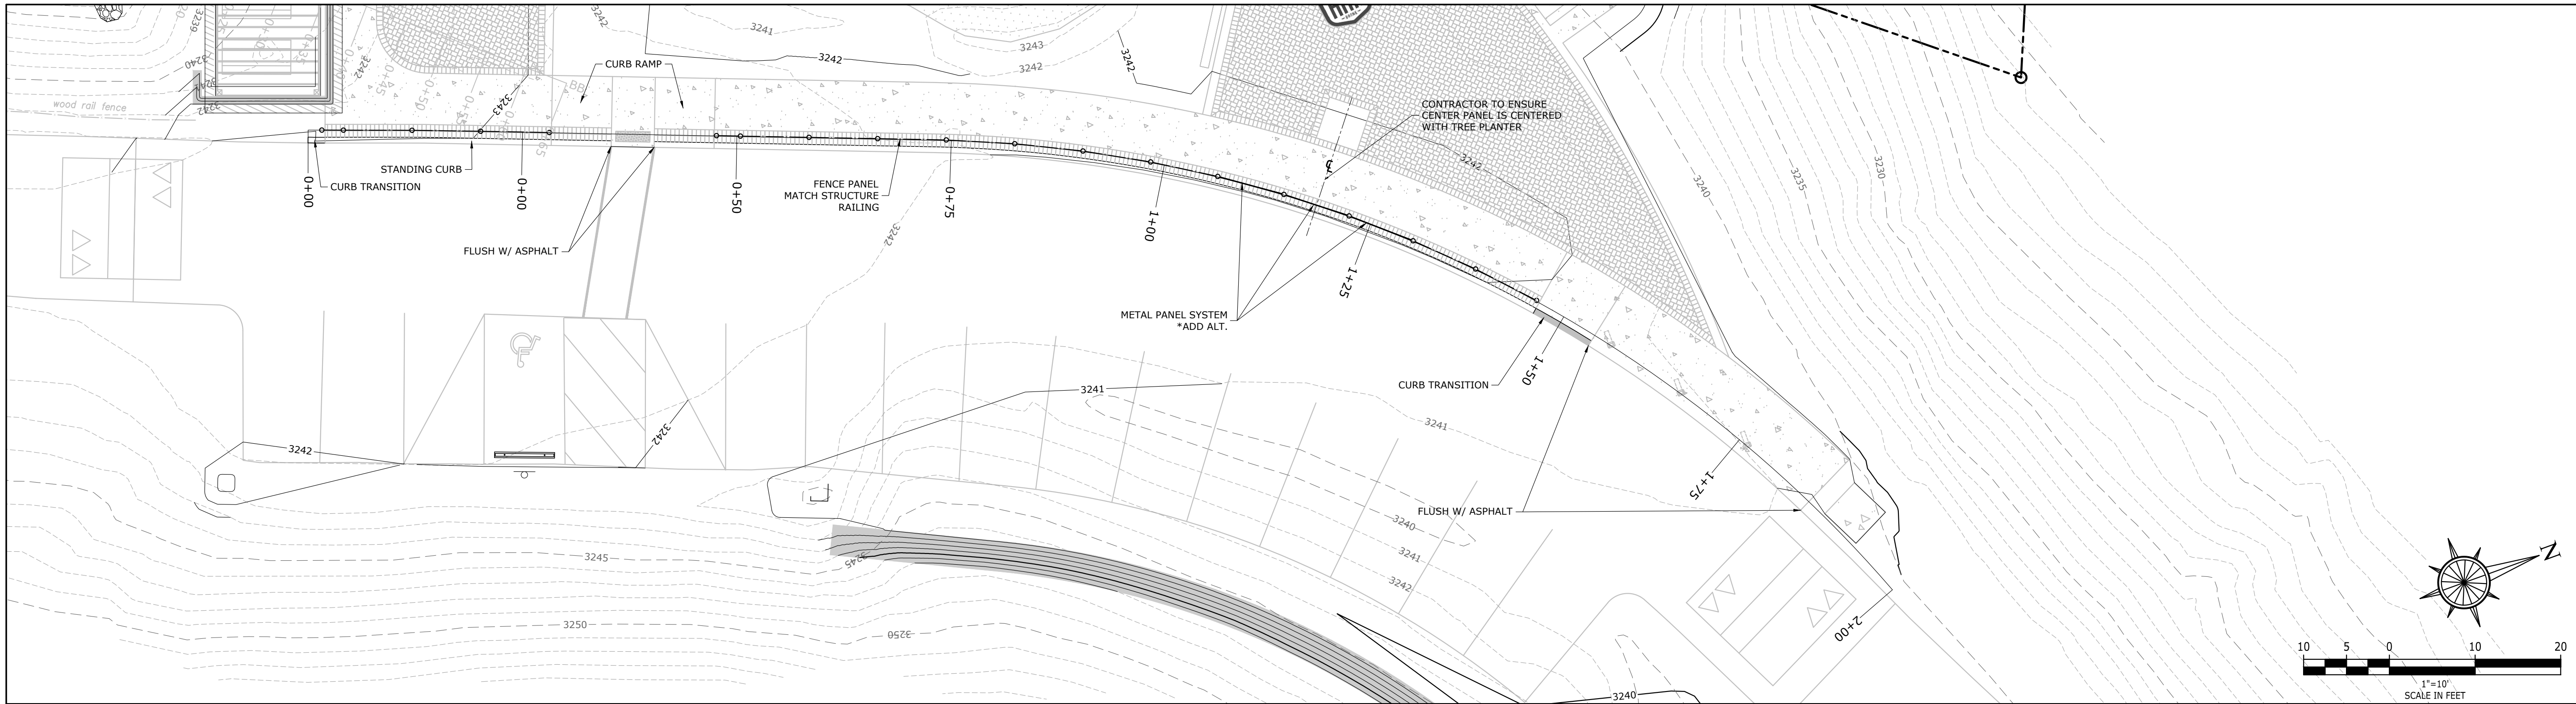


1 FENCE PLAN VIEW

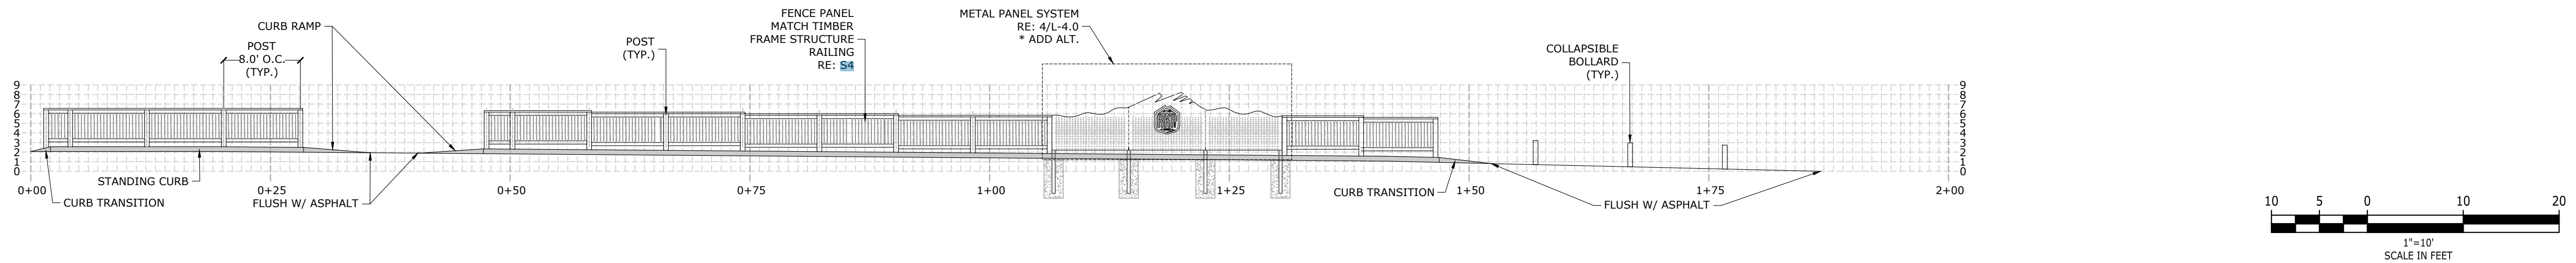


2 FENCE ELEVATION - FRONT

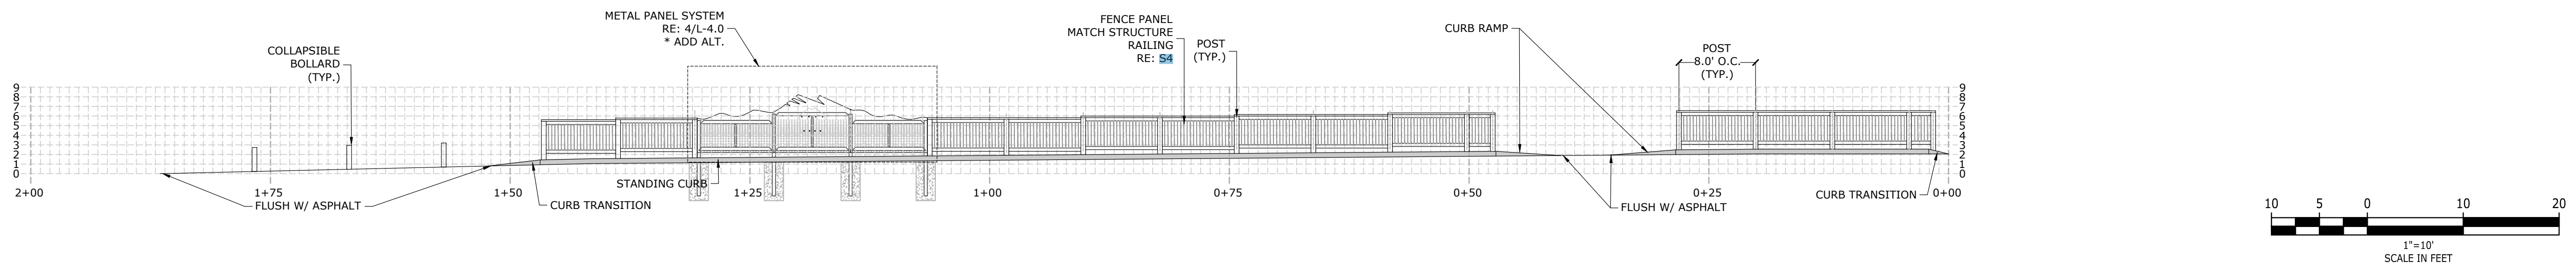


3 FENCE ELEVATION - REAR

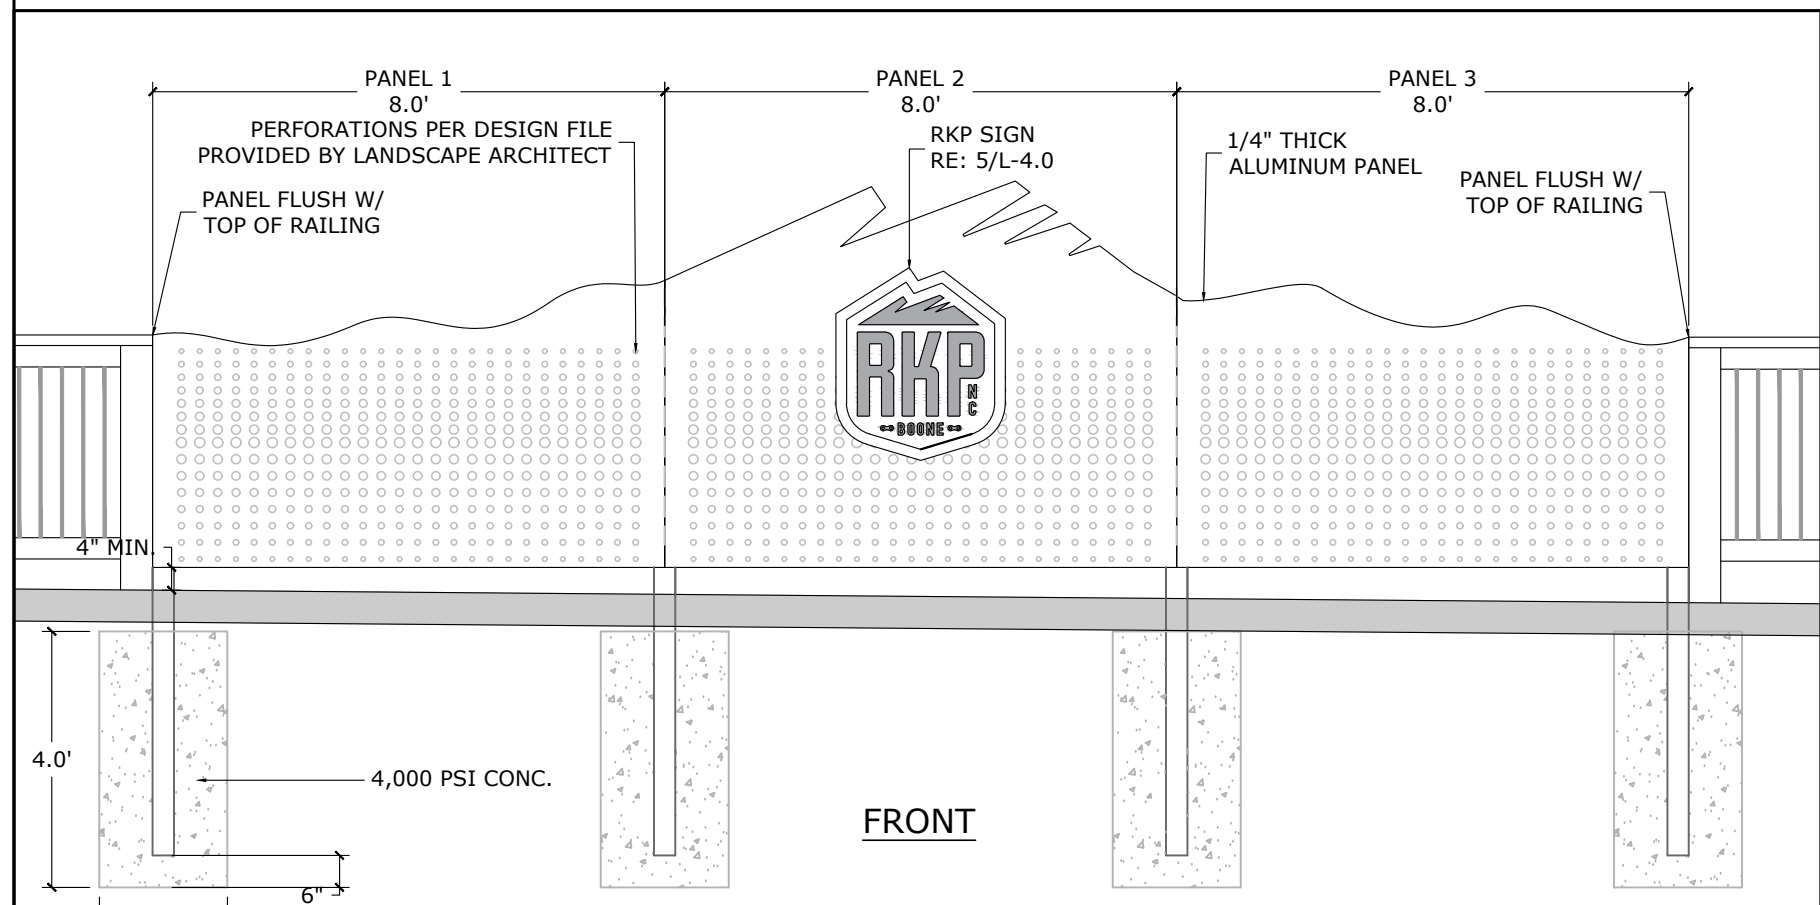

4 METAL PANEL SYSTEM - ADD ALT.

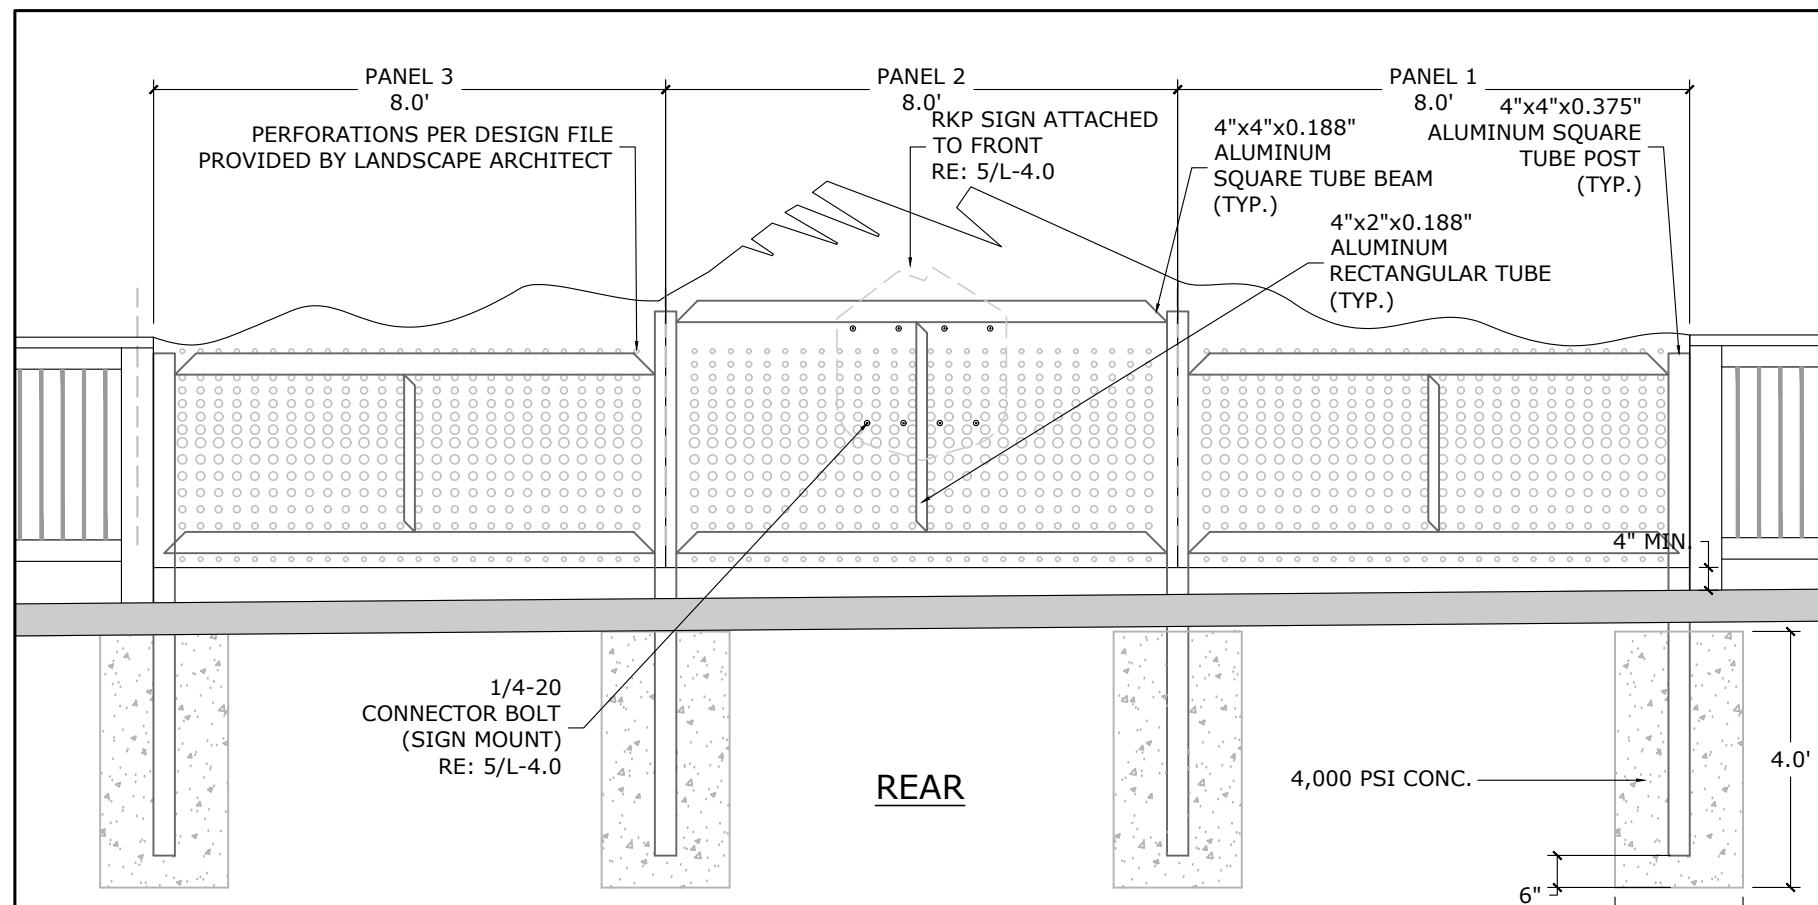

REAR

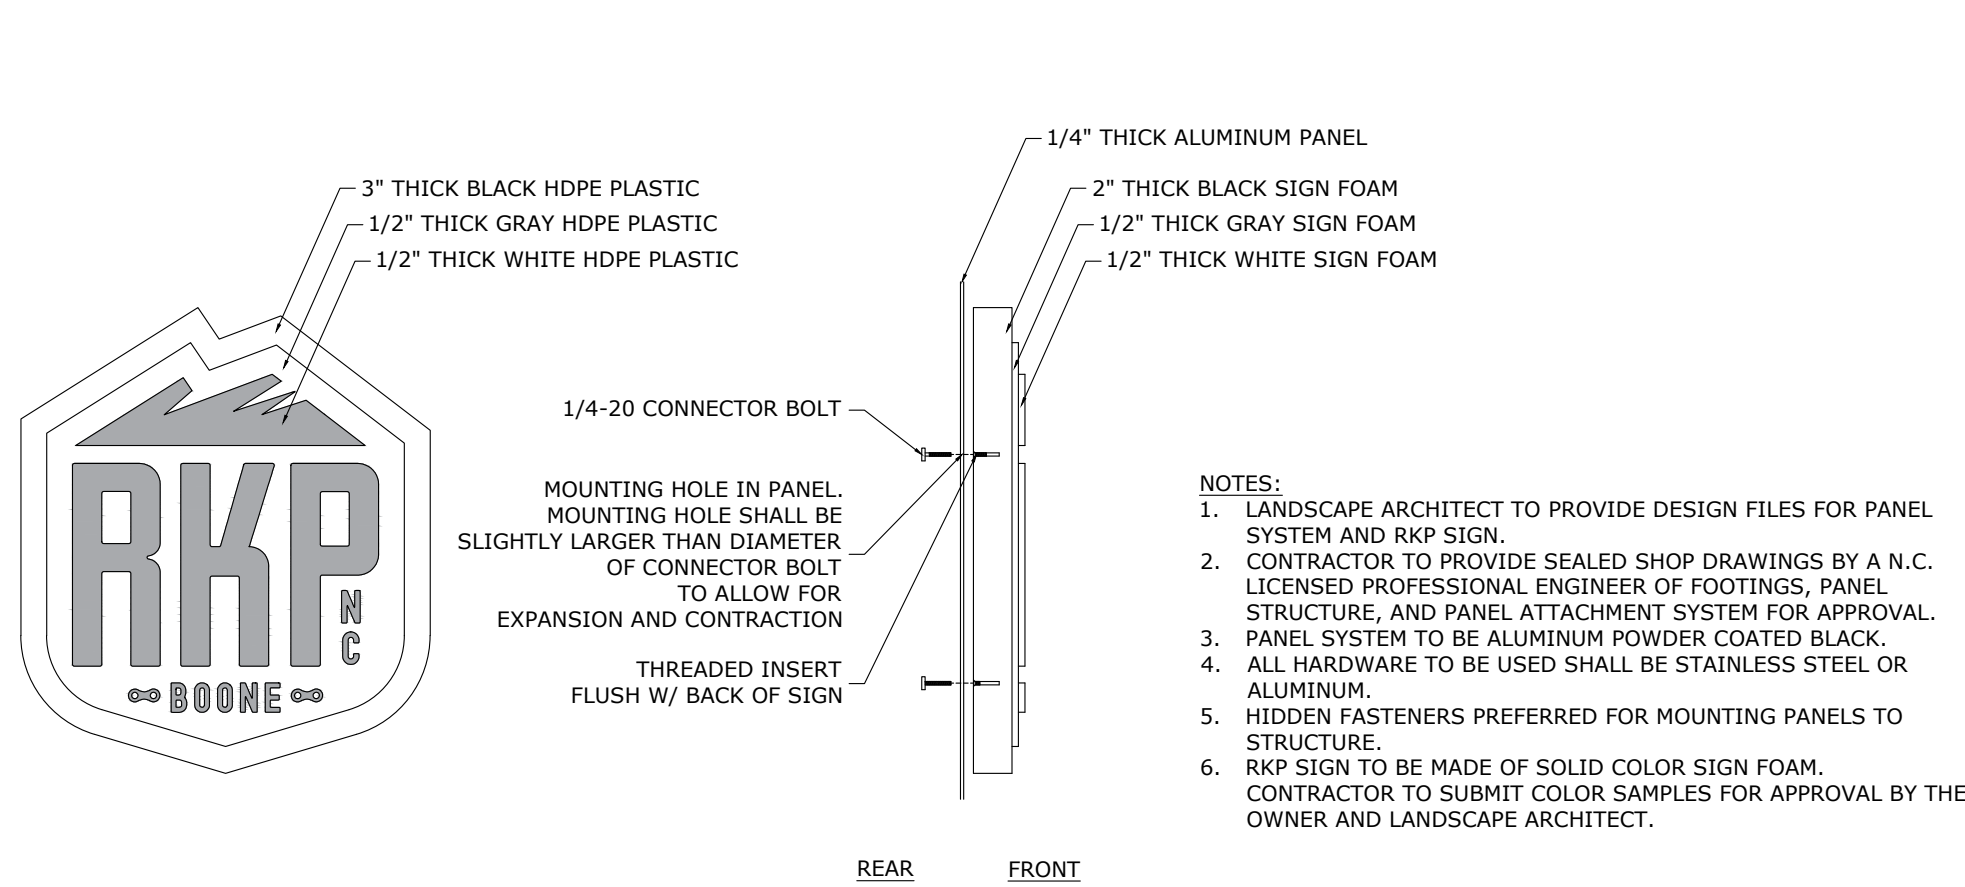

5 RKP SIGN - ADD ALT.

PROJECT:



## ROCKY KNOB PARK EXPANSION

ADDRESS: 285 MOUNTAIN BIKE WAY | BOONE |  
WATAUGA COUNTY | NC | 28607

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DRAWING BY: ED

JURISDICTION: WATAUGA COUNTY

DATE: 09.01.2023

SHEET TITLE:

## FENCE DETAILS

SHEET NUMBER: L-4.0

SCALE:

FILE NUMBER:



DESIGN CRITERIA:

- 2018 NORTH CAROLINA STATE BUILDING CODE: RESIDENTIAL
- ASCE 7-10
- DESIGN LOADS:
  - LIVE LOAD = ROOF = 30 PSF
  - LIVE LOAD = DECK = 100 PSF
  - DEAD LOAD = 15 PSF
  - GROUND SNOW LOAD = 30 PSF
  - ULTIMATE WIND VELOCITY = 130 MPH
  - BASE WIND VELOCITY = 104 MPH
  - EXPOSURE CATEGORY = C
  - ASSUMED GROUND BEARING CAPACITY 2-FT BELOW GRADE: 2,000 PSF
  - ALL BOTTOM OF FOOTINGS SHALL BE CAST A MINIMUM OF 2-FEET BELOW ORIGINAL GROUND LINE. NO FOOTINGS SHALL BE CAST ON FILL MATERIAL UNLESS SUPPORTED BY A HELICAL PILE OR OTHER SUPPORTING MEMBER.

GENERAL NOTES:

- CONTRACTOR SHALL BE RESPONSIBLE FOR LOCATING AND PROTECTING EXISTING UNDERGROUND UTILITIES IN THE AREA OF CONSTRUCTION.
- THE CONTRACTOR SHALL COORDINATE HIS WORK ACTIVITIES WITH THE OWNER, UNLESS SPECIFIED IN DRAWINGS, ALL WATERPROOFING SHALL BE BY OTHERS.
- CONTRACTOR SHALL MAKE A CAREFUL INSPECTION OF THE SITE TO FAMILIARIZE HIM/HERSELF WITH THE ACTUAL CONDITIONS OF THE SITE.
- CONTRACTOR SHALL CHECK AND VERIFY GIVEN DIMENSIONS, TAKE ADDITIONAL DIMENSIONS AS REQUIRED AND REPORT ANY INACCURACIES TO THE ENGINEER. DO NOT SCALE DRAWINGS FOR DIMENSIONS. IF ADDITIONAL DIMENSIONS ARE NEEDED, NOTIFY ENGINEER.
- CONTRACTOR SHALL COORDINATE THESE STRUCTURAL DRAWINGS WITH DRAWINGS OF OTHER DISCIPLINES.
- ALL WORK SHALL CONFORM TO THE CURRENT EDITIONS OF THE NORTH CAROLINA STATE BUILDING CODE, THE AISC CODE, THE AIA BUILDING CODE (ACI 308), THE AMERICAN WELDING SOCIETY CODE AND ALL APPLICABLE ASTM STANDARDS. IN CASES OF CONFLICT, THE MOST STRINGENT REQUIREMENT SHALL GOVERN.
- CONTRACTOR SHALL COORDINATE AND VERIFY SIZE, LOCATION, TYPE, AND DIRECTION OF ALL PADS, DEPRESSIONS, BOLTS, SLEEVES, ANCHORS, INSERTS, OPENINGS, ETC. TO BE SET OR CAST IN CONCRETE OR MASONRY PRIOR TO PLACEMENT.
- CONTRACTOR SHALL COORDINATE ALL DIMENSIONS WITH ARCHITECTURAL/DESIGN DRAWINGS PRIOR TO FOUNDATION LAYOUT AND FABRICATION OF ANY STRUCTURAL MEMBERS.
- GENERAL CONTRACTOR SHALL DESIGN AND INSTALL ALL TEMPORARY SHORING REQUIRED TO STABILIZE NEW AND EXISTING STRUCTURES AND FOUNDATIONS UNTIL CONSTRUCTION IS COMPLETE.
- OMISSIONS OR CONFLICTS BETWEEN VARIOUS ELEMENTS OF THE DRAWINGS, SPECIFICATIONS, NOTES AND DETAILS SHALL BE BROUGHT TO THE ATTENTION OF THE ENGINEER AND RESOLVED BEFORE PROCEEDING WITH THE WORK.
- THE DRAWINGS AND SPECIFICATIONS REPRESENT THE FINISHED STRUCTURE. THEY DO NOT INDICATE THE METHOD OF CONSTRUCTION. THE CONTRACTOR SHALL PROVIDE ALL MEASURES NECESSARY TO PROTECT THE STRUCTURE DURING CONSTRUCTION.
- APPLY TREATMENT TO GROUND SURFACES WITHIN THE DEFINED SCOPE OF WORK AS REQUIRED BY CODE AND LOCAL BUILDING INSPECTOR.
- SECTIONS AND DETAILS SHOWN AT LOCATIONS INDICATED ON PLAN ARE TYPICAL FOR OTHER SIMILAR CONDITIONS OF BUILDING EVEN IF NO SECTION CUT IS INDICATED AT A SIMILAR CONDITION. CONTRACTOR IS RESPONSIBLE FOR COORDINATION OF ALL DETAILS WITH OTHER TRADES, DISCIPLINES AND ALL SECTIONS AND DETAILS WITHIN STRUCTURAL DOCUMENTS. ALL SECTIONS AND DETAILS ARE NOT COMPLETE REPRESENTATIONS OF CONDITIONS BUT ARE SPECIFIC TO ITEMS INDICATED IN DETAIL. COORDINATION WITH VIEWS OF OTHER SECTIONS, PLANS AND DETAILS MAY BE REQUIRED TO COMPLETE ASSEMBLY.

SOIL EXCAVATION NOTES:

- EXCAVATION OF THE FOOTINGS ARE TO THE DEPTHS REQUIRED AND INDICATED ON PLANS. ANY OVER-EXCAVATION OF UNSUITABLE MATERIALS MAY BE NECESSARY BELOW FOOTING DEPTH. BACKFILL USING NO.57 STONE IN UNIFORM LIFTS COMPACTED TO 95% OF THE DRY DENSITY TO RE-ESTABLISH FOOTING SUB-GRADE.
- USE OF A SMOOTH EDGE BUCKET IS RECOMMENDED TO EXCAVATE FOR FOOTINGS. TOOTHED BUCKETS MAY ALLOW BEARING SOILS TO PERFORM INEFFECTIVELY AND ALLOW WATER TO SATURATE THE FOUNDATION SUB-GRADE.
- SOILS SHALL BE DETERMINED TO HAVE 2,000-PSF NET ALLOWABLE BEARING CAPACITY.
- FOOTINGS ARE TO BE PLACED WITH A MINIMUM DEPTH FROM FINISHED GRADE TO BEARING NOT LESS THAN 24 INCHES.
- THE CONTRACTOR IS RESPONSIBLE FOR MAINTAINING AND PROTECTING FOUNDATION BEARING SOILS FROM DISTURBANCE AND DAMAGE DURING CONSTRUCTION FROM OVER-SATURATION. CARE IS TO BE TAKEN TO REMOVE AND REPLACE BEARING SOILS WITH UNIFORM LIFTS OF NO.57 STONE AS NEEDED, COMPACTED TO 95% OF THE DRY DENSITY.
- ONCE THE FOOTINGS ARE ABLE TO HANDLE LATERAL LOADING, BACKFILL WITH ENGINEERED STONE OR NO.57 STONE IN UNIFORM LIFTS. EXTERIOR OF THE FOOTING MAY BE BACKFILLED WITH UNIFORM LIFTS OF SUITABLE SOILS COMPACTED TO 95% OF THE DRY DENSITY BEYOND THE PLACEMENT OF THE FOOTING DRAIN.
- A UNIFORM 6-IN. LIFT OF SUB-BASE, NO.57 STONE OR AN ENGINEERED APPROVED ALTERNATE STONE IS TO BE PLACED PRIOR TO ANY CONCRETE SLAB-ON-GRADE.
- A 6 MIL VAPOR BARRIER IS TO BE PLACED OVER THE ENTIRETY OF SUB-BASE, PRIOR TO PLACEMENT OF THE FLOOR INSULATION AND ANY CONCRETE SLAB ON GRADE.
- AREAS OF EXCAVATION MAY BE NECESSARY TO REMOVE UNSUITABLE MATERIALS PRIOR TO PLACING THE VAPOR BARRIER. EXCAVATE AND REPLACE UNSUITABLE SOILS WITH UNIFORM LIFTS OF NO.57 STONE COMPACTED TO 95% OF THE DRY DENSITY UP TO SUB-GRADE ELEVATION.

CONCRETE NOTES:

- CONCRETE CONSTRUCTION SHALL COMPLY WITH ACI 301 "SPECIFICATIONS FOR STRUCTURAL CONCRETE FOR BUILDINGS" (LATEST EDITION), ACI 318 "BUILDING CODE REQUIREMENTS FOR REINFORCED CONCRETE" (LATEST EDITION), AND ACI 302 "GUIDE FOR CONCRETE FLOOR AND SLAB CONSTRUCTION" (LATEST EDITION).
- REINFORCING STEEL SHALL BE FABRICATED AND PLACED IN COMPLIANCE WITH ACI 315 "DETAILS AND DETAILING OF CONCRETE REINFORCEMENT" (LATEST EDITION).
- MIX DESIGN SHALL BE IN ACCORDANCE WITH ACI 318 (CURRENT EDITION).
- MINIMUM CEMENT CONTENT = 500 LBS PER CUBIC YARD.
- CONCRETE SHALL BE NORMAL WEIGHT CONCRETE AND SHALL DEVELOP A MINIMUM COMPRESSIVE STRENGTH OF 3,000 PSI AT 28 DAYS.
- MAXIMUM SLUMP = 4" PLUS OR MINUS 1".
- THE MAX AGGREGATE SIZE SHALL BE 1".
- CONCRETE AGGREGATES SHALL COMPLY WITH ASTM C33 AND SHALL BE FREE OF CLAY, FOAM, LUMPS OR OTHER DELETERIOUS SUBSTANCES.
- REINFORCING BARS SHALL BE DEFORMED AND CONFORMING TO ASTM A615, GRADE 60.
- WELDED WIRE FABRIC SHALL CONFORM TO ASTM A306A AND BE SUPPLIED IN SHEETS, NOT ROLLS, UNDO.
- CONCRETE SHALL BE AIR ENTRAINED WITH 6% AVERAGE AIR CONENT WITH A 1.5% TOLERANCE. AIR ENTRAINMENT LAP SHALL COMPLY WITH ASTM C260.
- REINFORCEMENT LAP SPICES SHALL BE 44 TIME THE BAR DIAMETER UNLESS OTHERWISE NOTED.
- REINFORCEMENT COVER SHALL BE 3" WHEN POURED ADJACENT TO GROUND SURFACE AND 1.5" ELSEWHERE, UNDO.
- CONCRETE SHALL BE CONSOLIDATED USING CONCRETE VIBRATOR IN ACCORDANCE WITH 3039-05.

EPOXY ADHESIVE ANCHORS:

- ALL EPOXY SHALL BE SIMPSON BRAND "SET" EPOXY SYSTEM, OR APPROVED EQUAL, UNLESS NOTED OTHERWISE.
- EPOXY ADHESIVES TO BE INSTALLED IN STRICT ACCORDANCE WITH MANUFACTURER'S SPECIFICATIONS AND INSTRUCTIONS.
- ALL EPOXY ANCHOR BOLTS TO BE SIZED AS SHOWN IN NOTES/DETAILS AND SHALL CONFORM TO THE FOLLOWING ASTM STANDARDS:
  - ANCHOR BOLTS INTO FOUNDATION
    - ASTM F1554, GR 36
    - ALL OTHER APPLICATIONS, UNDO
  - ASTM A307
- ALL EPOXY ANCHOR BOLTS AND REBAR DOWELS SHOULD BE CLEAN AND OIL FREE.
- CONCRETE DUST SHALL BE REMOVED FROM ALL DRILLED HOLES BY USE OF A M1/ON BRUSH AND OIL FREE COMPRESSED AIR. CORRECT PROCEDURE INVOLVES BLOWING THE DUST OF THE HOLE, BRUSHING THE HOLE CLEAN, AND THEN BLOWING AGAIN.
- DRILLED HOLES SHOULD BE KEPT DRY AND ANY STANDING WATER MUST BE BLOWN OUT WITH OIL FREE COMPRESSED AIR PRIOR TO EPOXY INSTALLATION.
- EPOXY ADHESIVE SHOULD NOT BE INSTALLED IN CONCRETE WHICH IS LESS THAN 7 DAYS OLD.
- EPOXY ADHESIVES MUST BE ALLOWED THE FULL CURE TIME AS SPECIFIED BY THE MANUFACTURER PRIOR TO APPLICATION OF ANY LOAD AND ANCHOR BOLTS OR REBAR DOWELS MUST REMAIN UNDISTURBED DURING THIS SETTING PERIOD.
- EPOXY ADHESIVES ANCHORS ARE NOT TO BE USED EXCEPT WHERE SPECIFICALLY INDICATED ON PLANS.

GENERAL FRAMING DESIGN NOTES:

- FRAMING STANDARD: COMPLY WITH AIA&P'S "DETAILS FOR CONVENTIONAL WOOD FRAME 1 CONSTRUCTION," UNLESS OTHERWISE INDICATED.
- ALL EXTERIOR WALLS SHALL BE FRAMED WITH 2X6 STUDS SPACED AT 16" O/C, UNDO.
- USE SIMPSON A35 FRAMING ANGLES FOR TOP/SILL PLATE TO BLOCKING CONNECTION AT 16" O/C SPACING, UNDO.
- USE 5/8" DIAMETER ANCHOR BOLTS, 7" MIN. EMBEDMENT IN CONCRETE, 15" IN GROUTED CMU WITH SIMPSON BPSS/8-6 PLATE WASHER AT 16" O/C, UNDO.
- NAIL 2X BOTTOM PLATE TO RIM JOIST BELOW WITH 16D NAILS AT 4" O/C SPACING.
- FRAMING WITH ENGINEERED WOOD PRODUCTS: INSTALL ENGINEERED WOOD PRODUCTS TO COMPLY WITH MANUFACTURER'S WRITTEN INSTRUCTIONS.
- METAL FRAMING ANCHORS: INSTALL METAL FRAMING TO COMPLY WITH MANUFACTURER'S WRITTEN INSTRUCTIONS.
- DO NOT SPICE BUILT-UP BEAM MEMBERS BETWEEN SUPPORTS UNLESS OTHERWISE INDICATED. IF SPICE IS REQUIRED, SPICE ONLY ON THE MULTI-PLY BEAM AT ALLOWABLE LOCATIONS. ALLOWABLE LOCATIONS ARE AS FOLLOWS:
  - DIRECTLY CENTERED OVER SUPPORT
  - AT 20% OF THE SPAN LENGTH FROM INTERIOR SUPPORTS (POINT OF INFLECTION).
- WHERE BUILT-UP BEAMS OR GIRDERS OF 2-INCH DIMENSIONAL LUMBER ON EDGE ARE REQUIRED, FASTEN TOGETHER WITH 2 ROWS OF 16D NAILS SPACED NOT LESS THAN 16-INCHES O/C. LOCATED ONE ROW 1.5" FROM TOP EDGE AND ONE ROW 1.5" FROM BOTTOM EDGE.
- WHERE MULTI-PLY LVL BEAMS ARE REQUIRED, FASTEN TOGETHER WITH 2 ROWS OF FASTENMASTER FLATLOK STRUCTURAL WOOD SCREWS EACH ROW SPACED 16". USE 3.5" LONG FLATLOK SWS FOR 2-PLY LVL, USE 5" LONG FLATLOK SWS FOR 3-PLY LVL, USE 6.5" LONG FLATLOK SWS FOR 4-PLY LVL. LONGER SCREWS SHALL BE NECESSARY IF PLYWOOD OR OSB SPACERS ARE INSTALLED BETWEEN LVL PILES.
- FOR BUILT-UP (GANG) COLUMNS, USE FASTENMASTER FLATLOK SWS. SELECT LENGTH ADEQUATE TO FULLY PENETRATE EACH PLY IN A GANG COLUMN. SPACE VERTICALLY TWO ROWS OF FLATLOK SWS AT 8-INCH MAXIMUM.
- FLOOR-TO-FLOOR TIES: LAP EXTERIOR SHEATHING PANELS AT LEAST 24" ABOVE BOTTOM PLATE OR BELOW TO PLATE.

DIMENSIONAL LUMBER FRAMING NOTES:

- MAXIMUM MOISTURE CONTENT: 19 PERCENT.
- NO.2 GRADE OR BETTER AND ANY OF THE FOLLOWING SPECIES:
  - HEM-FIR (NORTH); NLGA.
  - SOUTHERN PINE; SPIB.
  - DOUGLAS FIR-LARCH; WCU/OB OR WVVA.
  - MIXED SOUTHERN PINE; SPIB.
  - SPRUCE-PINE-FIR; NLGA.
  - DOUGLAS FIR-SOUTH; WVPA.
  - DOUGLAS FIR-LARCH (NORTH); NLGA.
- EXTERIOR AND LOAD-BEARING WALLS: ANY SPECIES AND GRADE WITH A MODULUS OF ELASTICITY OF AT LEAST 1,300,000 PSI AND AN EXTREME FIBER STRESS IN BENDING OF AT LEAST 850 PSI FOR 2-INCH NOMINAL THICKNESS AND 12 INCH NOMINAL WIDTH FOR A SINGLE-MEMBER USE.
- JOIST RAFTERS, AND OTHER FRAMING NOT LISTED ABOVE: ANY SPECIES AND GRADE WITH A MODULUS OF AT LEAST 1,300,000 PSI AND EXTREME FIBER STRESS BENDING OF AT LEAST 850 PSI FOR 2 INCH NOMINAL THICKNESS AND 12 INCH NOMINAL WIDTH FOR SINGLE MEMBER.

FASTENERS NOTES:

- PROVIDE FASTENERS OF SIZE AND TYPE INDICATED THAT COMPLY WITH REQUIREMENTS, SPECIFIED IN THIS ARTICLE FOR MATERIAL AND MANUFACTURER.
- WHERE ROUGH CARPENTRY IS EXPOSED TO WEATHER, IN GROUND CONTACT, OR IN AREA OF HIGH RELATIVE HUMIDITY, PROVIDE FASTENERS WITH HOT-DIP ZINC COATING COMPLYING WITH ASTM A153 A153M.
- POWER DRIVEN FASTENERS: CABO-NER-272.
  - WOOD SCREWS: ASTM B18.6.1.
  - LAG BOLTS: ASME B18.2.1
  - BOLTS: STEEL BOLTS COMPLYING WITH ASTM A-307, GRADE A (ASTM F568M, PROPERTY CLASS 4.6); WITH ASTM A563 (ASTM A563M) HEX NUTS AND, WHERE INDICATED, FLAT WASHERS.
- EXPANSION ANCHORS: ANCHOR BOLTS AND SLEEVE ASSEMBLY OF MATERIAL INDICATED BELOW WITH CAPABILITY TO SUSTAIN, WITHOUT FAILING, A LOAD EQUAL TO 6 TIMES THE LOAD IMPOSED WHEN INSTALLED IN UNIT MASONRY ASSEMBLIES AND EQUAL TO 4 TIMES THE LOAD IMPOSED WHEN INSTALLED IN CONCRETE AS DETERMINED BY TESTING PER ASTM E488 CONDUCTED BY A QUALIFIED INDEPENDENT TESTING AND INSPECTING AGENCY.
- MATERIAL: CARBON-STEEL COMPONENTS, ZINC PLATED TO COMPLY WITH ASTM B622, CLASS FE/ZN 5.

ENGINEERED WOOD PRODUCTS NOTES:

- LAMINATED-VENEER LUMBER: STRUCTURAL COMPOSITE LUMBER MADE FROM WOOD VENEERS WITH GRAIN PRIMARILY PARALLEL TO MEMBER LENGTHS, EVALUATED AND MONITORED ACCORDING TO ASTM D5456 AND MANUFACTURED WITH AN EXTERIOR-TYPE ADHESIVE COMPLYING WITH ASTM D2559 AND CONTAINING NO UREA FORMALDEHYDE.
  - AVAILABLE MANUFACTURERS: SUBJECTS TO COMPLIANCE WITH REQUIREMENTS. MANUFACTURERS OFFERING PRODUCTS THAT MAY BE INCORPORATED INTO THE WORK INCLUDE, BUT ARE NOT LIMITED TO, THE FOLLOWING:
    - BOISE CASCADE CORPORATION
    - GEORGIA-PACIFIC
    - ILLINOISIANA-PACIFIC CORPORATION
    - ROSEBURG FOREST PRODUCTS CO.
    - WELD WOOD OF CANADA LIMITED; SUBSIDIARY OF INTERNATIONAL PAPER CORPORATION
    - WEYERHAEUSER COMPANY.
  - EXTREME FIBRE STRESS IN BENDING, EDGEWISE: 2250 PSI FOR 12-INCH NOMINAL DEPTH MEMBERS.
  - MODULUS OF ELASTICITY, EDGEWISE: 2,000,000 PSI.

- PARALLEL STRAND LUMBER: STRUCTURAL COMPOSITE LUMBER MADE FROM WOOD STRAND ELEMENTS WITH GRAIN PRIMARILY PARALLEL TO MEMBER LENGTHS, EVALUATED AND MONITORED ACCORDING TO ASTM D5456 AND MANUFACTURED WITH AN EXTERIOR-TYPE ADHESIVE COMPLYING WITH ASTM D2559 AND CONTAINING NO UREA FORMALDEHYDE.
  - AVAILABLE MANUFACTURERS: SUBJECT TO COMPLIANCE WITH REQUIREMENTS. MANUFACTURERS OFFERING PRODUCTS THAT MAY BE INCORPORATED INTO THE WORK INCLUDE, BUT ARE NOT LIMITED TO, THE FOLLOWING:
    - WEYERHAEUSER COMPANY.
  - EXTREME FIBER STRESS IN BENDING, EDGEWISE: 2900 PSI FOR 12-INCH NOMINAL DEPTH MEMBERS.
  - MODULUS OF ELASTICITY, EDGEWISE: 2,200,000 PSI.

METAL FRAMING ANCHORS NOTE:

- PROVIDE FRAMING ANCHORS OF STRUCTURAL CAPACITY, TYPE, AND SIZE INDICATED, AND MANUFACTURED BY SIMPSON STRONG-TIE COMPANY, INC.
- ALLOWABLE DESIGN LOADS: PROVIDE PRODUCTS WITH ALLOWABLE DESIGN LOADS, AS PUBLISHED BY MANUFACTURER THAT MEET OR EXCEED THOSE INDICATED. MANUFACTURER'S PUBLISHED VALUES SHALL BE DETERMINED FROM EMPIRICAL DATA OR BY RATIONAL ENGINEERING ANALYSIS AND DEMONSTRATED BY COMPREHENSIVE TESTING PERFORMED BY QUALIFIED INDEPENDENT TESTING AGENCY.
- EXPOSED METAL FRAMING CONNECTORS SHALL BE HOT-DIP, ZINC-COATED STEEL SHEET COMPLYING WITH ASTM A653/A653M, G60 (23RD) COATING DESIGNATION.
- BRIDGING: RIDGE, V-SECTION, NAILLESS TYPE, 0.062-INCH THICK, LENGTH TO SUIT JOISTS SIZE AND SPACING.
- HOLD-DOWNS: BRACKETS FOR BOLTING TO WALL STUDS AND SECURING TO FOUNDATION WALLS WITH ANCHOR BOLTS OR TO OTHER HOLD-DOWNS WITH THREADED RODS AND DESIGNED WITH FIRST OF TWO BOLTS PLACED SEVEN BOLT DIAMETERS FROM REINFORCED BASE, UNLESS NOTED OTHERWISE ON DRAWINGS.

WOOD-PRESERVATIVE-TREATED MATERIALS NOTES:

- PRESERVATIVE TREATMENT BY PRESSURE PROCESS: AWPA C2 (LUMBER) AND AWPA C9 (PLYWOOD), EXCEPT THAT LUMBER THAT IS NOT IN CONTACT WITH THE GROUND AND IS CONTINUOUSLY PROTECTED FROM LIQUID WATER MAY BE TREATED ACCORDING TO AWPA C31 WITH INORGANIC BORON (SBX).
- PRESERVATIVE CHEMICALS: ACCEPTABLE TO AUTHORITIES HAVING JURISDICTION AND ONE OF THE FOLLOWING:
  - CHROMATED COPPER ARSENATED (CCA).
  - AMMONIACAL COPPER ZINC ARSENATE (ACZA).
  - AMMONIACAL OR AMINE, COPPER QUAT (ACQ).
  - AMMONIACAL COPPER CITRATE (CC).
  - COPPER AZOLE, TYPE A (CBA-A).
- FOR EXPOSED ITEMS INDICATED TO RECEIVE A STAINED OR NATURAL FINISH, USE CHEMICAL FORMULATIONS THAT DO NOT REQUIRE INCISING, CONTACT COLORANTS, BLEED THROUGH, OR OTHERWISE ADVERSELY AFFECT FINISHES.
- KIL-DRY MATERIAL AFTER TREATMENT TO A MAXIMUM MOISTURE CONTENT OF 19 PERCENT FOR LUMBER AND 15 PERCENT FOR PLYWOOD. DO NOT USE MATERIAL THAT IS WARPED OR DOES NOT COMPLY WITH REQUIREMENTS FOR UNTREATED MATERIAL.
- MARK EACH TREATED ITEM WITH THE TREATMENT QUALITY MARK OF AN INSPECTION AGENCY APPROVED BY THE AMERICAN LUMBER STANDARDS COMMITTEE BOARD OF REVIEW.
- FOR EXPOSED LUMBER INDICATED TO RECEIVE A STAIN OR NATURAL FINISH, MARK END OR BEACK OF EACH PIECE.
  - TREAT ITEMS INDICATED ON DRAWINGS, AND THE FOLLOWING:
    - WOOD CANTS, NAILERS, CURBS, EQUIPMENT SUPPORT BASES, BLOCKING, STRIPPING, AND SIMILAR MEMBERS IN CONNECTION WITH ROOFING, FLASHING, VAPOR BARRIES, AND WATERPROOFING.
    - WOOD SILLS, SLEEPERS, BLOCKING, FURRING, STRIPPING, AND SIMILAR CONCEALED MEMBERS IN CONTACT WITH MASONRY OR CONCRETE.
    - WOOD FRAMING MEMBERS LESS THAN 18 INCHES ABOVE GRADE.
    - WOOD FLOOR PLATES THAT ARE INSTALLED OVER CONCRETE SLABS DIRECTLY IN CONTACT WITH EARTH.



Engineer:

ROCKY KNOB SHELTER

Location: 265 Mountain Bike Way  
Blowing Rock, NC 28605

Drawn By: DMK Date: 2-20-23

Review:  
Review 4-28-23  
Review 6-7-23  
Review 6-8-23  
Review 6-16-23  
Rev 1 7-21-23  
Rev 2 8-13-23  
Rev 3 10-6-23

Scale: Not to Scale

Sheet S1







REV 1 : 7.21.2023

Engineer:

## ROCKY KNOB SHELTER

Location: 285 Mountain Bike Way  
Boone, NC 28607

Drawn By: DMK Date: 2-20-23  
Review: 4-26-23  
Review: 6-7-23  
Review: 6-9-23  
Review: 6-16-23

Scale: Not to Scale

Sheet **S2**




## ROCKY KNOB SHELTER

**Location: 285 Mountain Bike Way  
Blowing Rock, NC 28605**

Scale:  $3/8" = 1'-0"$





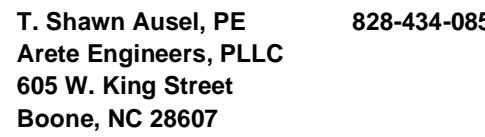


## ROCKY KNOB SHELTER

**Location: 285 Mountain Bike Way  
Boone, NC 28607**

|               |               |
|---------------|---------------|
| Drawn By: DMK | Date: 2-20-23 |
| Review:       |               |
| Review        | 4-26-23       |
| Review        | 6-7-23        |
| Review        | 6-9-23        |
| Review        | 6-16-23       |

Scale: 3/8" = 1'-0"

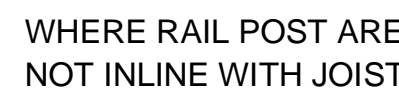Sheet **S4**
$$1'' = 1'-0''$$

$$1'' = 1' - 0'$$

$$1'' = 1' - 0$$






REV 1 : 7.21.2023

Engineer:


**ROCKY KNOB SHELTER**

Location: 285 Mountain Bike Way  
Boone, NC 28607


Drawn By: DMK Date: 2-20-23  
Review: 4-26-23  
Review: 6-7-23  
Review: 6-9-23  
Review: 6-16-23

Scale: 3/8" = 1'-0"


Sheet **S5**

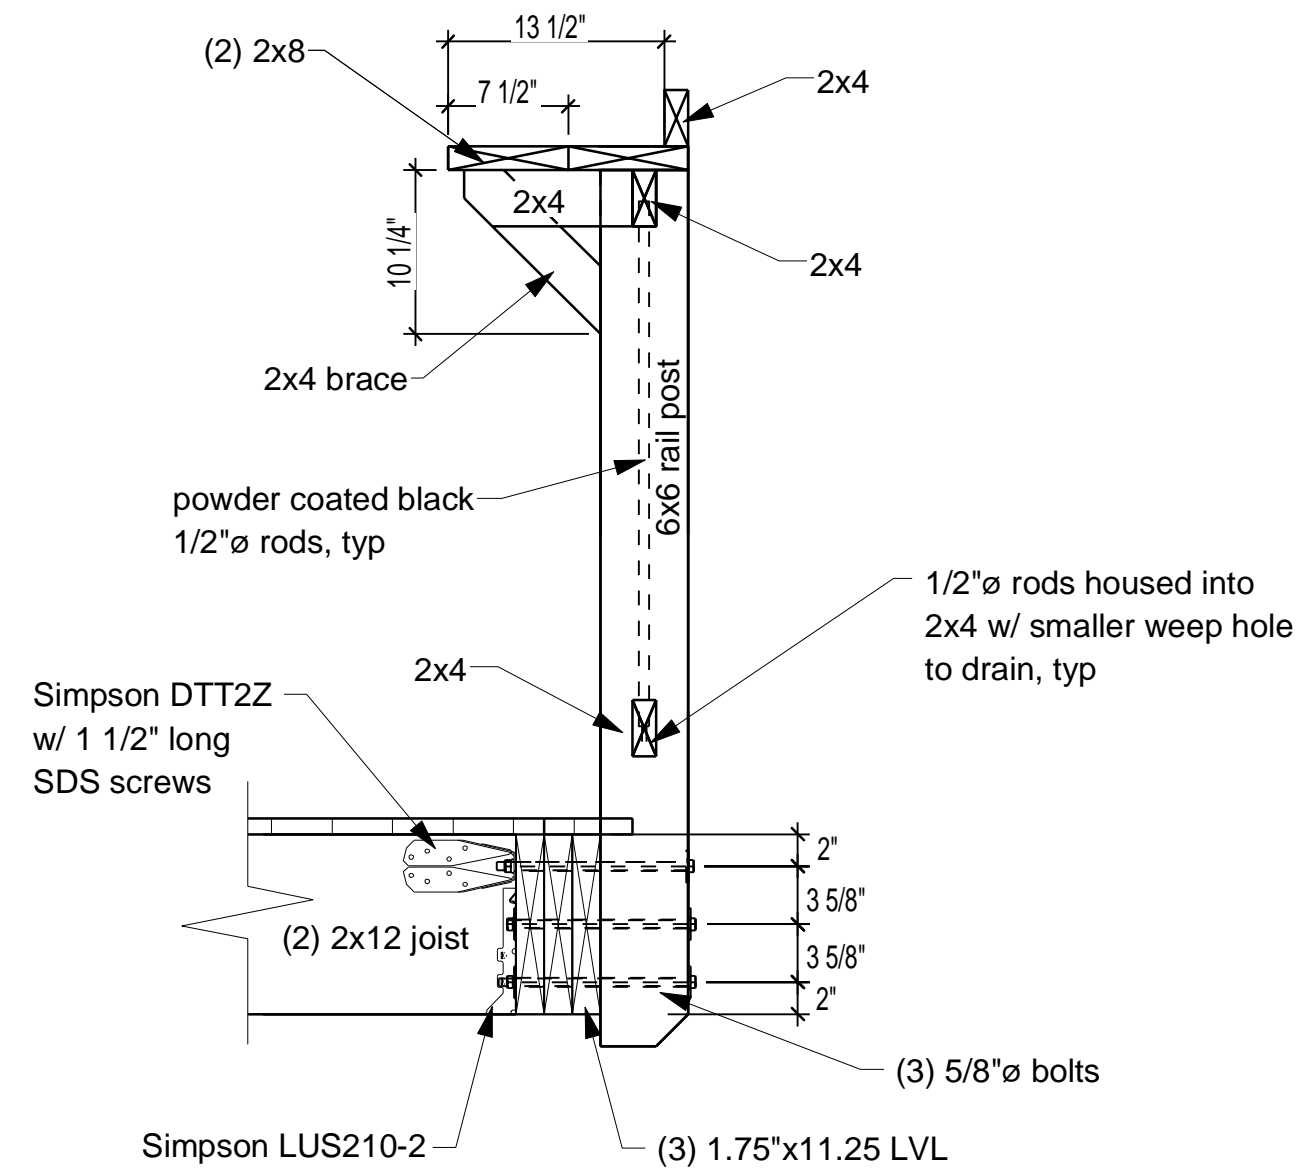

- NOTES:
- BAND BOARD/PICTURE FRAME = TREX SELECT WINCHESTER GREY
  - DECKING = TREX SELECT PEBBLE GREY
  - DECK BOARDS TO BE SECURED W/ HIDDEN FASTENERS
  - WHEN HIDDEN FASTENERS ARE NOT ABLE TO BE USED, SECURE DECKING BY FACE SCREWING. COUNTER SINK AND PLUG FACE SCREWS.

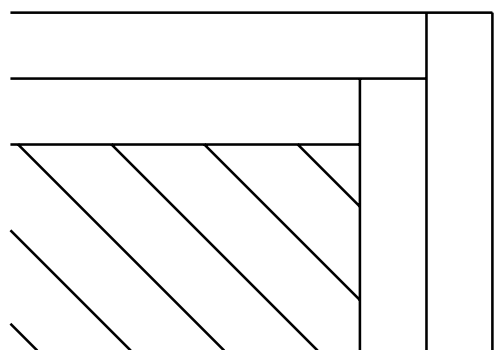

double band/picture frame  
corner detail

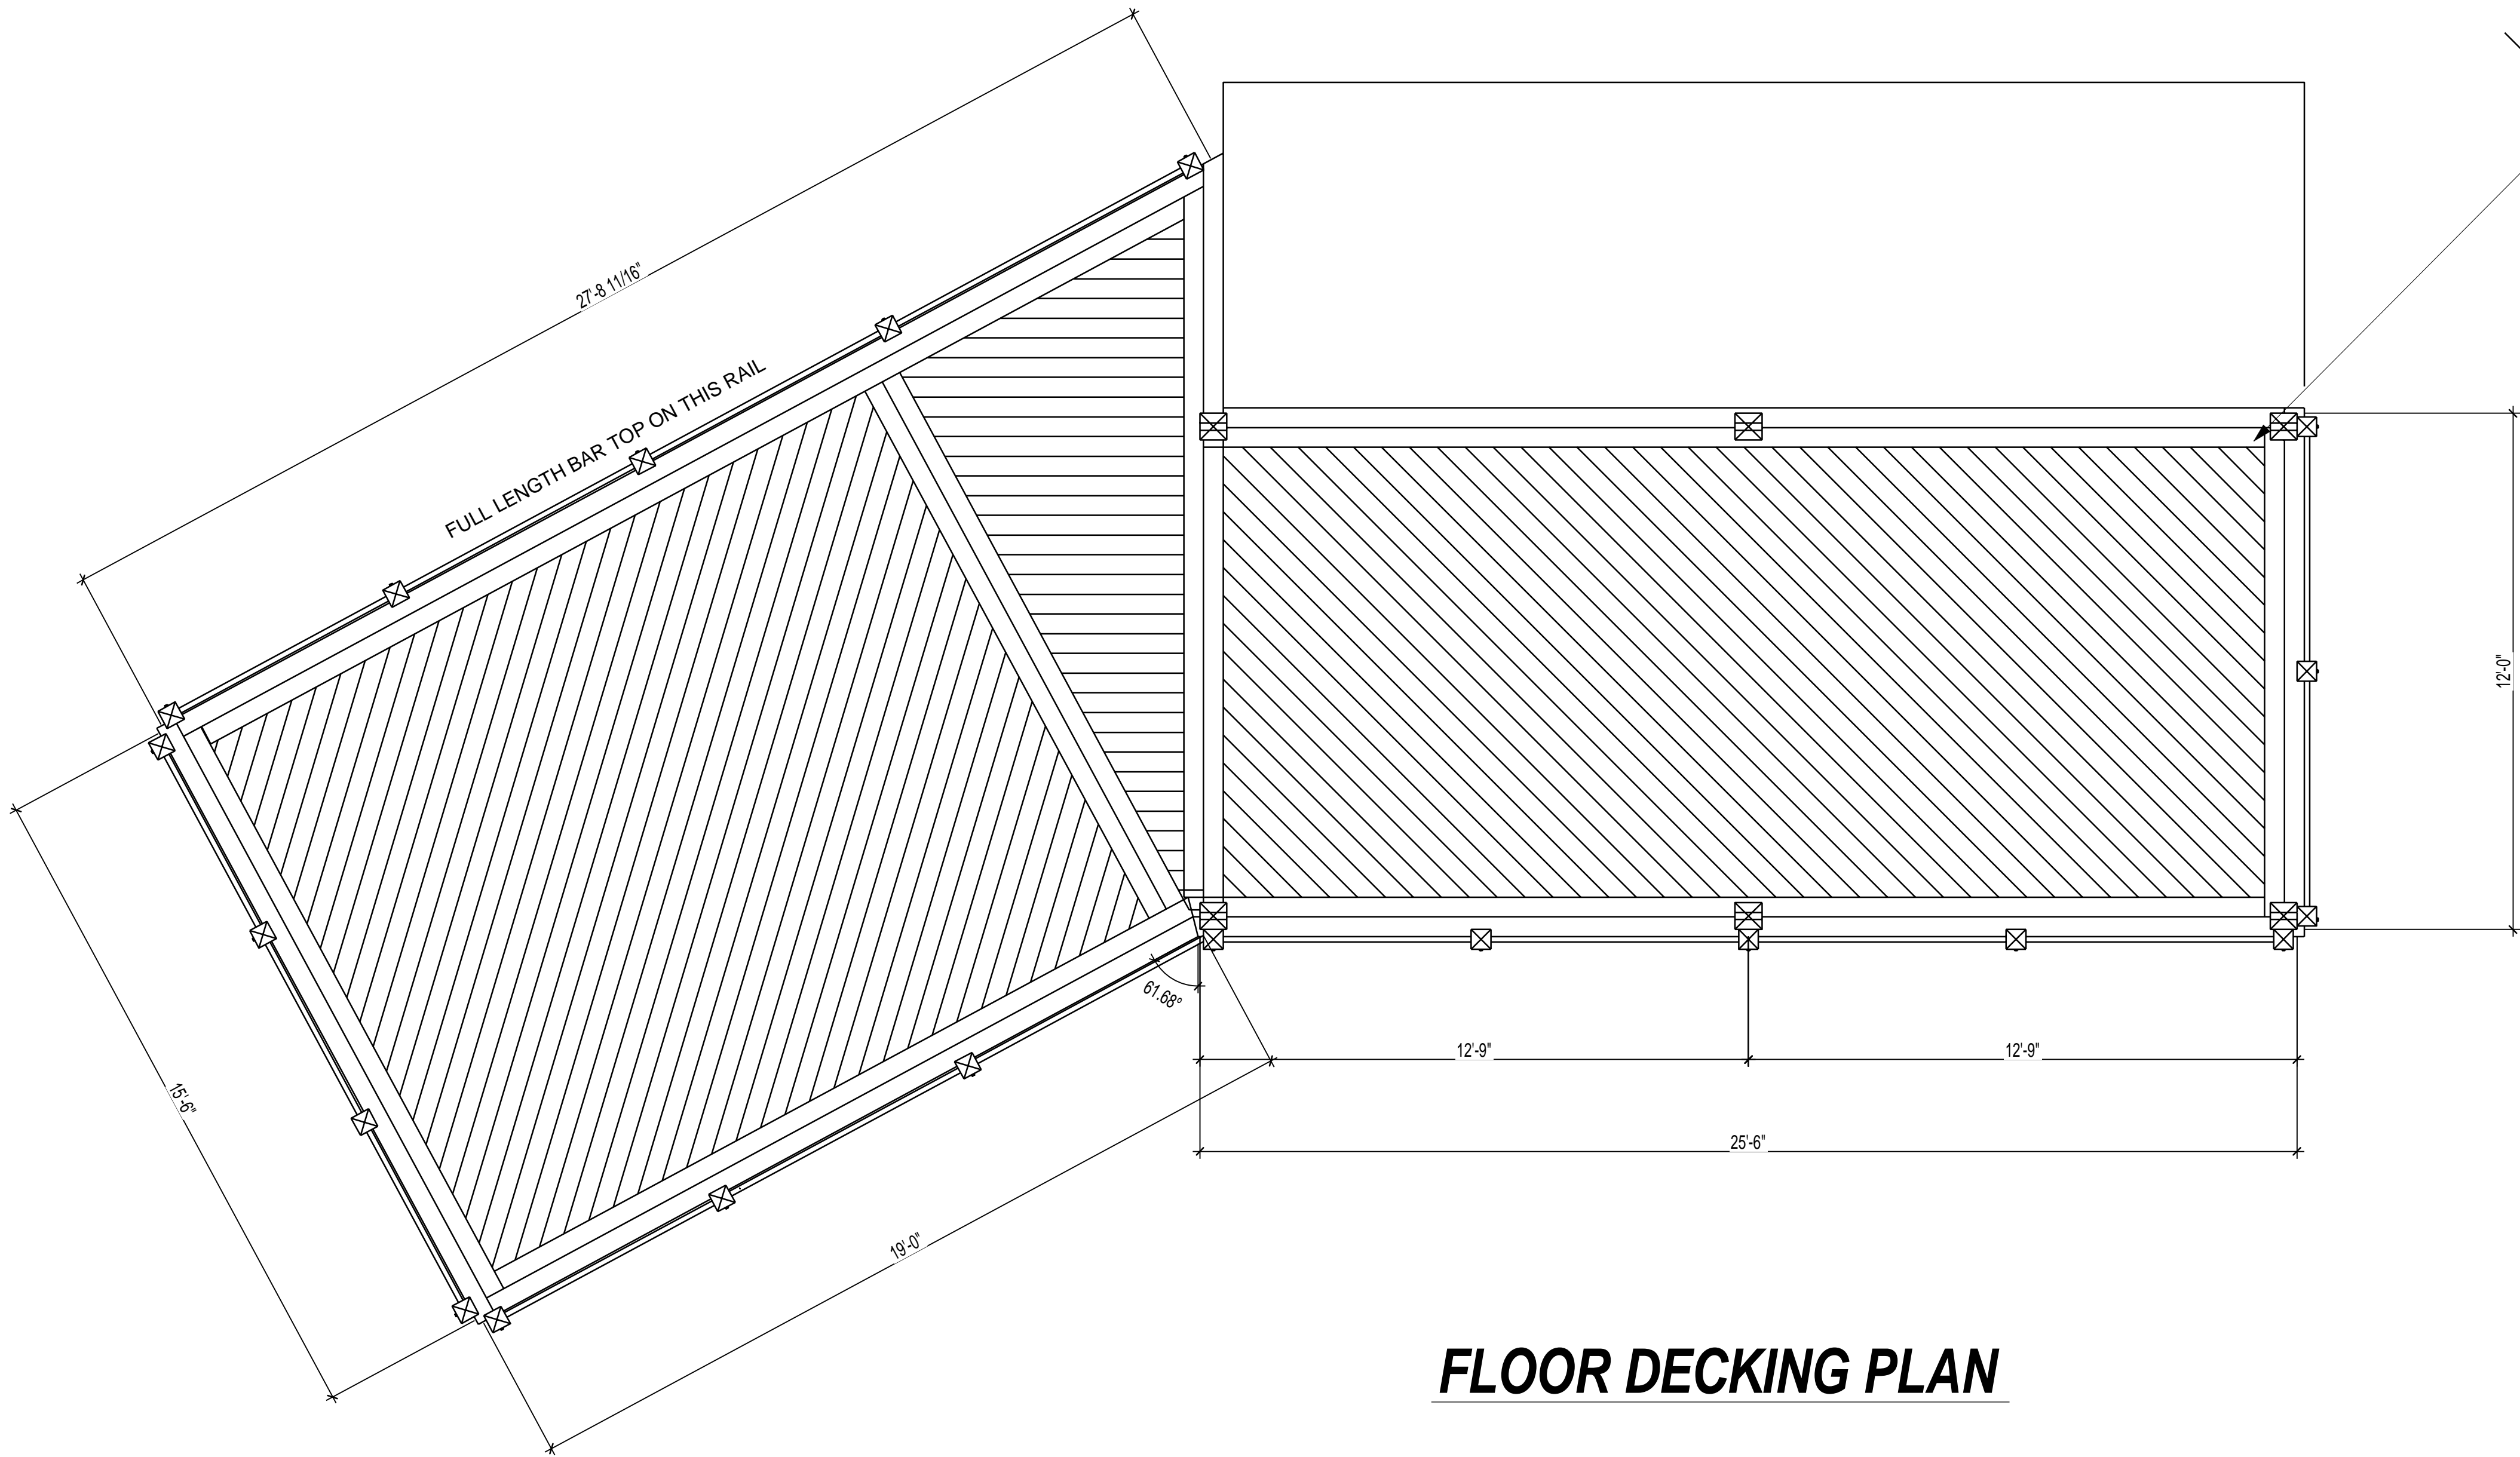

**FLOOR DECKING PLAN**

**7 DECK FRAMING BAR TOP DETAIL**

1" = 1'-0"





REV 1 : 7.21.2023

Engineer:


ROCKY KNOB SHELTER

Location: 285 Mountain Bike Way  
Boone, NC 28607

|           |     |       |         |
|-----------|-----|-------|---------|
| Drawn By: | DMK | Date: | 2-20-23 |
| Review:   |     |       |         |
| Review    |     |       | 4-26-23 |
| Review    |     |       | 6-7-23  |
| Review    |     |       | 6-9-23  |
| Review    |     |       | 6-16-23 |


Scale: 3/8" = 1'-0"

Sheet S6

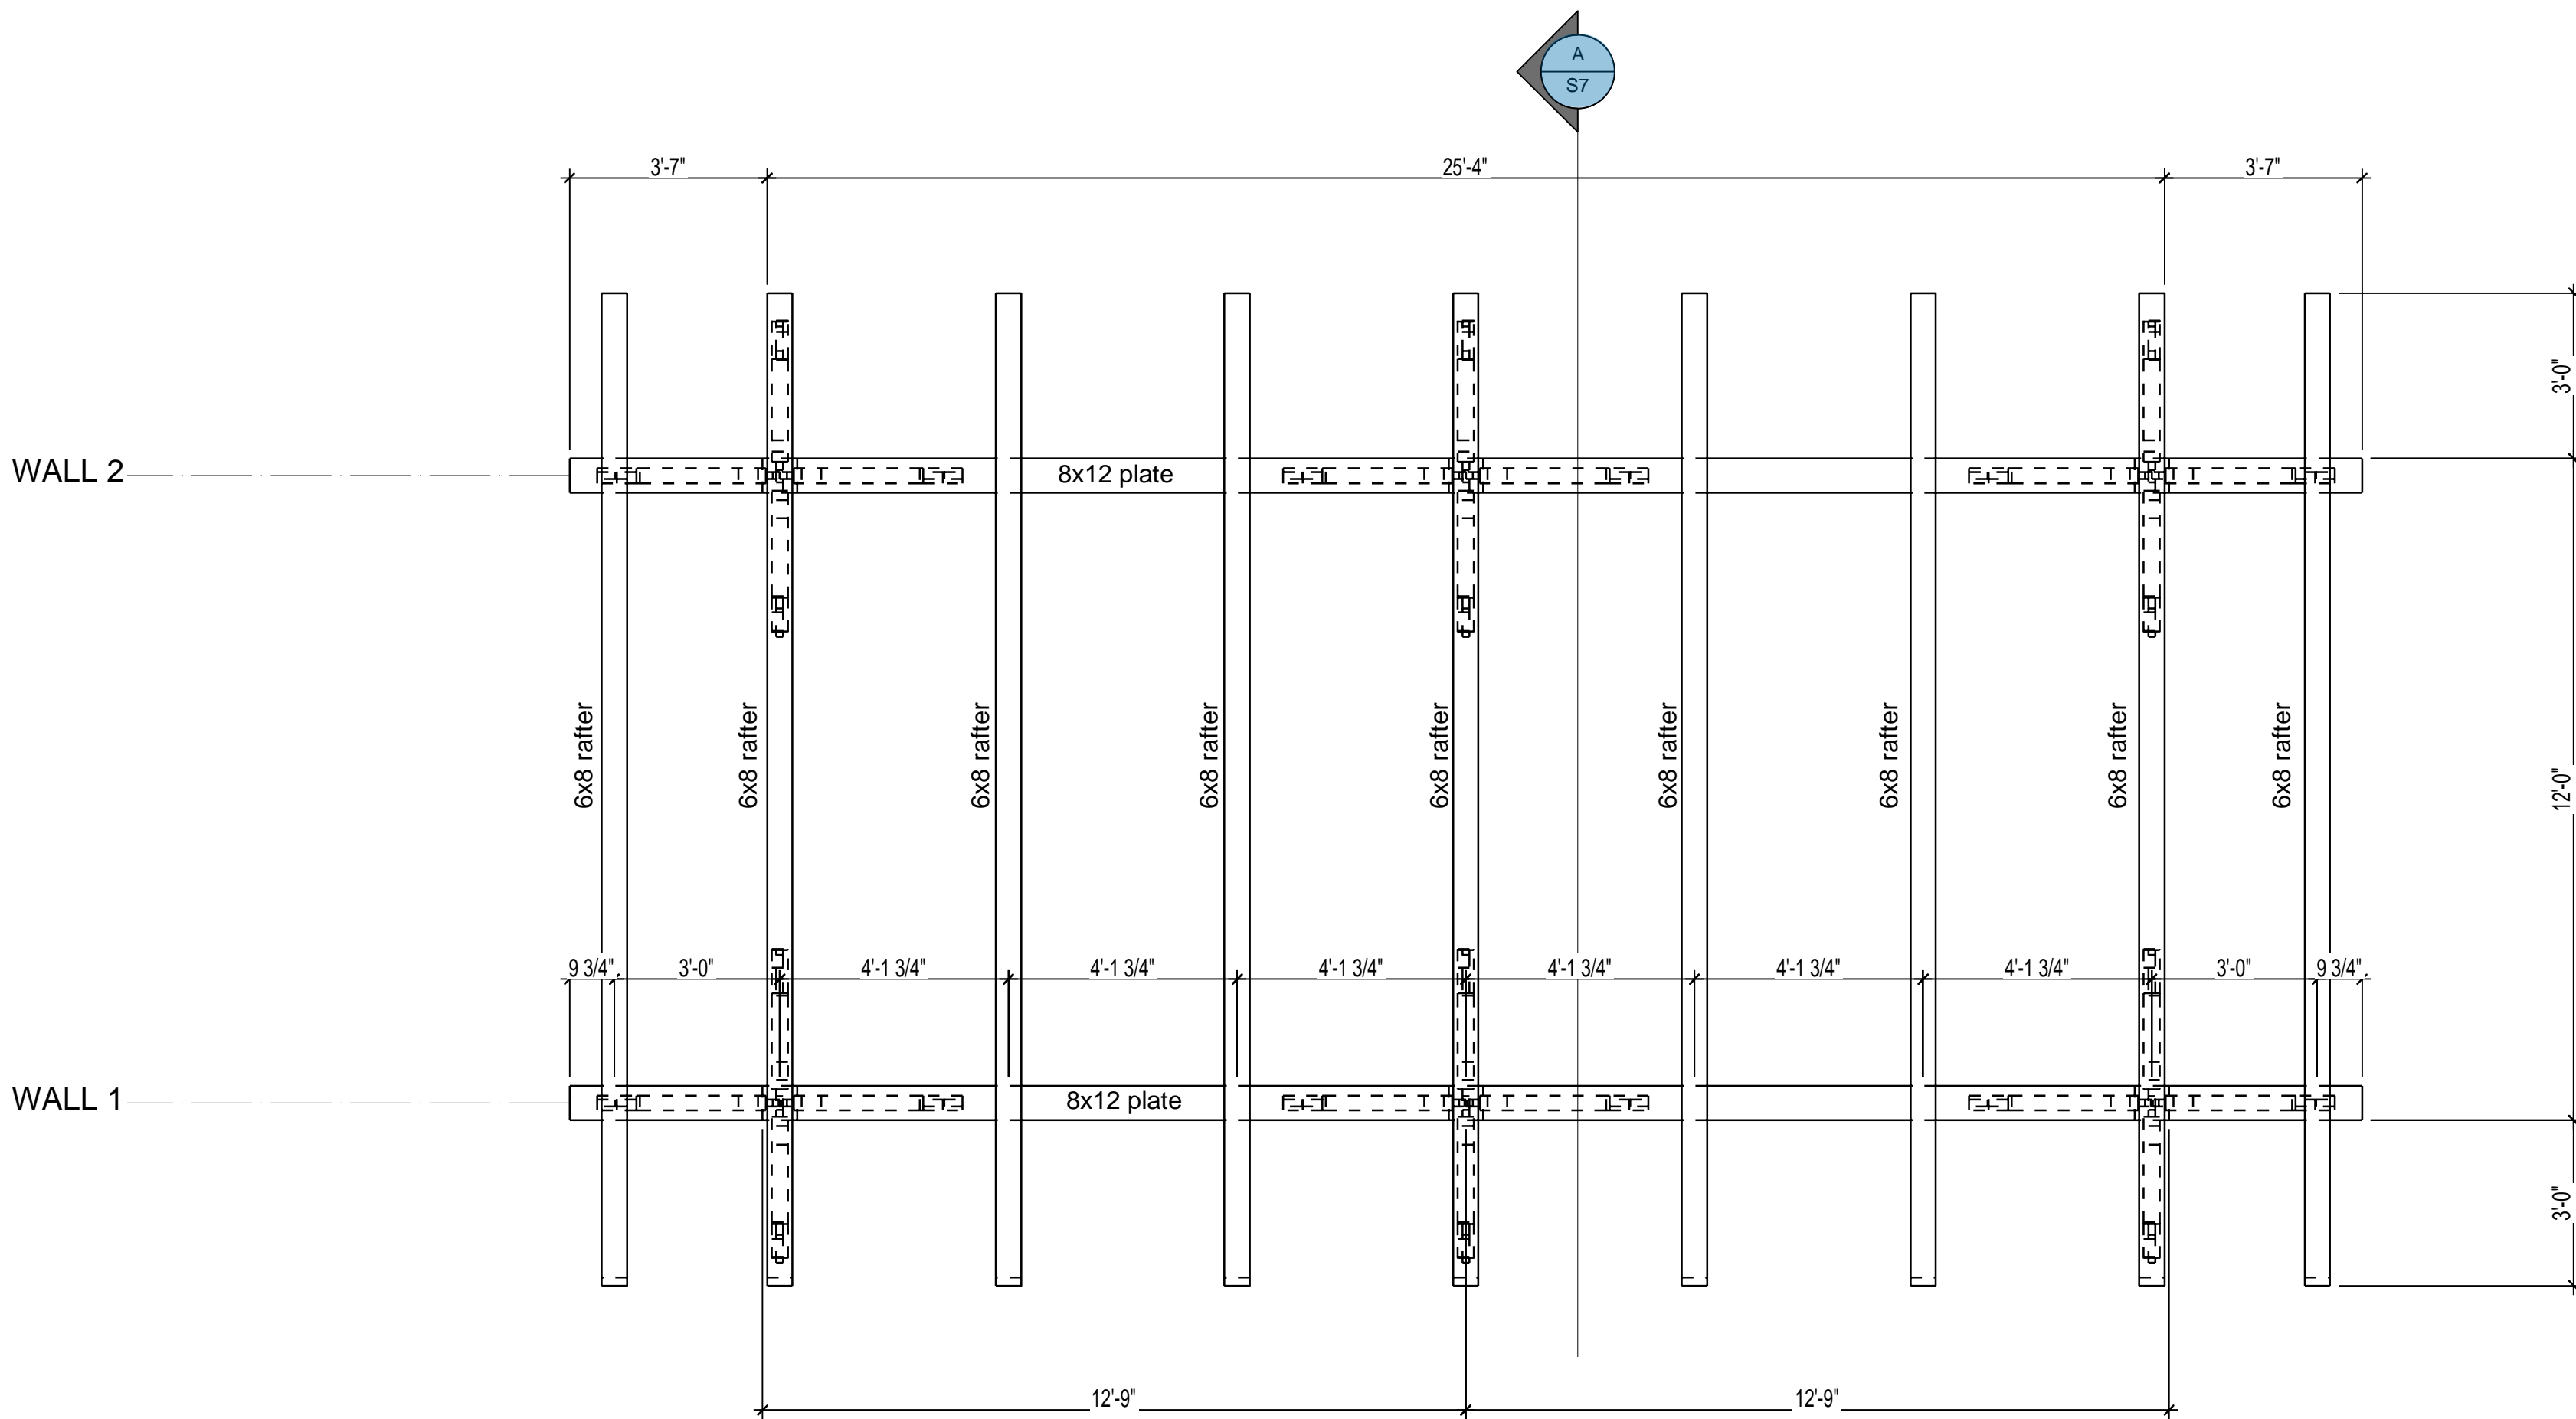


ROOF FRAMING PLAN



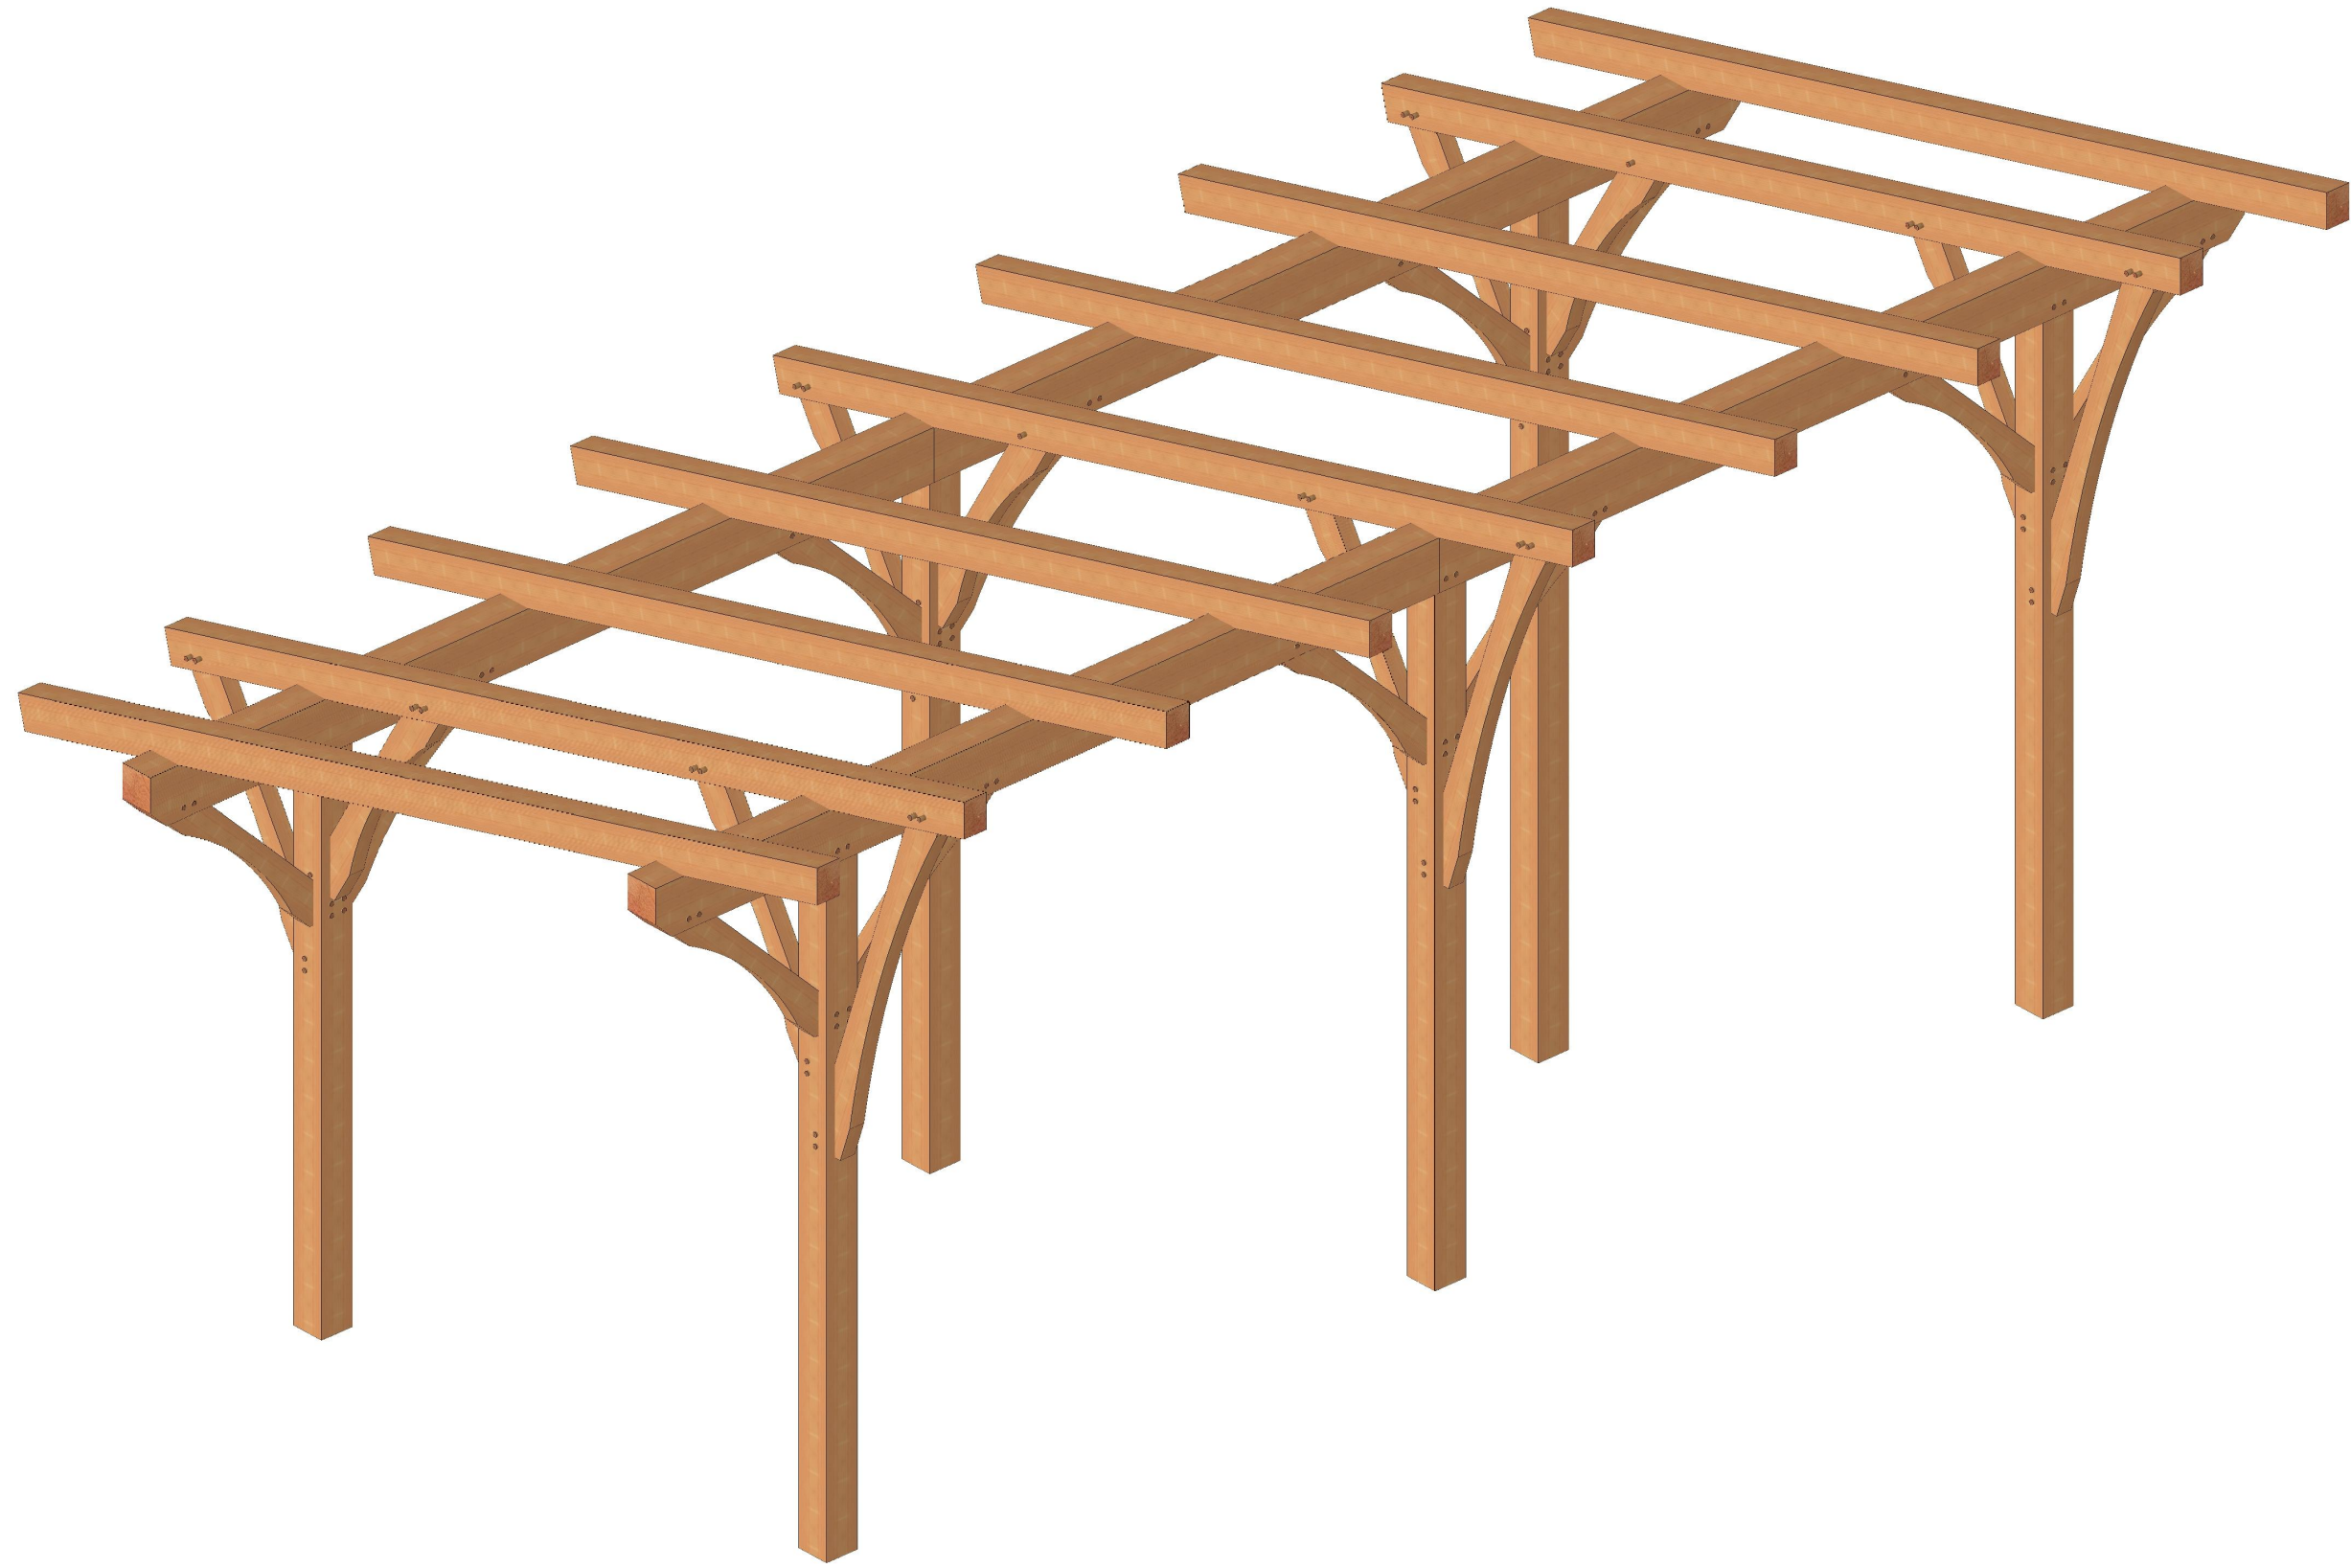

- NOTES:
- TIMBER FRAME TO BE DOUGLAS FIR #1 OR BETTER
  - ROOFING = STANDING SEAM METAL ROOF, GREY TO MATCH EXISTING WITH SYNTHETIC ROOFING UNDERLAYMENT (ICE AND WATER SHIELD), DRIP EDGE, RIDGE CAP, GABLE TRIM, FOAM ENCLOSURE STRIP
  - CONTRACTOR TO PROVIDE MIN. x2 COATS OF SIKKENS STAIN. COORDINATE WITH OWNER FOR COLOR.

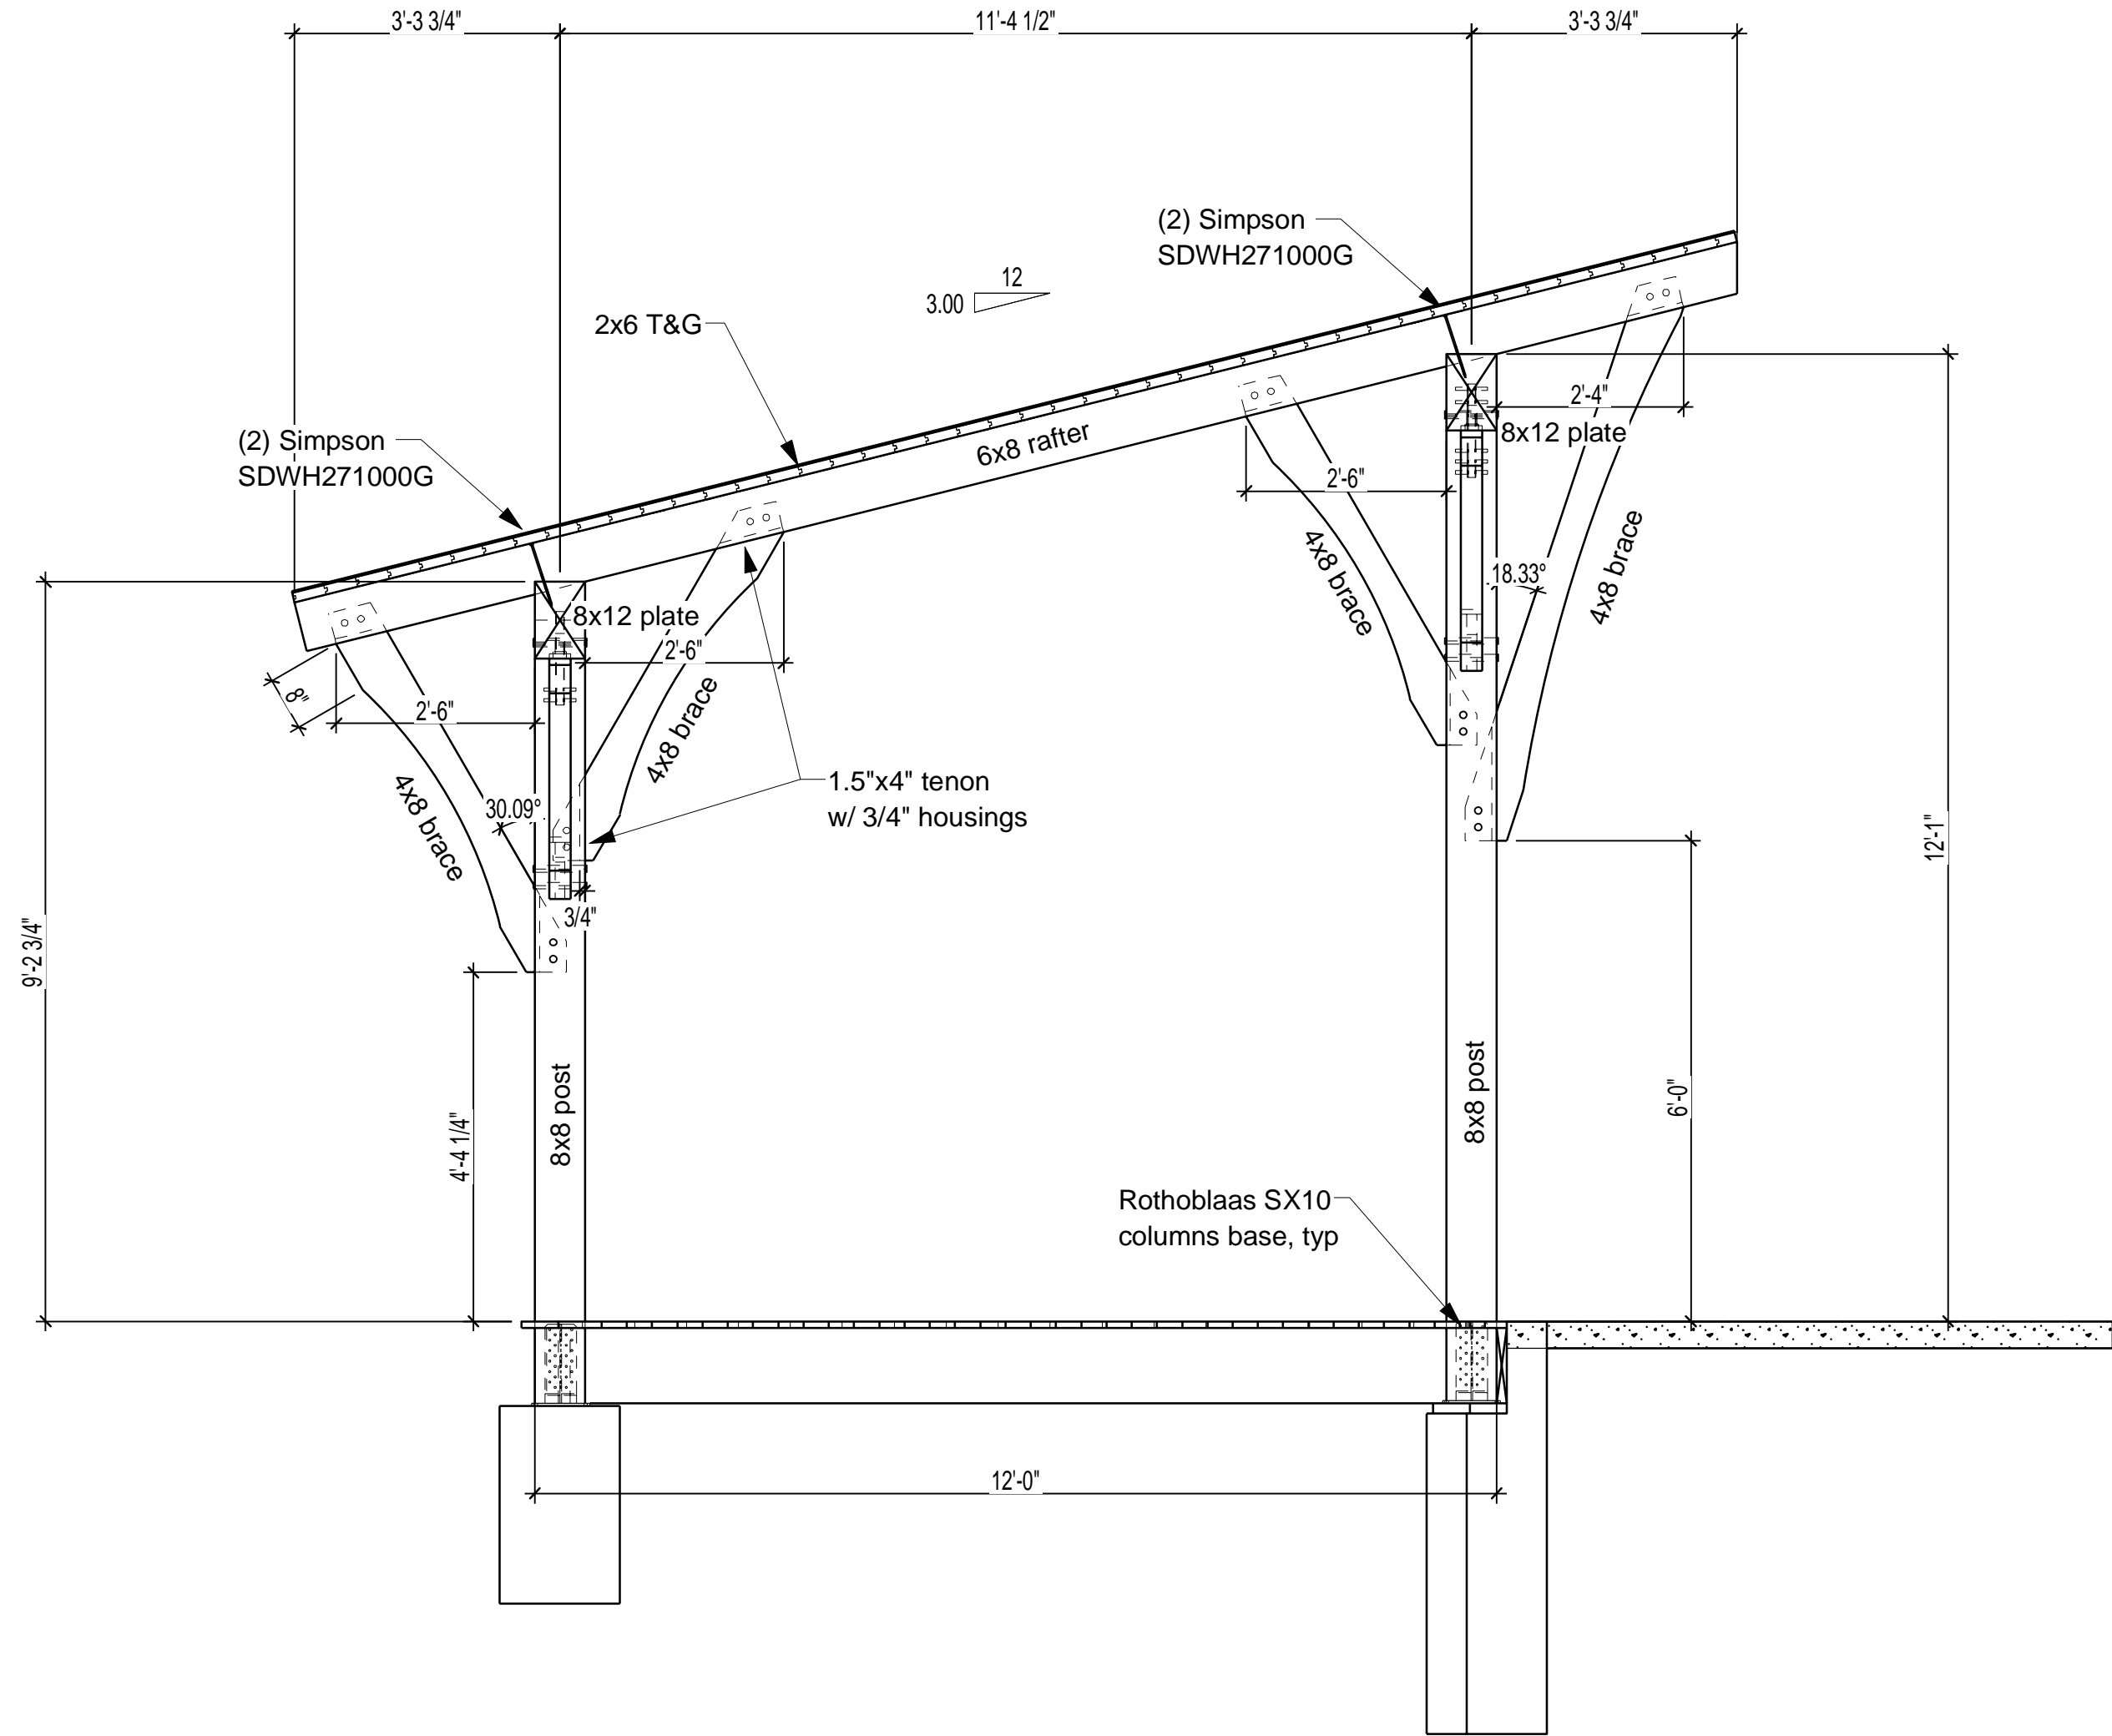

**A SIDE ELEVATION**



REV 1 : 7.21.2023

Engineer:

**ROCKY KNOB SHELTER**

Location: 285 Mountain Bike Way  
Boone, NC 28607

|           |     |       |         |
|-----------|-----|-------|---------|
| Drawn By: | DMK | Date: | 2-20-23 |
| Review:   |     |       |         |
| Review    |     |       | 4-26-23 |
| Review    |     |       | 6-7-23  |
| Review    |     |       | 6-9-23  |
| Review    |     |       | 6-16-23 |

Scale: 1/2" = 1'-0"

Sheet **S7**





REV 1 : 7.21.2023

Engineer:


## ROCKY KNOB SHELTER

Location: 285 Mountain Bike Way  
Boone, NC 28607


Drawn By: DMK Date: 2-20-23  
Review: 4-26-23  
Review: 6-7-23  
Review: 6-9-23  
Review: 6-16-23

Scale: 1/2" = 1'-0"


Sheet **S8**

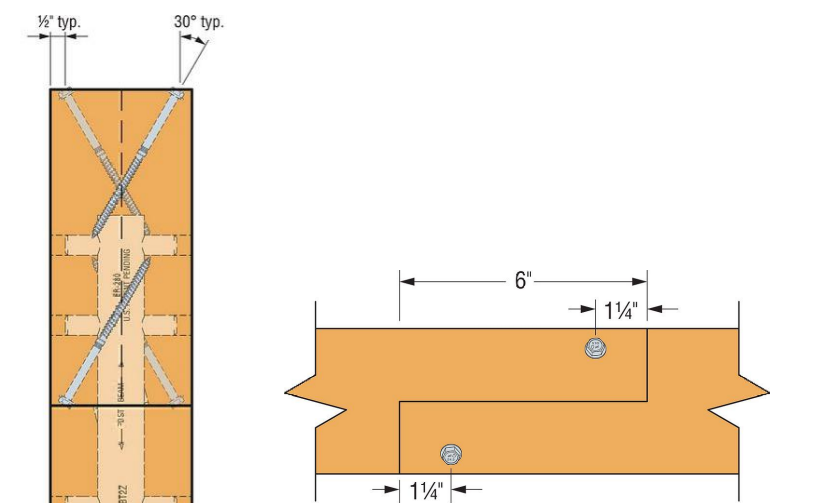


Install Simpson CBT4Z  
per Simpson requirements

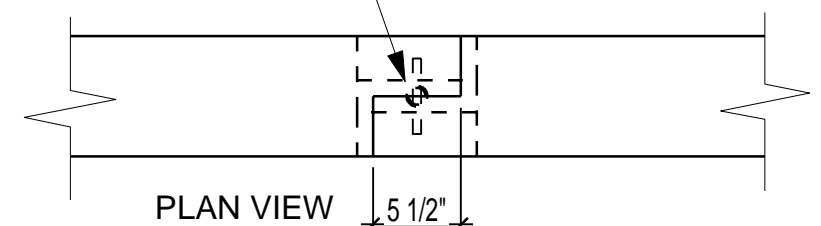


Half-lap joint  
w/ (2) 10" RSS

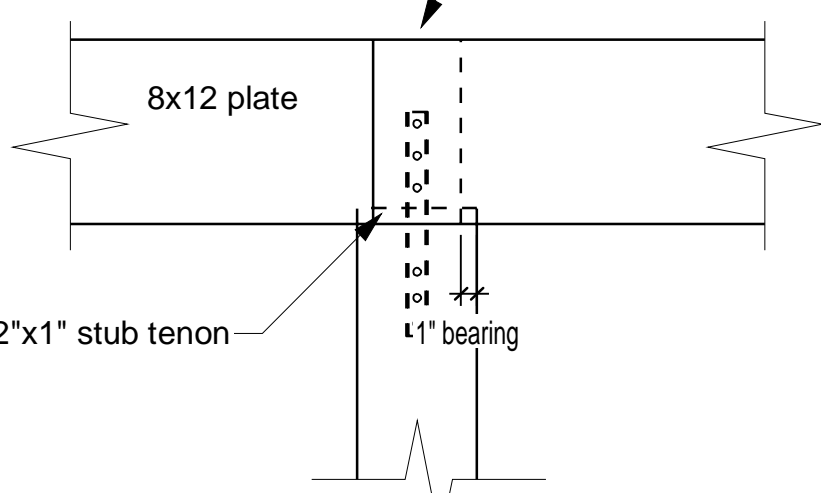

TOP PLATE CAN BE BROKEN AT  
CENTER POST W/ HALF-LAP JOINT  
IF DESIRED.

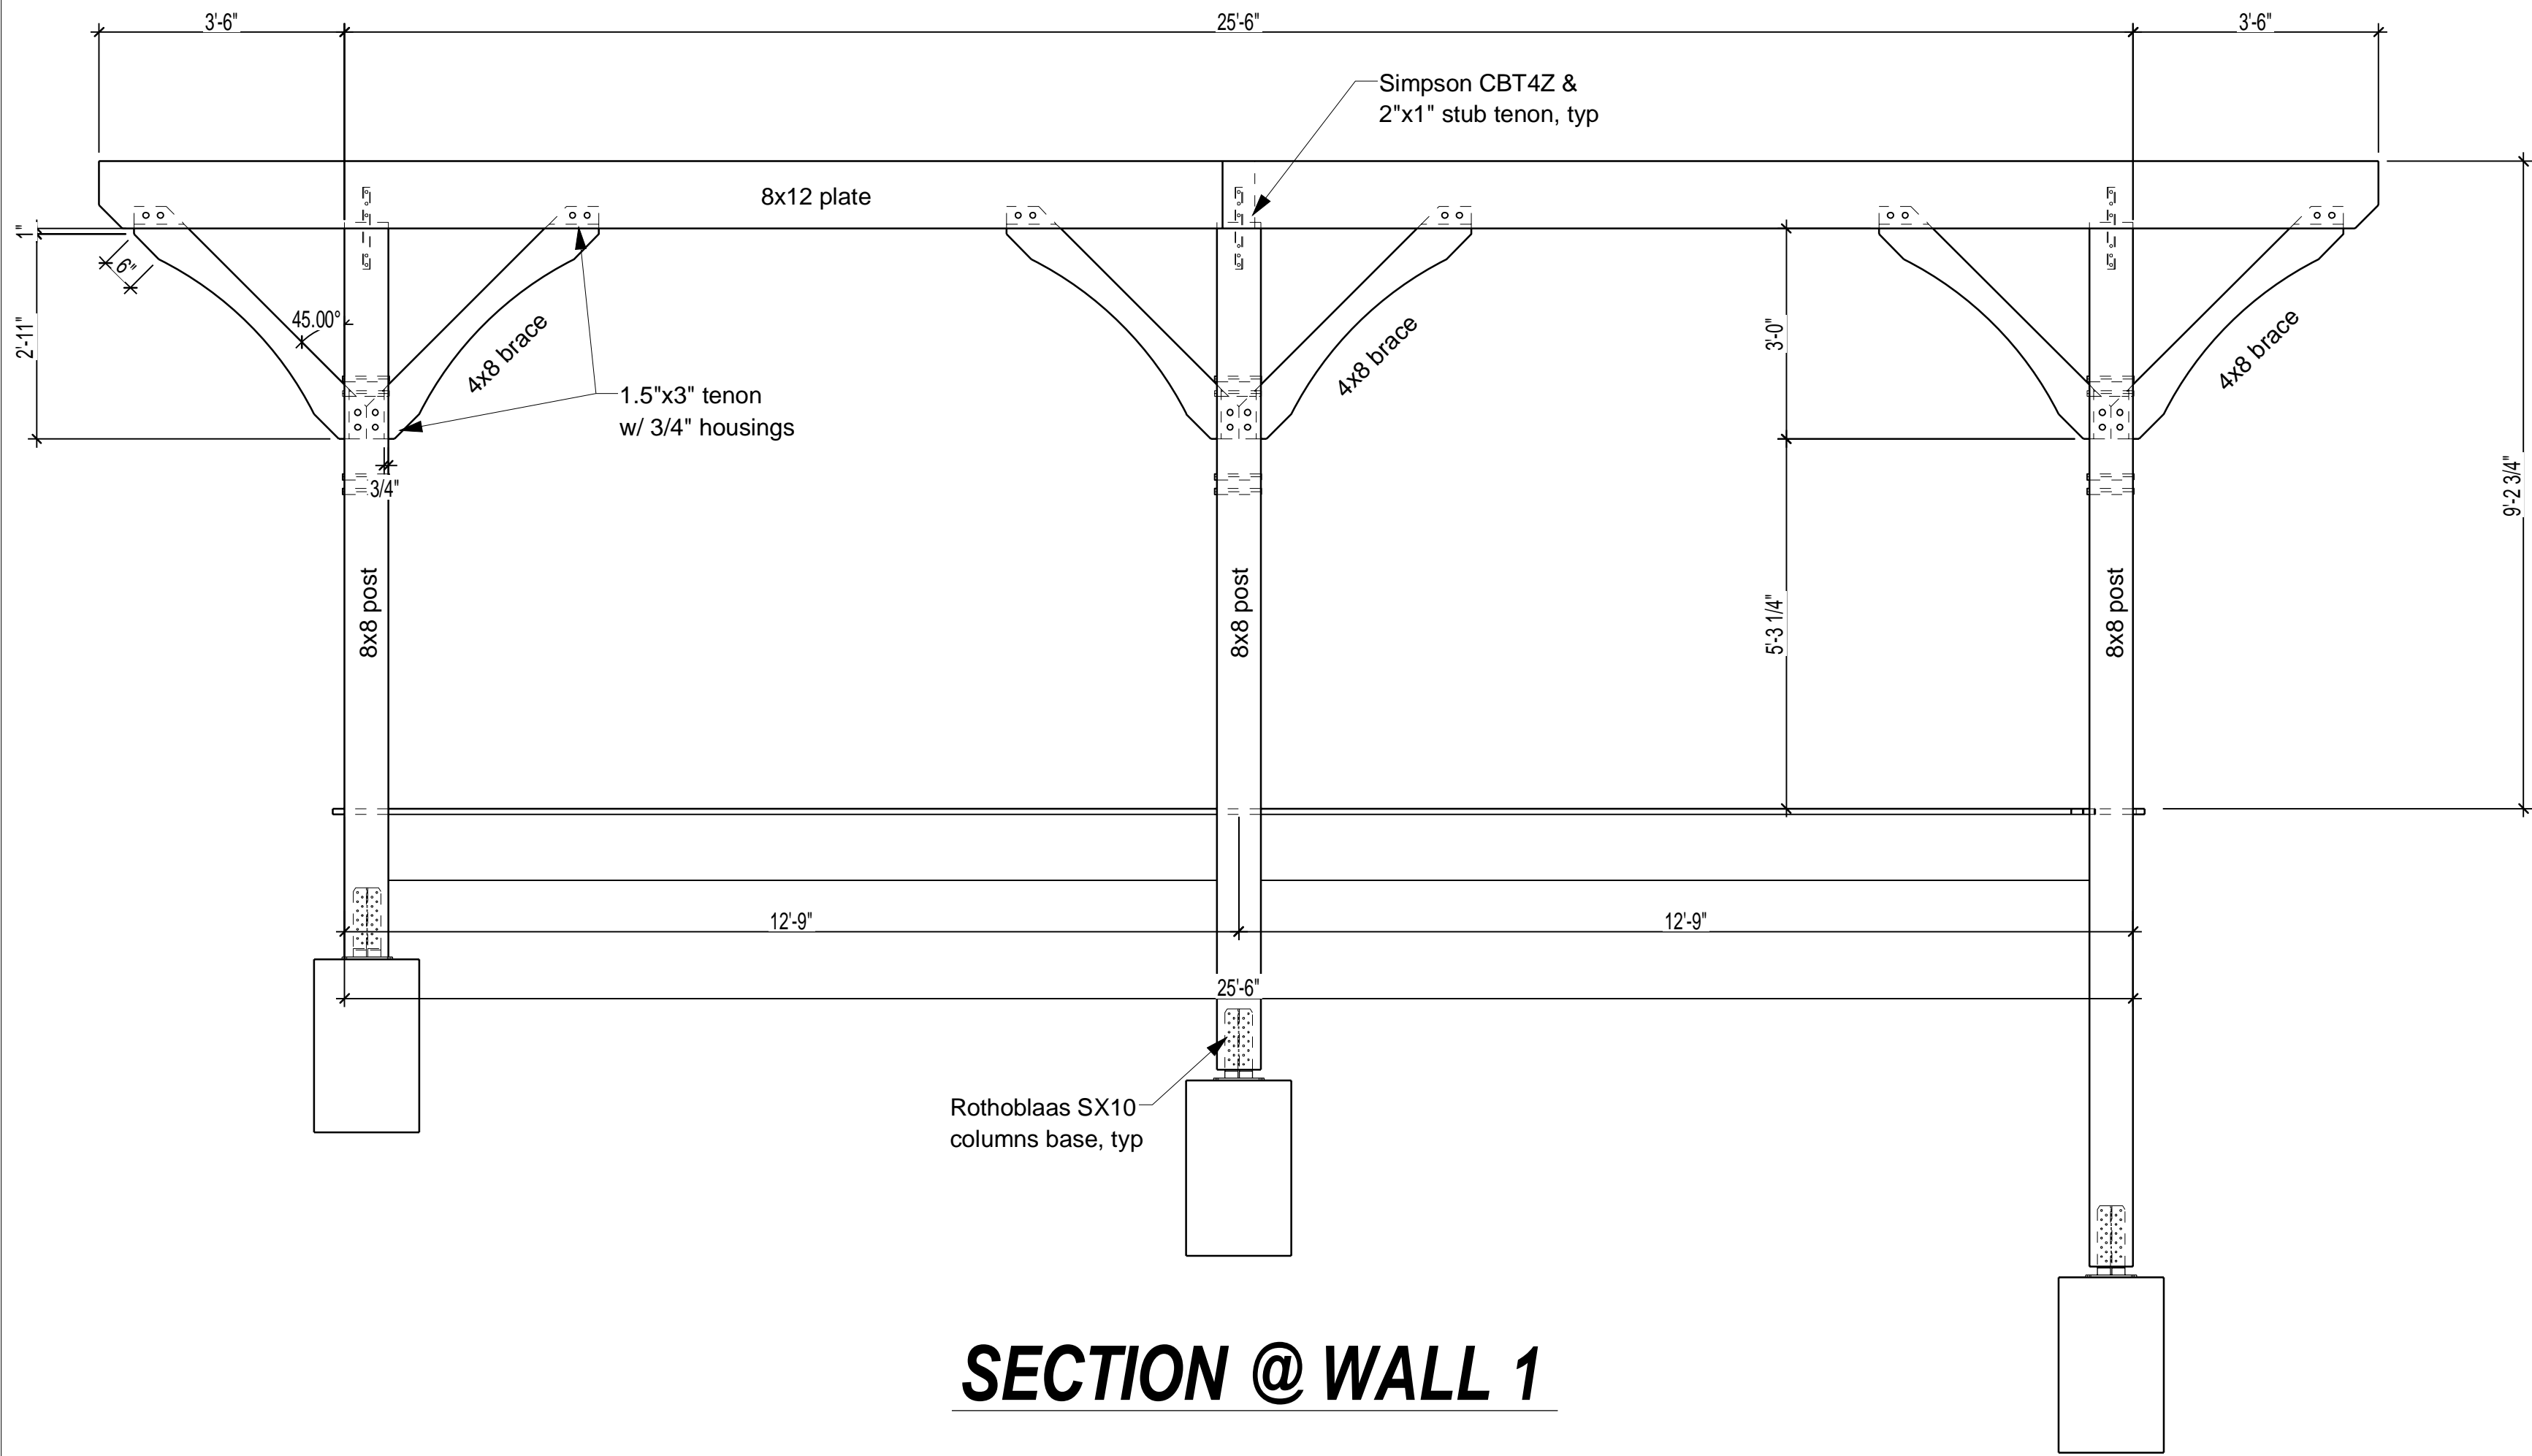

**SECTION @ WALL 1**

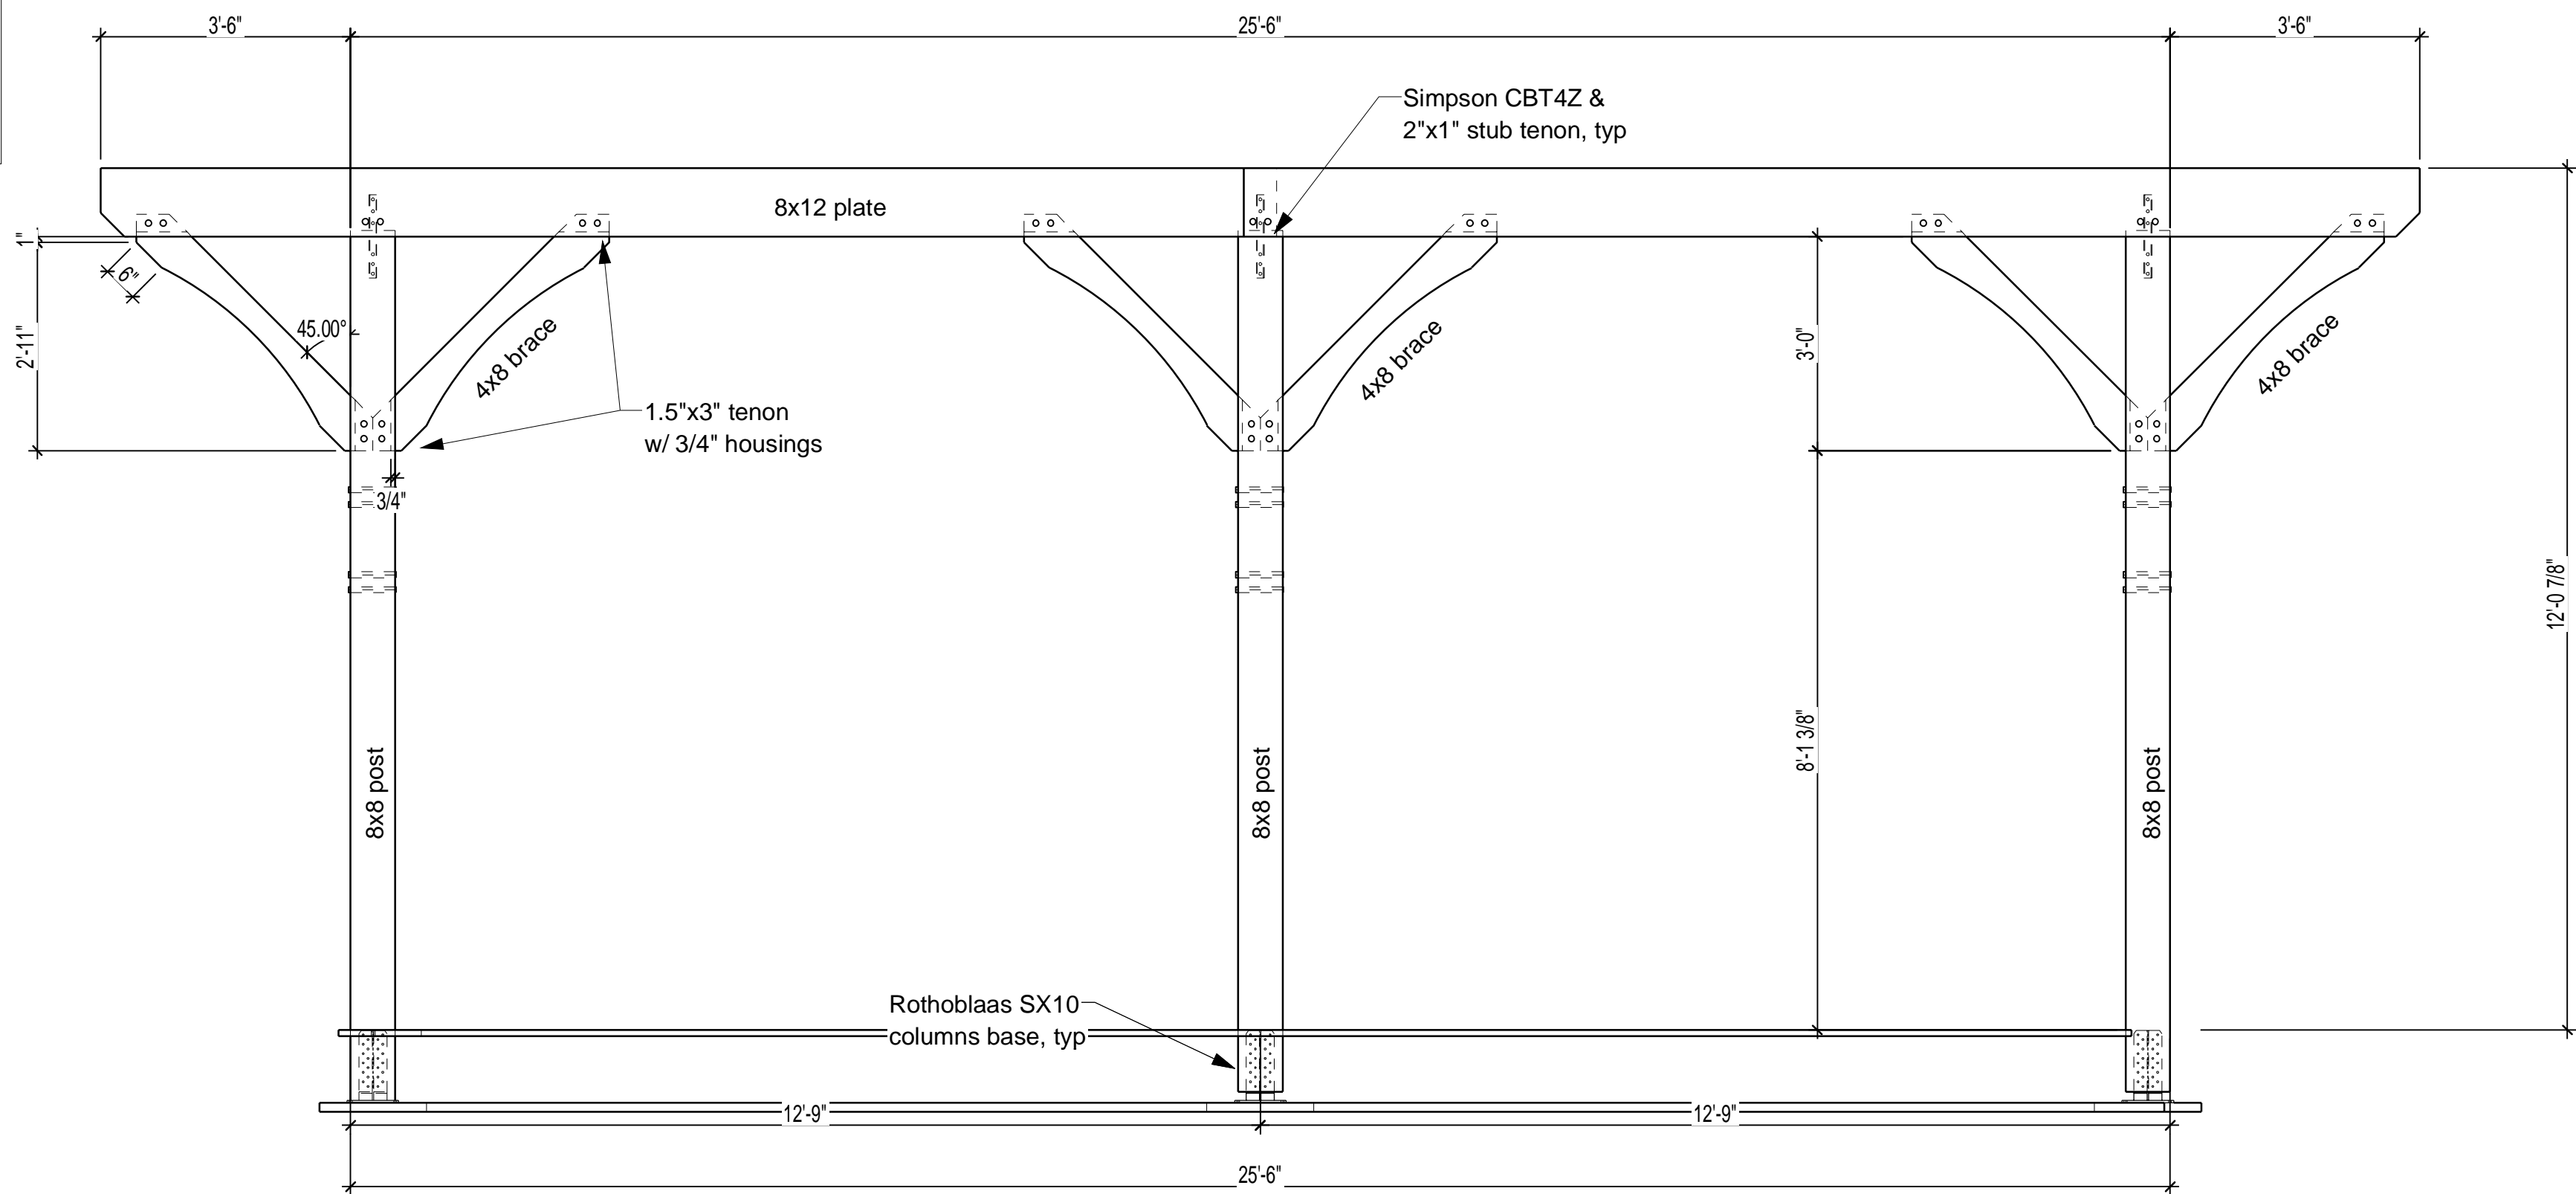

**SECTION @ WALL 2**



SHEET INDEX

SITE SERIES

- COVER SHEET
- SURVEY
- C-0 DEMOLITION PLAN
- C-1 SITE PLAN
- C-2 GRADING & DRAINAGE PLAN
- C-2.1 DRAINAGE PROFILES
- C-3 EROSION CONTROL PLAN
- C-4 MISC. CONSTRUCTION DETAILS
- C-4.1 MISC. CONSTRUCTION DETAILS
- C-5 EROSION CONTROL DETAILS
- C-6 DRAINAGE DETAILS
- L-1 LANDSCAPE PLAN
- L-2 PAVER ENLARGEMENT
- L-3 FURNISHINGS PLAN
- L-4 FENCE DETAILS

STRUCTURAL SERIES


- S1
- S2
- S3
- S4
- S5
- S6
- S7
- S8

SITE/CIVIL CONSTRUCTION DOCUMENTS FOR:  
ROCKY KNOB PARK



285 MOUNTAIN BIKE WAY, BOONE NC 28607

VICINITY MAP

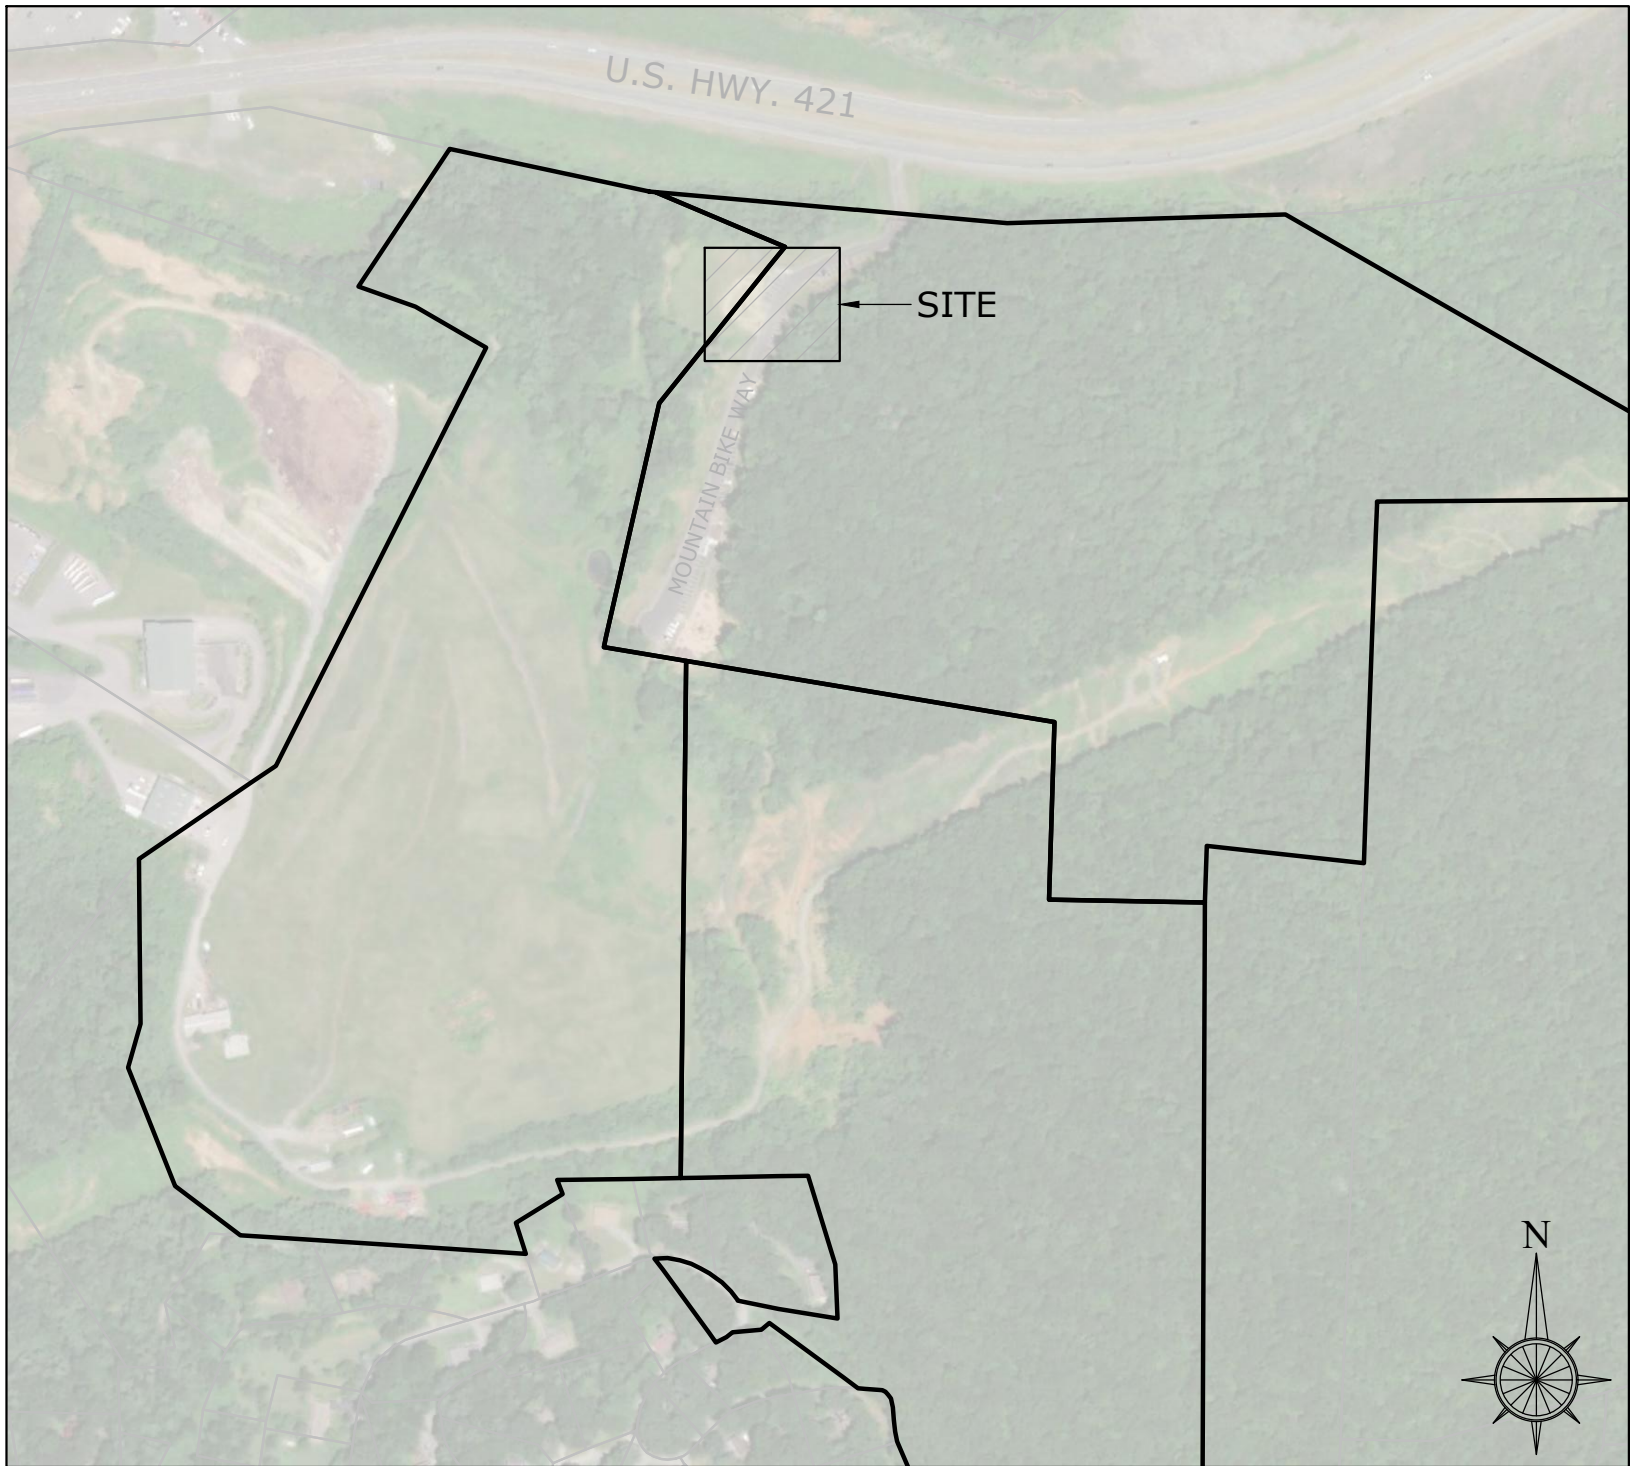

PREPARED BY:



PLANNING | ENGINEERING | COMMUNICATIONS

136 FURMAN ROAD, SUITE 6 BOONE, WATAUGA COUNTY, NC 28607  
(828)386-1866

DRAWING SETS

| NO. | DESCRIPTION:   | BY: | DATE:      |
|-----|----------------|-----|------------|
|     | ISSUED FOR BID | DBD | 09/01/2023 |
|     |                |     |            |
|     |                |     |            |



CLIENT

WATAUGA COUNTY TDA  
331 QUEEN STREET, SUITE 101  
BOONE, NC 28607  
(828)266-1345  
CONTACT: L. WRIGHT TILLEY,  
EXECUTIVE DIRECTOR



**LANDSCAPE ARCHITECT/PROJECT MANAGER**  
DESTINATION BY DESIGN STUDIOS, PLLC  
136 FURMAN ROAD, SUITE 6  
BOONE, NC 28607  
(828)386-1866  
CONTACT: ALEX GOTHERMAN, PLA  
(PROJECT MANAGER)



**CIVIL ENGINEER**  
DESTINATION BY DESIGN ENGINEERING  
136 FURMAN ROAD, SUITE 6  
BOONE, NC 28307  
(828)386-1866  
CONTACT: JASON GASTON, PE



**STRUCTURAL ENGINEER**  
ARETÉ ENGINEERS  
7668 VALLEY BOULEVARD  
BLOWING ROCK, NC 28605  
(828)434-0587  
CONTACT: BRIAN MULLEN, PE

**TIMBER FRAME STRUCTURE**  
SOJOURN TIMBER DESIGN, LLC  
301 FOUR HORSE LANE  
SUGAR GROVE, NC 28679  
(828)773-7040  
CONTACT: DANIEL KISER



BEGINNING  
Existing 5/8" Rebar  
located N 38°21'01" W 251.58' (GROUND)  
from GPS Control Point #2

NOTES:

- 1) This is a Topographic survey of a portion of the lands conveyed to Watauga County by deeds recorded in Book of Records 248 at page 146 and by deed recorded in Book of Records 1487 at page 851 (also see Plat Book 22 at page 36) all of the Watauga County Public Registry.
- 2) Bearings are relative to NCGS NAD '83 per GPS ties, see surveyors certificate.
- 3) All distances are horizontal measurements.
- 4) Elevations are based on NAVD '88 by ties to GPS control (see surveyors GPS certificate). Contour Interval is One Foot.
- 5) The ratio of precision of the unadjusted field traverse loop is not more than 1:10,000 and was adjusted by Least Squares (Star\*Net).
- 6) This parcel is located in a Zone "X" (an area outside the 0.2% annual chance of flooding) per the North Carolina Floodplain Mapping Program.
- 7) This property is not inside of a protected watershed per NCDENR GIS maps.
- 8) This plat reflects information discovered during the normal course of work and does not necessarily show every possible condition affecting the property. 811 was contacted for a utility locate. Orange markings were present to the south beyond the restrooms facilities (not shown on this map but approximately 450 feet south of the the picnic table shown hereon) leading towards the landfill property. No other markings were observed by surveyor in the subject area that was requested. Additional underground utilities may exist outside the subject area which are not shown hereon. The property may be subject to easements and/or rights of way of record not shown. Other easements, rights of way, building ordinances, zoning, and other legal encumbrances may also exist.
- 9) Reference was made to NCDOT Project 6.759003T Plans.
- 10) Revised November 9, 2022 to show new pump track area. Topographic Lines generated on November 9 are shown in legend. No additional field was performed outside this subject area.
- 11) Revised August 24, 2023 to add location of existing 18" CPP #2 as shown on prior survey by New River Land Surveying.

NC DOT  
BoR 378 pg 618  
Project 6.759003T

S 84°55'53" E 751.34'

To US HWY 421

existing concrete monument

approx. entrance sign (from aerial)

Mountain Bike Way

asphalt drive (this portion taken from aerial imagery)

GPS Control Point #1  
MagHub set  
N: 800.387222  
E: 1225.145.05  
Elevation: 3,239.75'

Watauga County  
BoR 1487 pg 851  
PB 22 pg 36

Watauga County  
Book of Records 248 Page 146

Drainage Pipe Inverts:

|            | Invert In "A" | Invert Out "B" |
|------------|---------------|----------------|
| 18" CPP #1 | 3,212.87'     | 3,206.75'      |
| 18" CPP #2 | 3,238.30'     | 3,228.35'      |
| 18" CPP #3 | 3,231.62'     | 3,217.09'      |
| 2" CPP #1  | 3,240.44'     | 3,188.16'      |
| 2" CPP #2  | 3,240.19'     | 3,217.89'      |

Surveyor's Certificate


I, Alexander W. Crowe, certify that this map was drawn under my supervision from an actual survey made under my supervision (deed description recorded in Book/Page: as noted or other reference source ) that the boundaries not surveyed are indicated as drawn from information in Book page or other reference source that the ratio of precision or positional accuracy is 1:10,000 and that this map meets the requirements of The Standards of Practice for Land Surveying in North Carolina (21 NCAC 56.1600) witness my original signature and seal this 24th day of August, 2023.

Surveyors GPS Certificate

I, Alexander W. Crowe, P.L.S., L-5337, certify that this map was drawn under my supervision and that the horizontal and vertical grid control was established from an actual GPS Survey made under my supervision and the following information was used to perform the survey:

- (1) Class of survey: Class A
- (2) Positional accuracy: Horizontal: 0.03' Vertical: 0.09'
- (3) Type of GPS field procedure: NC-VIS NETWORK
- (4) Dates of survey: 5/4/22 & 5/6/22
- (5) Datum/Epcy: NAD83(2011)EPOCH 2010.01001
- (6) Published/Fixed-control used: NC-VIS NETWORK

- (7) Geoid model: GEOID18
- (8) Combined grid factor: 0.9998566
- (9) Units: U.S. Survey Foot

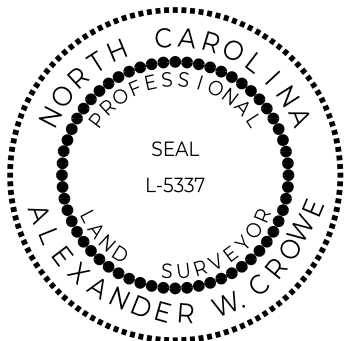


Alexander W. Crowe

Alexander W. Crowe, P.L.S. L-5337



1608 Highway 194 N, Boone, North Carolina 28607 ----- (828) 268-9779 License # P-2146

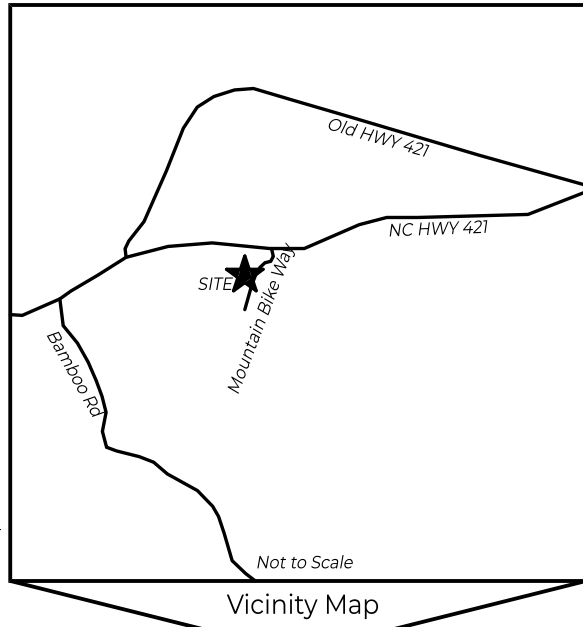

Legend


- Iron Found (as described)
- 5/8" Rebar Set (or as described)
- Computed Point (no iron set)
- Lines Surveyed
- Adjoiner Lines
- Right-of-Way
- Utility Lines
- Building Setback Lines
- River or Stream
- Minor Contours (1') (6/24/2022)
- Major Contours (5') (6/24/2022)
- Minor Contours (1') (11/9/2022)
- Major Contours (5') (11/9/2022)
- ▤ Yard Drain (typ)

Topographic Survey prepared for  
Watauga County District U  
Tourism Development Authority

New River Township ~ Watauga County  
North Carolina

June 24, 2022 (Original Topo)  
November 9, 2022 (New Topo Area)  
August 24, 2023 (Revision 1)

Scale is 1"=20' (1:240)

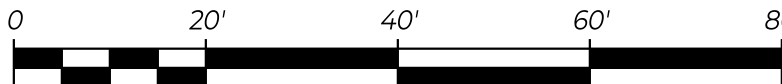

Contour Interval is One Foot

Job Number: 22057